

### **Design Team**

OWNER:
CNIB FOUNDATION
ADDRESS
CALGARY,AB T5K 1M1
PHONE: 800.563.2642

ARCHITECT:
S2 ARCHITECTURE
6th FLOOR, 220 - 12TH AVENUE SW
CALGARY, AB T2R 0E9
PHONE: 403.670.7000



**S2**ARCHITECTURE

CIVIL:

JUBILEE ENGINEERING CONSULTANTS LTD. 3702 EDMONTON TRAIL N.E. CALGARY, AB T2E 3P4 PHONE: 403.276.1001 LANDSCAPE:
818 STUDIO LTD.
1812 14A STREET SW.
CALGARY, AB T2T 3W6



EIGHT ONE EIGHT STUDIO

PHONE: 403.244.8188

ELECTRICAL:
NEMETZ (S/A) & ASSOCIATES LTD.
525 11TH AVENUE SW, SUITE 305
CALGARY, AB T2R 0C9

PHONE: 403.294.9027

**A** #

### **Drawing List**

ARCHITE	ECTURE	
DP0.00	COVER SHEET	
DP0.01	PROJECT STATISTICS	
DP0.02	SITE SURVEY	
DP0.03	SITE PHOTOS	
DP0.04	SITE CONTEXT PLAN	
DP0.05	SHADOW STUDY	

DP0.07 SITE DEMOLITION PLAN
DP0.08 LIMIT OF CONSTRUCTION DISTURBANCE

DP1.00 SITE PLAN

DP0.06 PHASING PLAN

DP1.01 FIRE ACCESS PLAN - PHASE 1
DP1.02 FIRE ACCESS PLAN - PHASE 2

DP1.03 VEHICULAR MOVEMENT PLAN\_PHASE 1
DP1.04 VEHICULAR MOVEMENT PLAN\_PHASE 2

DP1.05 SITE DETAILS

DP1.06 SITE DETAILS
DP1.07 SITE DETAILS

DP2.00 PARKADE LEVEL 1 - PHASE 1
DP2.01 PARKADE LEVEL 2 - PHASE 1

DP2.02 PARKADE LEVEL 1 - PHASE 2

DP2.03 PARKADE LEVEL 2 - PHASE 2
DP2.04 BUILDING 1 - MAIN LEVEL FLOOR PLAN

DP2.05 BUILDING 1 - LEVELS 2 THRU 6
DP2.06 BUILDING 1 - LEVELS 7 THRU 21 FLOOR PLAN

DP2.07 BUILDING 1 - LEVELS 22 THRU 26 FLOOR PLAN
DP2.08 BUILDING 1 - PENTHOUSE FLOOR PLAN LEVEL 27

DP2.09 BUILDING 1 - MECHANICAL ROOM/ROOF PLAN
DP2.10 BUILDING 2 - MAIN LEVEL FLOOR PLAN

DP2.11 BUILDING 2 - LEVEL 2 FLOOR PLAN

DP2.12 BUILDING 2 - LEVEL 3-17 FLOOR PLAN - TYPICAL
DP2.13 BUILDING 2 - MECHANICAL ROOM/ROOF PLAN

DP3.00 BUILDING 1 - NORTH ELEVATION

### Drawing List

## ARCHITECTURE DP3.01 BUILDING 1 - EAST & WEST ELEVATIONS

 DP3.02
 BUILDING 1 - SOUTH ELEVATION

 DP3.03
 BUILDING 2 - NORTH ELEVATION

 DP3.04
 BUILDING 2 - WEST ELEVATION

 DP3.05
 BUILDING 2 - EAST ELEVATION

 DP3.06
 BUILDING 2 - SOUTH ELEVATION

 DP3.07
 BUILDING 1 & 2 - WEST ELEVATION

 DP4.00
 BUILDING 1 - SECTION 1

 DP4.01
 BUILDING 1 - SECTION 2

DP4.02 BUILDING 2 - SECTION 1
DP4.03 BUILDING 2 - SECTION 2

DP5.00 PROJECT RENDERING - AERIAL PERSPECTIVE - SKYLINE
DP5.01 PROJECT RENDERING - BUILDING 1

DP5.02 PROJECT RENDERING - BUILDING 2

DP5.03 PROJECT RENDERING - OUTDOOR COMMON AMENITY

#### CIVIL

SP1 SITE SERVICING PLAN SP2 SITE GRADING PLAN

#### LANDSCAPE

DPL1 DEVELOPMENT PERMIT LANDSCAPE PLAN
DPL2 DEVELOPMENT PERMIT LANDSCAPE PLAN

### ELECTRICAL (TO BE SUBMITTED MARCH 7, 2025 UNDER SEPARATE COVER)

DP E-101 SITE PLAN

DP E-102 BUILDING 1 FEATURE LIGHTING
DP E-103 BUILDING 2 FEATURE LIGHTING

DP E-104 SITE PHOTOMETRIC CALCULATION DP E-105 LUMINAIRE SCHEDULE

## **S2**ARCHITECTURE

CONSULTANT INFORMATION

### RIVERSIDE VILLAGE

10-11A STREET N.E., CALGARY, AB

CLIENT



TOM

- nis drawing supercedes previous issues. Do not scale these drawing
- Verify all dimensions, elevations and datums, and report

REVISIED D.P. SUBMISSION

- The Contract Documents (Drawings and Specifications) are
- All drawings remain the property of the Architect. These drawings are Copyright 2024 \$2 Architecture, These drawings may not be reproduced.

ISSUED DATE
D.P. SUBMISSION Dec 18, 202

SEALS

## NOT FOR CONSTRUCTION

SCALE

DATE 3/18/2025 6:18:26 PM

DRAWN BY MH / LY / ER

CHECKED BY SM

PROJECT NO. 223136

PROJECT NOTE.

#### COVER SHEET

DRAWING NO.

**DP0.00** 



### Legal Address LOT 2, PLAN 766JK EXCEPTING ROAD PLAN 8311443

Site Summary

PARCEL AREA: 19,231.664m² 1.923 Hectare 4.752 Acres

#### By-Law Zoning

#### By-Law Setback

MINIMUM SETBACK AREAS FRONT: 0.0m SIDE: 0.0m

4.00m UTILITY RIGHT OF WAY LOCATED ALONG THE NORTH PROPERTY LINE 9.14m UTILITY RIGHT OF WAY LOCATED ALONG THE NORTH-SOUTH AXIS 7.00m UTILITY RIGHT OF WAY LOCATED ALONG THE EAST PROPERTY LINE

### Proposed Development

MULTI-RESIDENTIAL DEVELOPMENT (DISCRETIONARY USE) BUILDING CLASSIFICATION AS PER NATIONAL BUIDLING CODE 2023\_ALBERTA EDITION:

PARKING P01, P02: GROUP F, DIVISION 3 [3.2.2.81.], UP T0 2 STOREYS, SPRINKLERED BUILDING: GROUP C [3.2.2.47.], ANY HEIGHT, ANY AREA, SPRINKLERED BUILDING 2: GROUP C [3.2.2.47.], ANY HEIGHT, ANY AREA, SPRINKLERED BUILDING 2: GROUP C [3.2.2.47.], ANY HEIGHT, ANY AREA, SPRINKLERED

#### **Building Height**

MAXIMUM BUILDING HEIGHT 
• 86.0 m PROPOSED:

### Floor Area Ratio

BUILDING 1 (PHASE 01): ±86.0 m BUILDING 2 (PHASE 02): ±53.0 m

٠.	1 loor / irou Kutio				
	MAX. PERMITTED F.A.R.	PROPOSED F.A.R. (PHASE 1)			
	4.5	4.49			
	MAX. PERMITTED F.A.R.	PROPOSED F.A.R. (PHASE 2)			
	4.5	3.56			

D	ensity		
Г		DENSITY (UNITS PER HECTARE	:)
lt	MIN. PERMITTED	MAX. PERMITTED	PROPOSED
lt	N/A	N/A	233

#### Area Summary

NOTE: BALCONY, PATIO, TERRACE, AND DECK AREAS; AND ABOVE GRADE PARKING AREAS ARE NOT INCLUDED.

	FLOOR AREA	
DING 1		
LEVEL	AREA (m2)	
LEVEL 1	1989.37	
LEVEL 2	866.86	
LEVEL 3	866.86	
LEVEL 4	866.86	
LEVEL 5	866.86	
LEVEL 6	866.86	
LEVEL 7	860.55	
LEVEL 8	860.55	
LEVEL 9	860.55	
LEVEL 10	860.55	
LEVEL 11	860.55	
LEVEL 12	860.55	

LEVEL /	000.00
LEVEL 8	860.55
LEVEL 9	860.55
LEVEL 10	860.55
LEVEL 11	860.55
LEVEL 12	860.55
LEVEL 13	860.55
LEVEL 14	860.55
LEVEL 15	860.55
LEVEL 16	860.55
LEVEL 17	860.55
LEVEL 18	860.55
LEVEL 19	860.55
LEVEL 20	860.55
LEVEL 21	860.55
LEVEL 22	860.55
LEVEL 23	860.55
LEVEL 24	860.55
LEVEL 25	860.55

LEVEL 25	860.55
LEVEL 26	860.55
LEVEL 27	846.51
MECH ROOPTOP	272.0
BUILDING 1 TOTAL	24,653.18
BUILDING 2	
LEVEL	AREA (m2)
LEVEL 1	2154
LEVEL 2	840
LEVEL 3	1052
LEVEL 4	1050
LEVEL 5	1050
LEVEL 6	1050
LEVEL 7	1050
LEVEL 8	1050

LEVEL 5	1050
LEVEL 6	1050
LEVEL 7	1050
LEVEL 8	1050
LEVEL 9	1050
LEVEL 10	1050
LEVEL 11	1050
LEVEL 12	1050
LEVEL 13	1050
LEVEL 14	1050
LEVEL 15	1050
LEVEL 16	1050
LEVEL 17	1050
MECH ROOFTOP	256

### BUILDING 2 TOTAL Dwelling Unit Count

		oung one count building !	]	Total Unit Parking
Name	Area	Count	J	Total Visitor Parking
uilding 1			_	Grand Total
Bed+Den	64 m² 65 m²	45	1	
Bed-01	57 m² 59 m²	90	1	Diamete Dentina Dentina neces
Bed	85 m² 86 m²	95	1	Bicycle Parking Requirements
-Bed-2 Balcony	91 m <sup>2</sup> 92 m <sup>2</sup>	5	1	

1-Bed-01	57 m² 59 m²	90
2-Bed	85 m² 86 m²	95
2-Bed-2 Balcony	91 m² 92 m²	5
3-Bed	118 m² 119 m²	5
Penthouse 2-Bed-01	124 m² 124 m²	2
Penthouse 2-Bed-02	117 m² 117 m²	2
Penthouse 2-Bed-03	113 m² 113 m²	2
Studio-01	34 m²	5
Studio-02	34 m² 35 m²	5
Building 1: 256	•	•
DP - Pro	oject Statistics - Dw	elling Unit Count_Building 2

Name	Area	Count
Building 2		
1-Bed 01	59 m² 63 m²	30
1-Bed 02	58 m² 60 m²	30
1-Bed 03	65 m² 69 m²	30
1-Bed 04	58 m² 58 m²	30
2-Bed	86 m² 86 m²	60

UNIT NAME	Area		Count	
2-Bed Townhouse 01	116 m²		5	_
2-Bed Townhouse 02	139 m²		4	_
3-Bed Townhouse	152 m²		2	
OTAL			11	
OTAL UNIT COUNT	180+11+	256=	447	

#### Landscape Summary

DE					
)C	Ш		LANDSCA	PED AREA	
	Ш		SOFT SURFACE	HARD SURFACE	TOTAL
	Ш	REQUIRED	-	-	-
	Ш	PROVIDED	13.8% (2653.51m²)	9.3% (1786.60m²)	23.1% (4440.11m²)

	TREE REQUIREMENTS	
	REQUIRED	PROVIDED
DECIDUOUS TREES	73	74
CONIFEROUS TREES	32	32
TOTAL	105	106

ı			
l		SHRUB REQUIREMENTS	
l		REQUIRED	PROVIDED
l	GROUND LEVEL	-	318
l	TOTAL	-	318
ı			

#### Motor Vehicle Parking Requirements

	RESIDENTIAL - UNIT PAR	KING	
	FACTOR (STALL PER		1
DESCRIPTION	UNIT)	REQUIRED	PROVI
	,		
P1 & P2	0.75	192	192
	RESIDENTIAL - VISITOR PA	RKING	
DESCRIPTION	FACTOR (STALL PER	REQUIRED	PROVI
P1	0.1	26	26
	BF STALLS PROVIDED	)	
DESCRIPTION	RESIDENT	VISITOR	TOTA
P1	5	4	9
PI ILDING 2	-		9
	5  RESIDENTIAL - UNIT PAR		9
	-		
ILDING 2	RESIDENTIAL - UNIT PAR	KING	PROVI
ILDING 2  DESCRIPTION	RESIDENTIAL - UNIT PAR FACTOR (STALL PER UNIT)	KING	PROVI
ILDING 2  DESCRIPTION	RESIDENTIAL - UNIT PAR FACTOR (STALL PER UNIT)	KING REQUIRED 144	PROVI
ILDING 2  DESCRIPTION	RESIDENTIAL - UNIT PAR FACTOR (STALL PER UNIT) 0.75	KING REQUIRED 144	PROVII 218
DESCRIPTION P1 & P2	RESIDENTIAL - UNIT PAR FACTOR (STALL PER UNIT) 0.75  RESIDENTIAL - VISITOR PA	REQUIRED 144	PROVI
DESCRIPTION P1 & P2  DESCRIPTION	RESIDENTIAL - UNIT PAR FACTOR (STALL PER UNIT) 0.75  RESIDENTIAL - VISITOR PA FACTOR (STALL PER	REQUIRED 144 RKING REQUIRED	PROVI
DESCRIPTION P1 & P2  DESCRIPTION	RESIDENTIAL - UNIT PAR FACTOR (STALL PER UNIT) 0.75  RESIDENTIAL - VISITOR PA FACTOR (STALL PER	REQUIRED 144  RKING REQUIRED 20	PROVII 218
DESCRIPTION P1 & P2  DESCRIPTION	RESIDENTIAL - UNIT PAR FACTOR (STALL PER UNIT) 0.75  RESIDENTIAL - VISITOR PA FACTOR (STALL PER 0.1	REQUIRED 144  RKING REQUIRED 20	PROVI

#### Grand Total

BUILDING 1			
	RESIDENTIAL - CLASS 1 PARKING	€	
DESCRIPTION	FACTOR (STALL PER UNIT)	REQUIRED	PROVIDED
LEVEL 1	0.5	128	128
	RESIDENTIAL - CLASS 2 PARKING	3	
DESCRIPTION	FACTOR (STALL PER UNIT)	REQUIRED	PROVIDED
SITE	0.1	26	26

ALDINO 2			
	RESIDENTIAL - CLASS 1 PARKING	€	
DESCRIPTION	FACTOR (STALL PER UNIT)	REQUIRED	PROVIDE
LEVEL 1	0.5	96	96
	RESIDENTIAL - CLASS 2 PARKING	3	
DESCRIPTION	FACTOR (STALL PER UNIT)	REQUIRED	PROVIDE
SITE	0.1	20	20

BICYCLE PARKING SUMMARY	
RESIDENTIAL - CLASS   PARKING	224
RESIDENTIAL - CLASS 2 PARKING	46
TOTAL	270

### Waste & Recycling Requirements

	RES	IDENTIAL - WAS	TE & RECYCLING			
BUILDINGS #						
		NO. OF E	INS (4 yd²)	STO	RAGE	
DESCRIPTION	QUANTITY	REQUIRED	PROVIDED	REQUIRED	PROVIDED	STAGING
DWELLING UNIT	256	8	8	72m²	78m²	36m²

CALCULATIONS: (256 UNITS) (256 UNITS) (256 UNITS) (10) X 9  $\rm g^{1}$  = 76.8 y  $\rm g^{1}$  TOTAL WASTE & RECYCLING PRODUCED 76.8 y  $\rm g^{1}$  / 2 (FREQUENCY OF WASTE PICKUP) = 38.4 y  $\rm g^{1}$  / 2 (FREQUENCY OF WASTE PICKUP) = 38.8 y  $\rm g^{1}$  / 2 (FREQUENC) = 2 (COMPOST) 4 LANDFILL BINS / 3 (3.1 COMPACTOR RATIO) = 2 LANDFILL BINS 8 (3.1 COMPACTOR RATIO) = 2 LANDFILL BINS 8 (3.1 COMPACTOR) STORAGE AREA REQUIRED 72 m² + 5 TORAGE AREA / 2 = 36 m² STAGING AREA REQUIRED

RESIDENTIAL WASTERNEST SEINS						
BUILDINGS #						
		NO. OF B	INS (4 yd³)	STOR	RAGE	
DESCRIPTION	QUANTITY	REQUIRED	PROVIDED	REQUIRED	PROVIDED	STAGING
DWELLING UNIT	191	6	6	54m²	71m²	27m²

CALCULATIONS:
(19) UNITS / 10) x 3 yd\* = 57.3 yd\* TOTAL WASTE & RECYCLING PRODUCED
57.3 yd\* / 2 (FREGUENCY OF WASTE PICKUP) = 28.7 yd\* 2
26.7 yd\* / 4 yd\* = 7.2 BINS = 8 BINS (3.1 ANDFILL). 4 RECYCLE, 1 COMPOST)
31 ANDFILL BINS / 3 (3.1 COMPACTOR RATIO) = 1 LANDFILL BIN
6 BINS y 9 m\* = 54 m\* + 10 m\* (COMPACTOR) STORAGE AREA RECUIRED
54 m\* 51 GTARG AREA / 2 = 27 m\* 51 AGNIG ARECUIRED

#### Amenity Summary

		AMENITY SUMMARY		
DESCRIPTION	TOTAL UNITS	UNITS WITH PRIVATE AMENTIY	UNITS WITHOUT PRIVATE AMENITY	REQUIRED PUBLIC AMENITY (sqm)
REQURIED AMENITY SPACE	256	156	100	500
		PUBLIC AMENITY SUMMARY		
DESCRIPTION			AREA (sam)	REQUIRED
RESIDENT COMMUNITY KITCHE	N	TROPIDEE	REGUITED	
COWORKING SPACE		102		-
RESIDENT LOUNGE			78	
INDOOR PLAY			59	
VIRTUAL GOLF			33	
GYM			361	
TOTAL AMENITY SPACE		765		500

TOTAL AMENITY SPACE

456

		AMENITY SUMMARY		
DESCRIPTION	TOTAL UNITS	UNITS WITH PRIVATE AMENTIY	UNITS WITHOUT PRIVATE AMENITY	REQUIRED PUBLIC AMENITY (sqm)
PRIVATE AMENITY SPACE	180	180	0	0
		•		•
		PUBLIC AMENITY SUMMARY		
DESCRIPTION		PROVIDED AREA (sqm) REQUIR		
GYM			142	

### **S2**ARCHITECTURE

CONSULTANT INFORMATION

### RIVERSIDE VILLAGE

10-11A STREET N.E., CALGARY, AB



D.P. SUBMISSION Dec 18, 2024 REVISIED D.P. SUBMISSION March 14, 2025

SEALS

#### NOT FOR CONSTRUCTION


SCALE DATE 3/24/2025 1:40:25 PM

CHECKED BY PROJECT NO. 223136

DRAWING TITLE

### PROJECT STATISTICS

**DP0.01** 

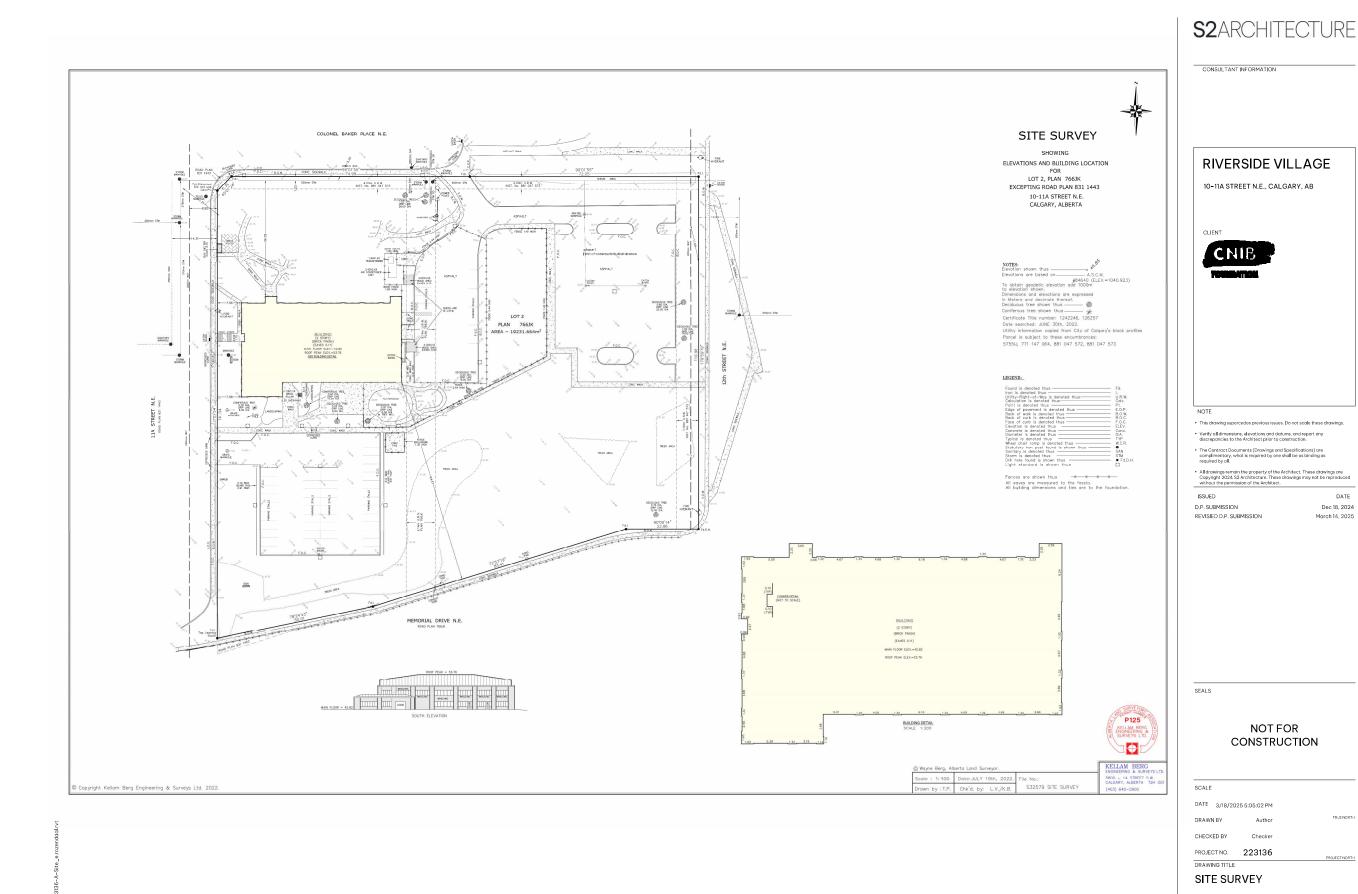

DP0.02

March 14, 2025

## **S2**ARCHITECTURE

CONSULTANT INFORMATION

### RIVERSIDE VILLAGE 10-11A STREET N.E., CALGARY, AB







REVISIED D.P. SUBMISSION







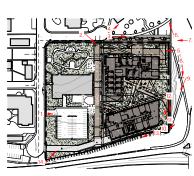

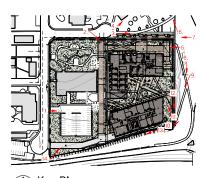





03.
















# NOT FOR CONSTRUCTION


PROJECT NO. 223136 DRAWING TITLE

SITE PHOTOS

DP0.03

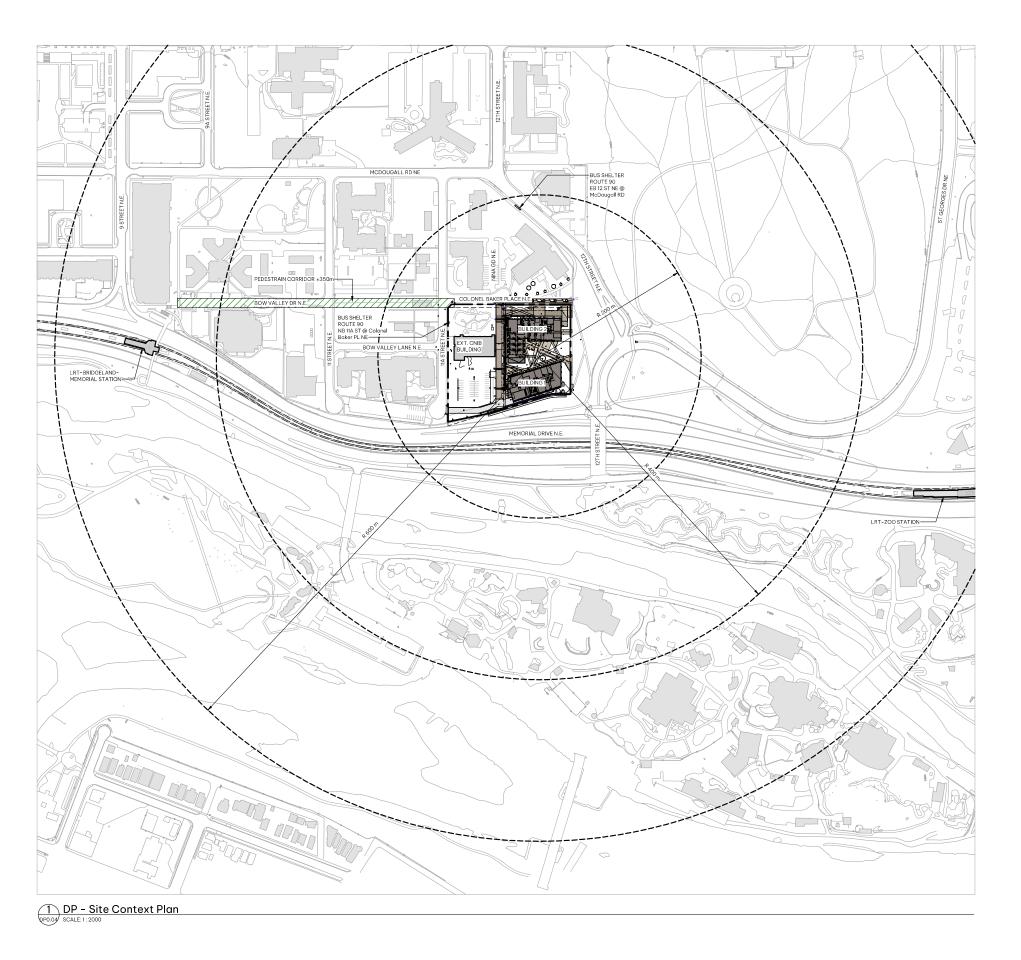



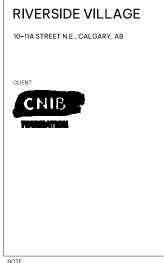

NOTE

- This drawing supercedes previous issues. Do not scale these dra
- Verify all dimensions, elevations and datums, and repo discrepancies to the Architect prior to construction.
- The Contract Documents (Drawings and Specifications) are complimentary, what is required by one shall be as binding as
- All drawings remain the property of the Architect. These drawings a Convright 2024 S2 Architecture. These drawings may not be repro-

Copyright 2024 52 Architecture. I nese grawings may not be reprodu without the permission of the Architect.

D.P. SUBMISSION Dec 18, 202
REVISIED D.P. SUBMISSION March 14, 202

SEALS

## NOT FOR CONSTRUCTION

SCALE 1: 2000

DATE 3/18/2025 5:05:31 PM

DRAWN BY Author

CHECKED BY Checker

PROJECT NO. 223136

DRAWING TITLE

SITE CONTEXT PLAN

DP0.04












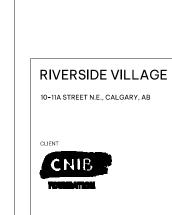

**S2**ARCHITECTURE





















SEALS

D.P. SUBMISSION

REVISIED D.P. SUBMISSION

### NOT FOR CONSTRUCTION

Dec 18, 2024


March 14, 2025

SCALE	1:5000	
DATE 3/18/2	025 5:10:37 PM	
DRAWN BY	Author	TRUENOR
CHECKED BY	Checker	
PROJECT NO.	223136	PROJECTINOR

SHADOW STUDY

DP0.05



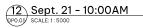






13 Sept. 21 - 12:00PM



14 Sept. 21 - 2:00PM

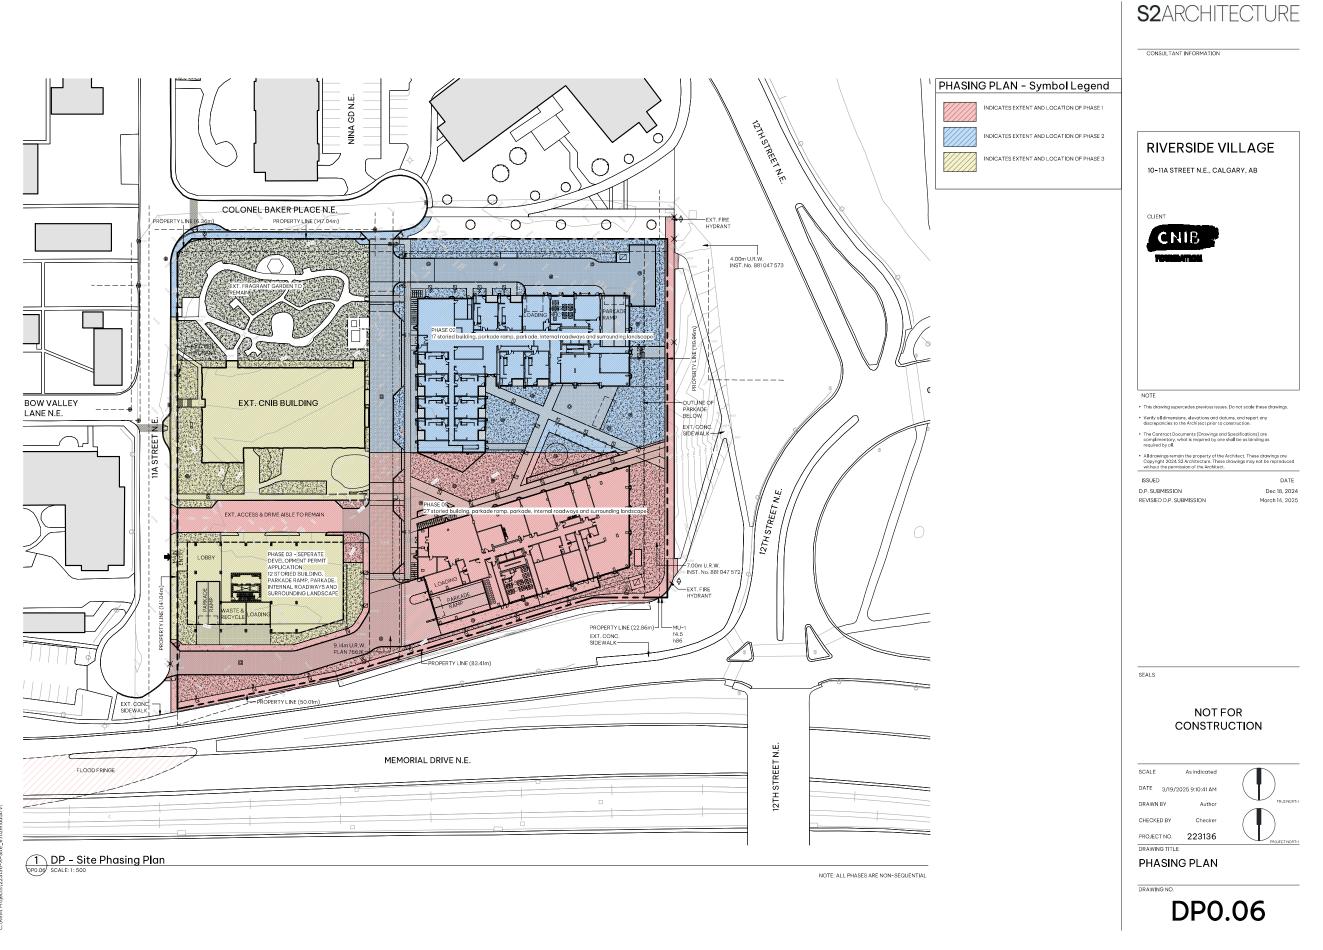


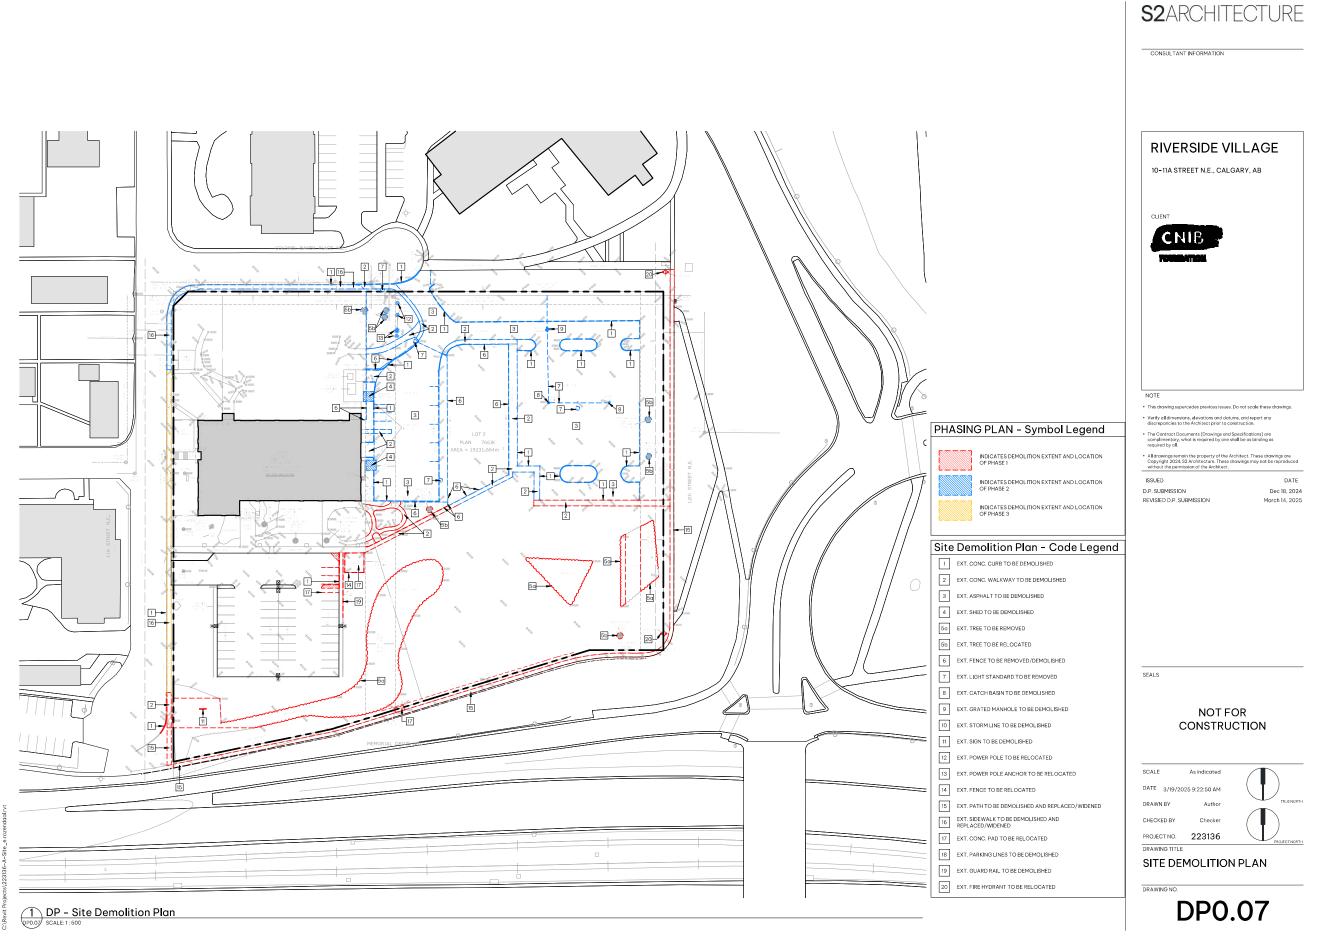


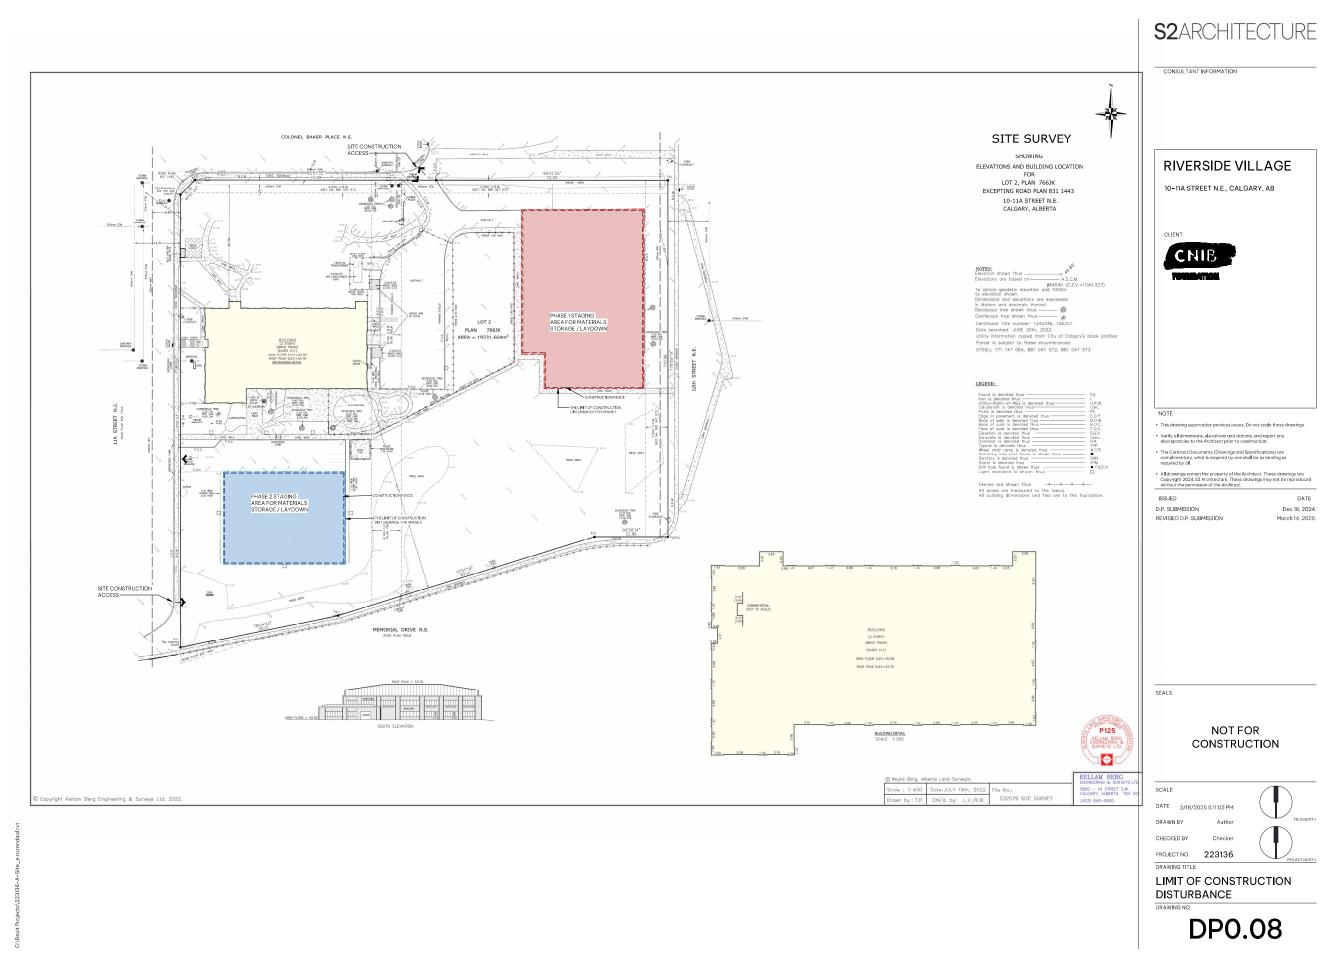


March 14, 2025

NOT FOR

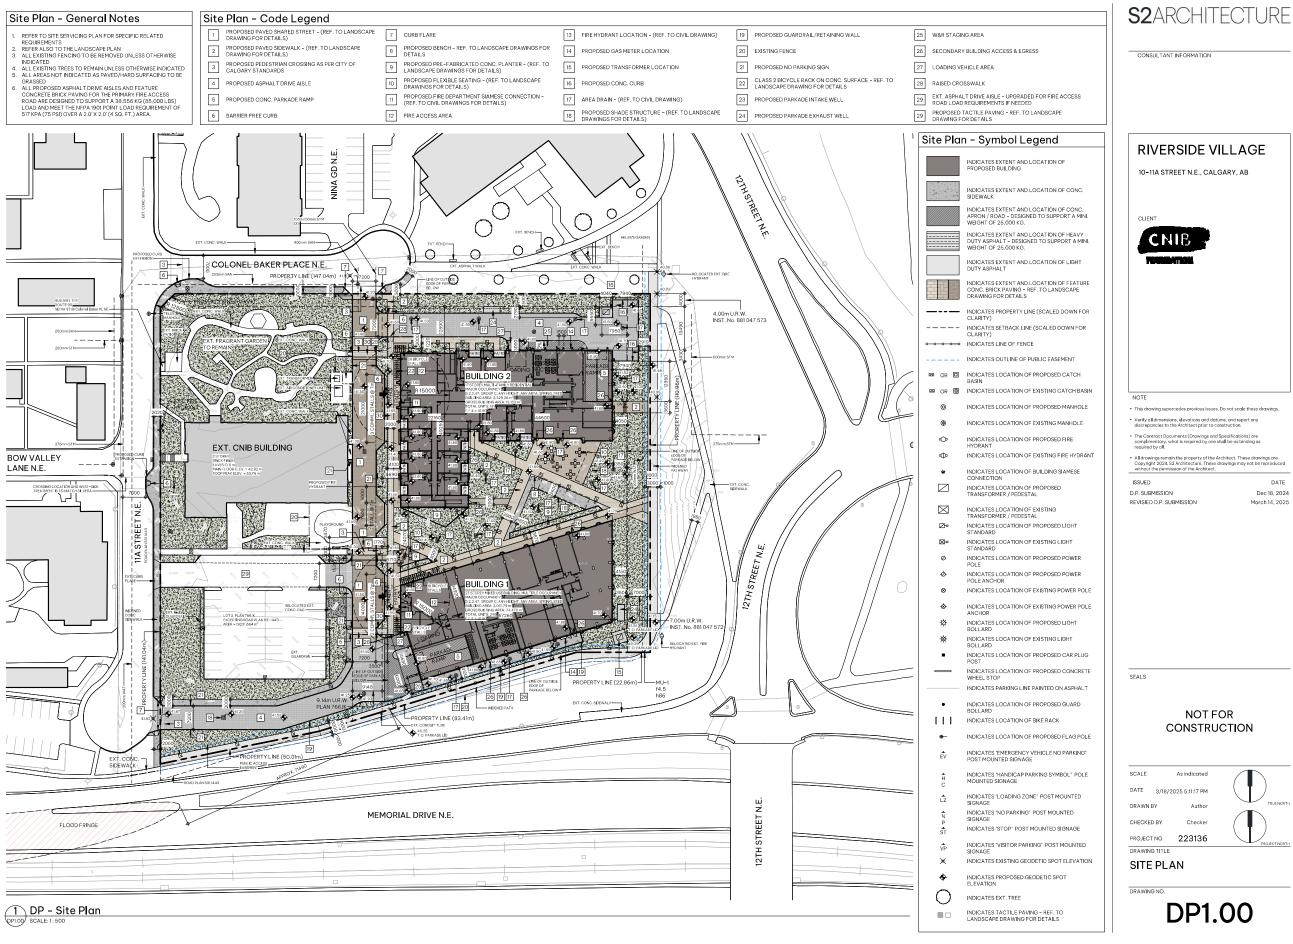

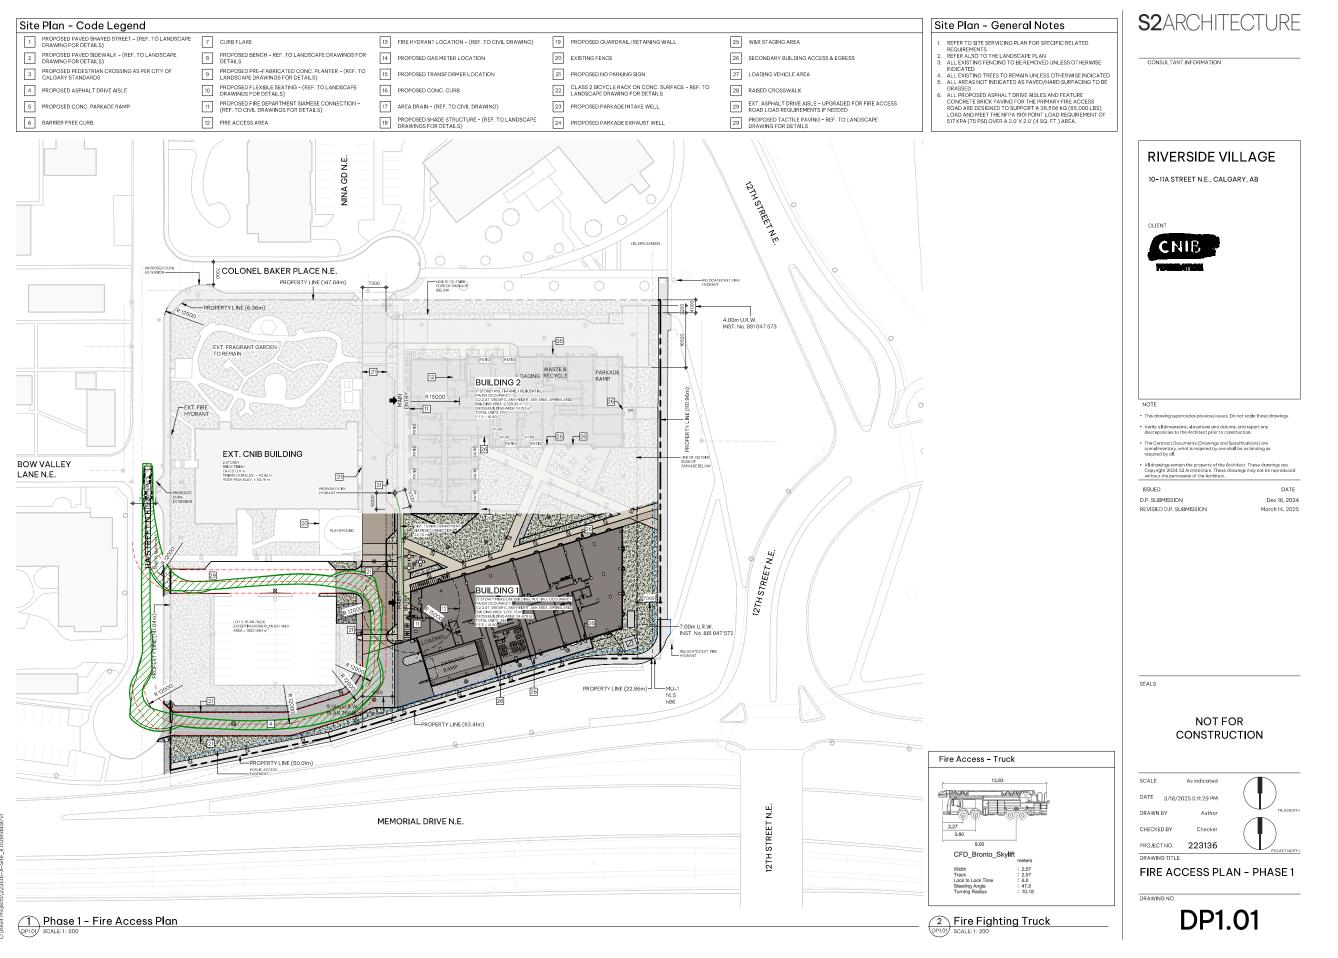

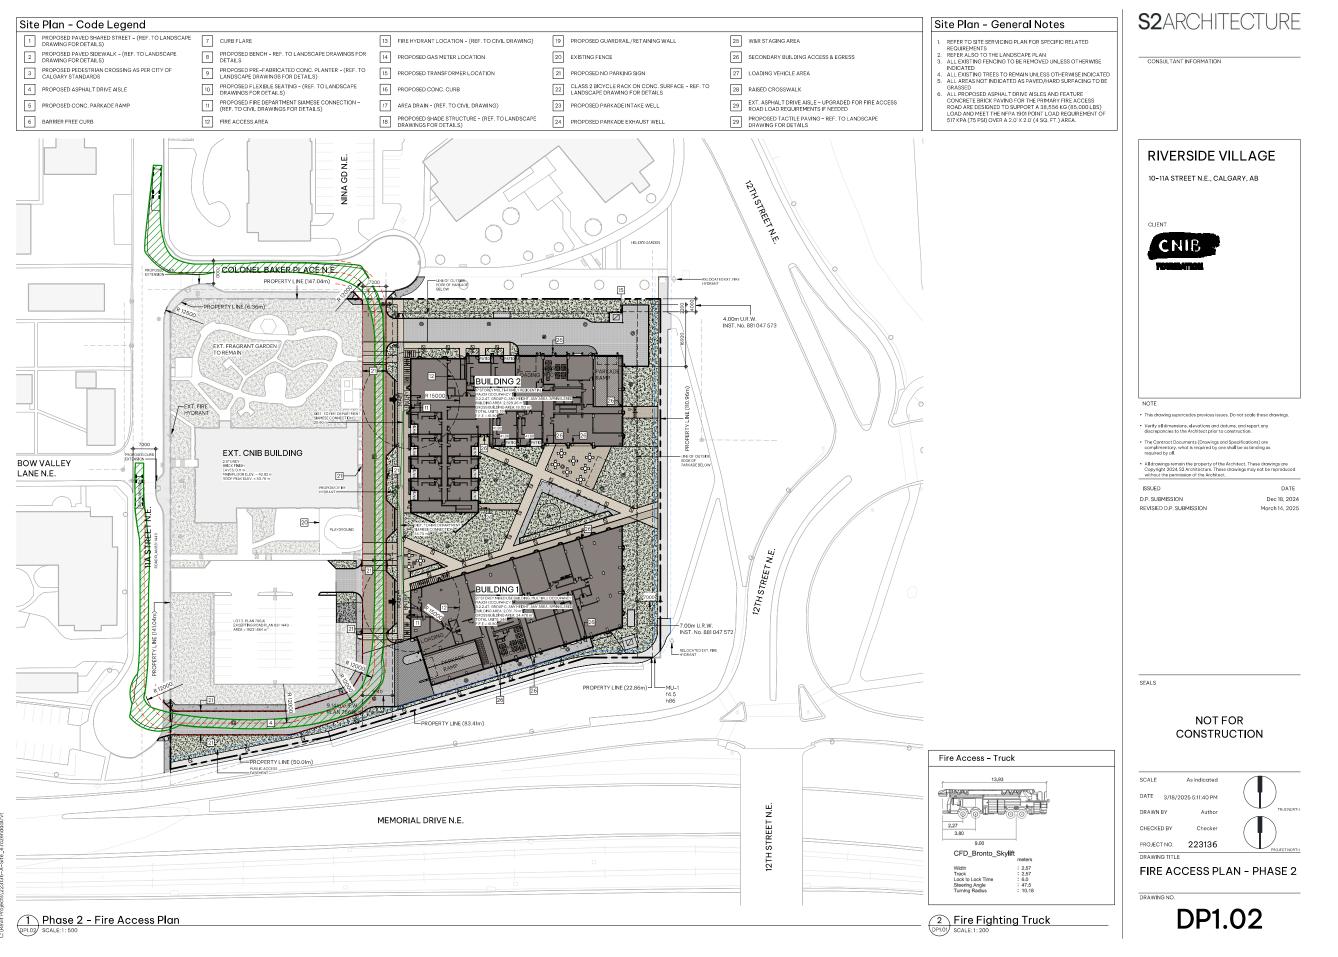





Vehicle Tracking V2500277321840250 (c) Autodesk, Inc. mmAutodesk.com Notes Turri(s) based upon a design speed of 5.00km/h. SU9 - Single Unit or Bus

3 SU-9 TRUCK SWEEP PATH DETAILS

SCALE: 1: 200

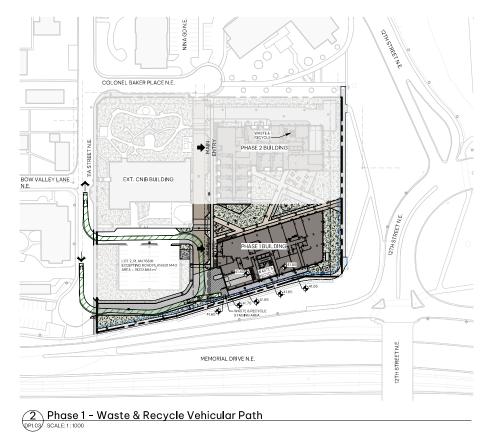

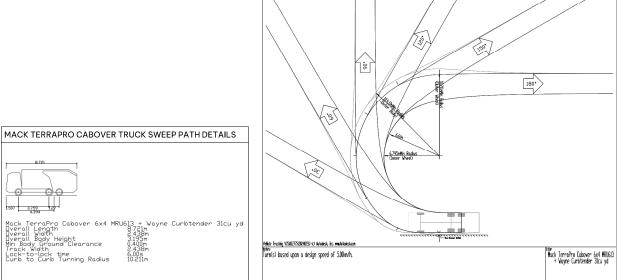


MACK TERRAPRO CABOVER TRUCK SWEEP PATH DETAILS

SCALE:1:200

## **S2**ARCHITECTURE

CONSULTANT INFORMATION

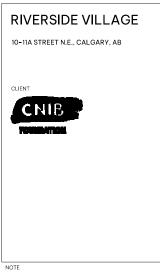


REVISIED D.P. SUBMISSION March 14, 2025

SEALS

#### NOT FOR CONSTRUCTION

CHECKED BY PROJECT NO. 223136 DRAWING TITLE


VEHICULAR MOVEMENT PLAN\_PHASE1

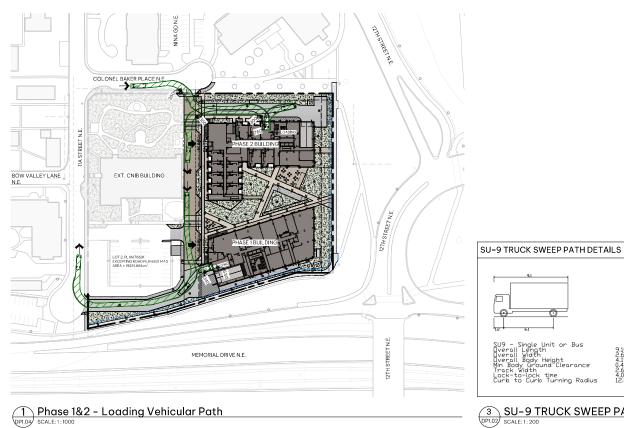


Vehicle Tracking V2500277321840250 (c) Autodesk, Inc. mmAutodesk.com Notes Turri(s) based upon a design speed of 5.00km/h. SU9 - Single Unit or Bus

3 SU-9 TRUCK SWEEP PATH DETAILS

SCALE: 1: 200

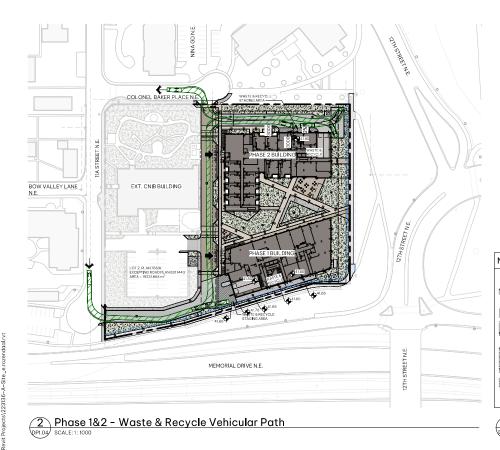

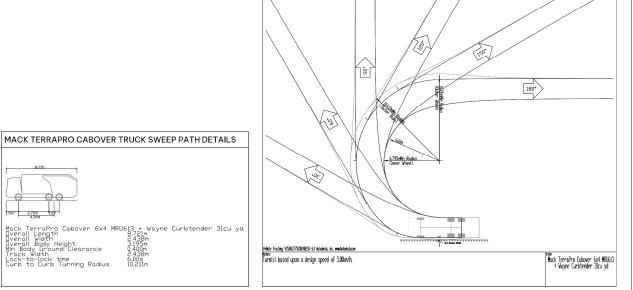


4 MACK TERRAPRO CABOVER TRUCK SWEEP PATH DETAILS

SCALE: 1: 200

## **S2**ARCHITECTURE

CONSULTANT INFORMATION

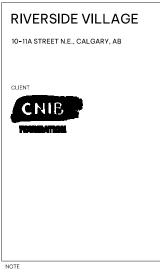

REVISIED D.P. SUBMISSION


March 14, 2025

SEALS

#### NOT FOR CONSTRUCTION


CHECKED BY PROJECT NO. 223136 DRAWING TITLE VEHICULAR MOVEMENT

PLAN\_PHASE 2

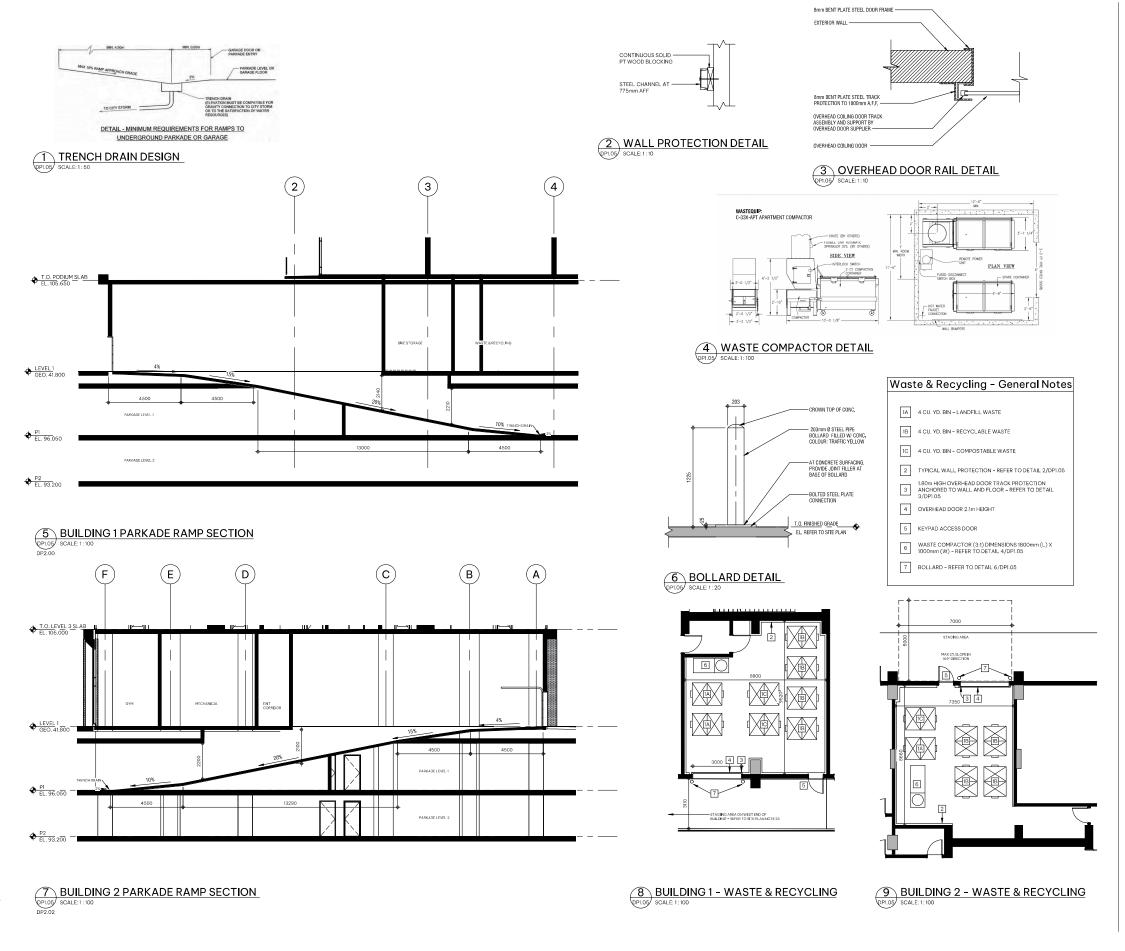

**S2**ARCHITECTURE

CONSULTANT INFORMATION

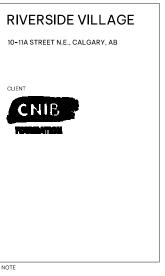

drawing supercedes previous issues. Do not scale these

Verify all dimensions, elevations and datums, and reporting discrepancies to the Architect prior to construction.

REVISIED D.P. SUBMISSION

 The Contract Documents (Drawings and Specifications) are complimentary, what is required by one shall be as binding as

All drawings remain the property of the Architect. These drawings an

ISSUED DATE
D.P. SUBMISSION Dec 18, 202

March 14, 2025

SEALS

## NOT FOR CONSTRUCTION

SCALE As indicated

DATE 3/18/2025 5:12:20 PM

DRAWIN BY Author TRUEMORTH


CHECKED BY Checker


PROJECT NO. 223136

DRAWING TITLE


SITE DETAILS


JIL DE IAIL

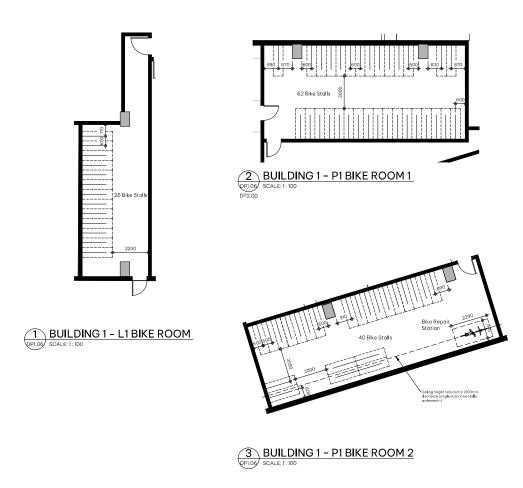

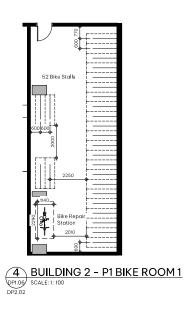



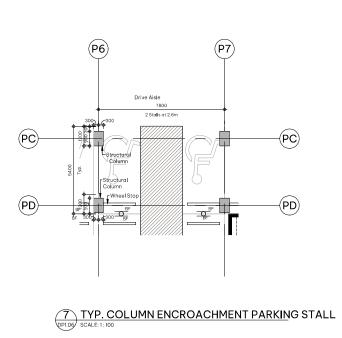

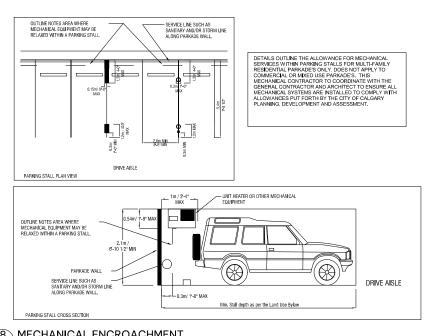


8 MECHANICAL ENCROACHMENT

PRIOR SCALE: 1: 100

**S2**ARCHITECTURE

CONSULTANT INFORMATION

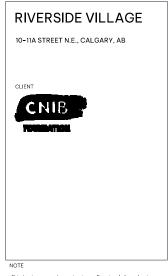

REVISIED D.P. SUBMISSION March 14, 2025


SEALS


#### NOT FOR CONSTRUCTION

SCALE CHECKED BY PROJECT NO. 223136 DRAWING TITLE

SITE DETAILS



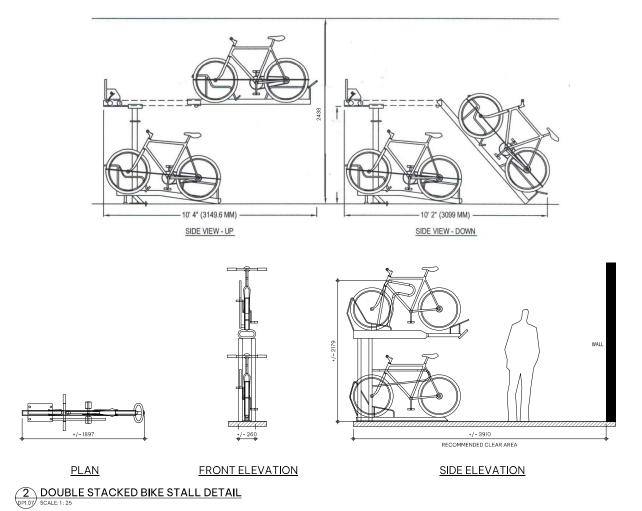

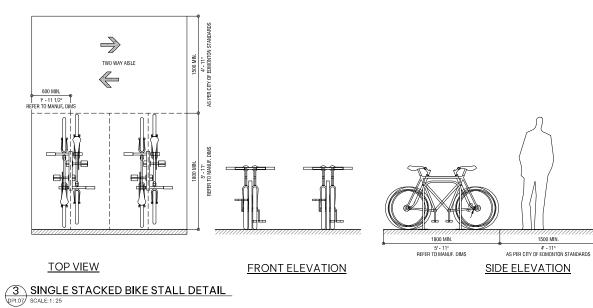

**S2**ARCHITECTURE

CONSULTANT INFORMATION


RIVERSIDE VILLAGE 10-11A STREET N.E., CALGARY, AB CNIB

REVISIED D.P. SUBMISSION

SEALS


#### NOT FOR CONSTRUCTION


PROJECT NO. 223136 DRAWING TITLE SITE DETAILS

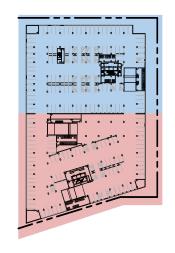


PARKADE KEY PLAN

OP2.00 SCALE:1:1000

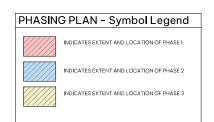

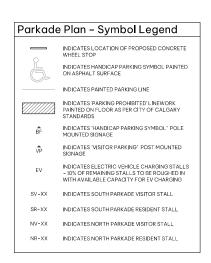




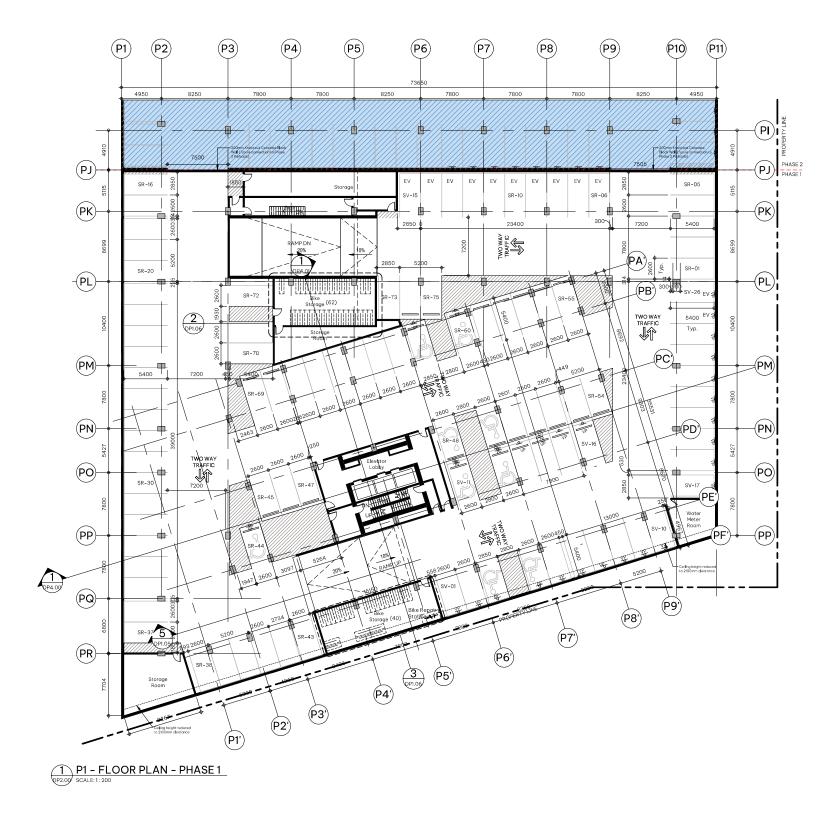

**S2**ARCHITECTURE

CONSULTANT INFORMATION

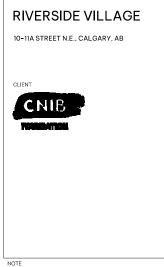

This drawing supercedes previous issues. Do not scale these dra

discrepancies to the Architect prior to construction.

 The Contract Documents (Drawings and Specifications) are complimentary, what is required by one shall be as binding as

All drawings remain the property of the Architect. These drawings are Copyright 2024, \$2 Architecture. These drawings may not be reproduce

D.P. SUBMISSION Dec 18, 2024
REVISIED D.P. SUBMISSION March 14, 2025

SEALS

## NOT FOR CONSTRUCTION

SCALE As indicated

DATE 3/19/2025 3:00:02 PM

DRAWN BY Author


CHECKED BY Checker


PROJECT NO. 223136


DRAWING TITLE


PARKADE LEVEL 1 - PHASE 1


DRAWING NO

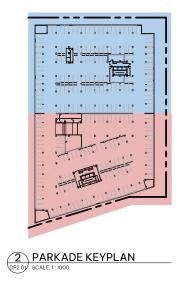

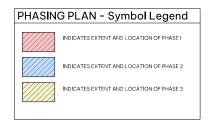


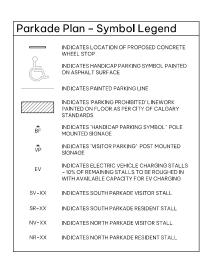

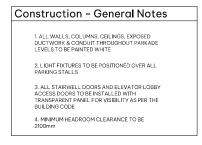

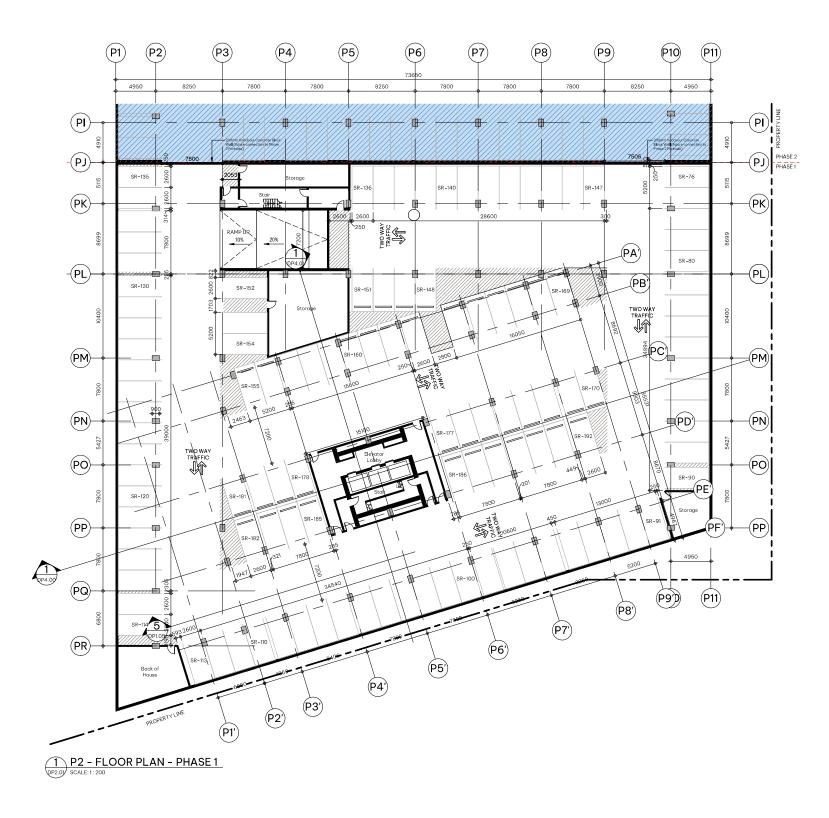



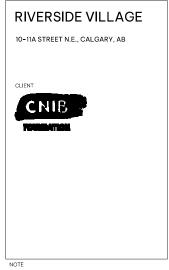

This drawing supercedes previous issues. Do not scale the

discrepancies to the Architect prior to construction.

 The Contract Documents (Drawings and Specifications) are complimentary, what is required by one shall be as binding as

 All drawings remain the property of the Architect. These drawings are Copyright 2024, S2 Architecture. These drawings may not be reprodu

D.P. SUBMISSION Dec 18, 2024
REVISIED D.P. SUBMISSION March 14, 2025

SEALS

## NOT FOR CONSTRUCTION

SCALE As indicated

DATE 3/19/2025 3:00:04 PM

DRAWN BY Author


CHECKED BY Checker


PROJECT NO. 223136


DRAWING TITLE


PARKADE LEVEL 2 - PHASE 1


DRAWING NO.

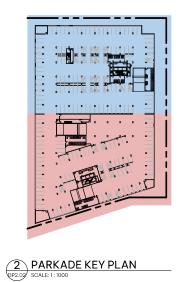

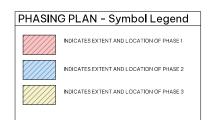

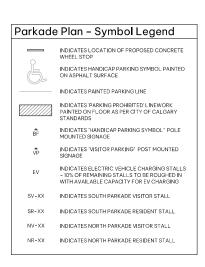

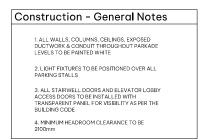

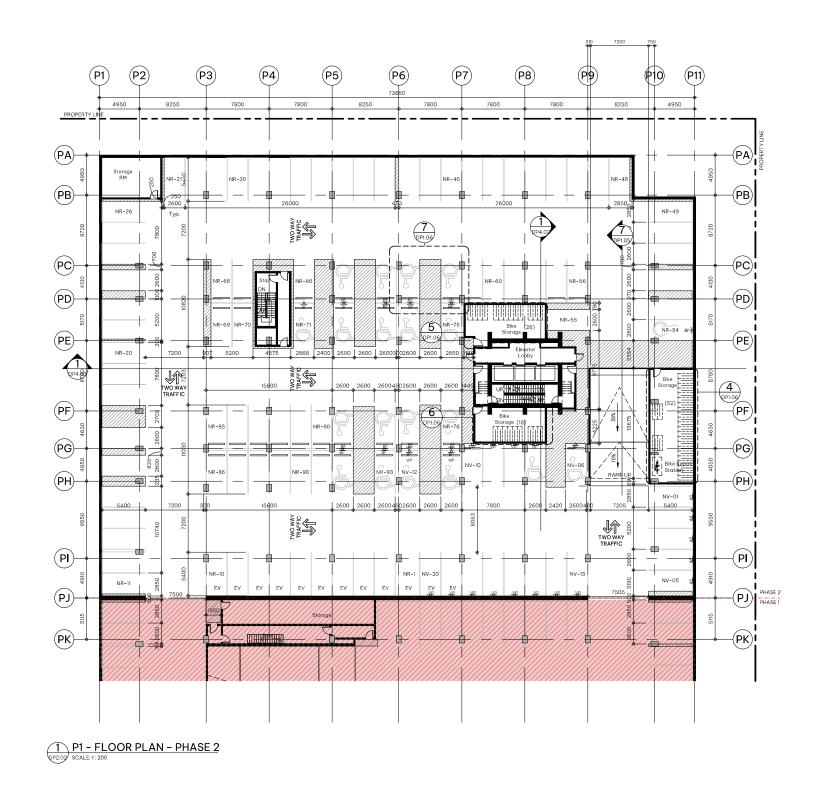





his drawing supercedes previous issues. Do not scale these dr

discrepancies to the Architect prior to construction.

 The Contract Documents (Drawings and Specifications) are complimentary, what is required by one shall be as binding as

 All drawings remain the property of the Architect. These drawings as Copyright 2024, S2 Architecture. These drawings may not be reproc

 ISSUED
 DATE

 D.P. SUBMISSION
 Dec 18, 2024

 REVISIED D.P. SUBMISSION
 Morch 14, 2025

SEALS

# NOT FOR CONSTRUCTION

SCALE As indicated

DATE 3/19/2025 3:00:07 PM

DRAWN BY Author


CHECKED BY Checker


PROJECT NO. 223136


DRAWING TITLE


PARKADE LEVEL 1 - PHASE 2


DRAWING NO.

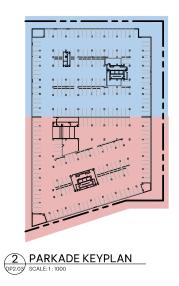

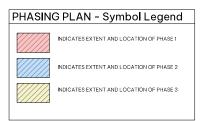

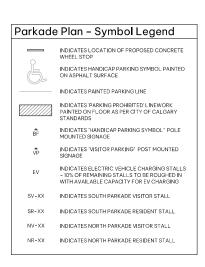

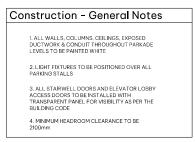

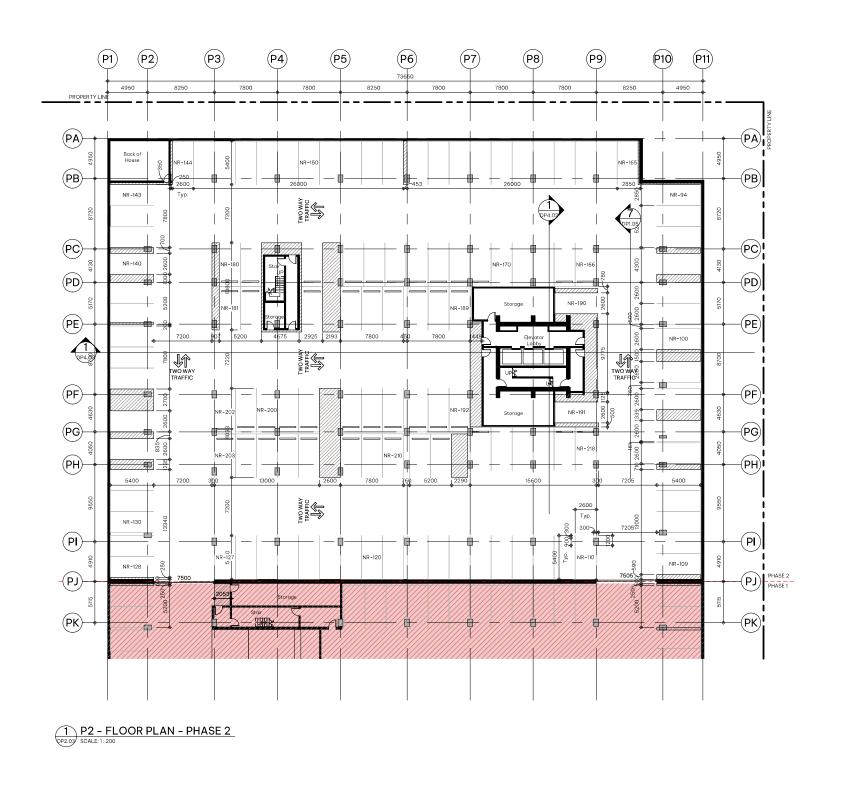

## **S2**ARCHITECTURE

CONSULTANT INFORMATION



ISSUED REVISIED D.P. SUBMISSION March 14, 2025

SEALS

#### NOT FOR CONSTRUCTION

SCALE DATE 3/19/2025 3:00:10 PM CHECKED BY PROJECT NO. 223136 DRAWING TITLE


PARKADE LEVEL 2 - PHASE 2






BUILDING 1 - MAIN LEVEL FLOOR PLAN DRAWING NO.

DP2.04

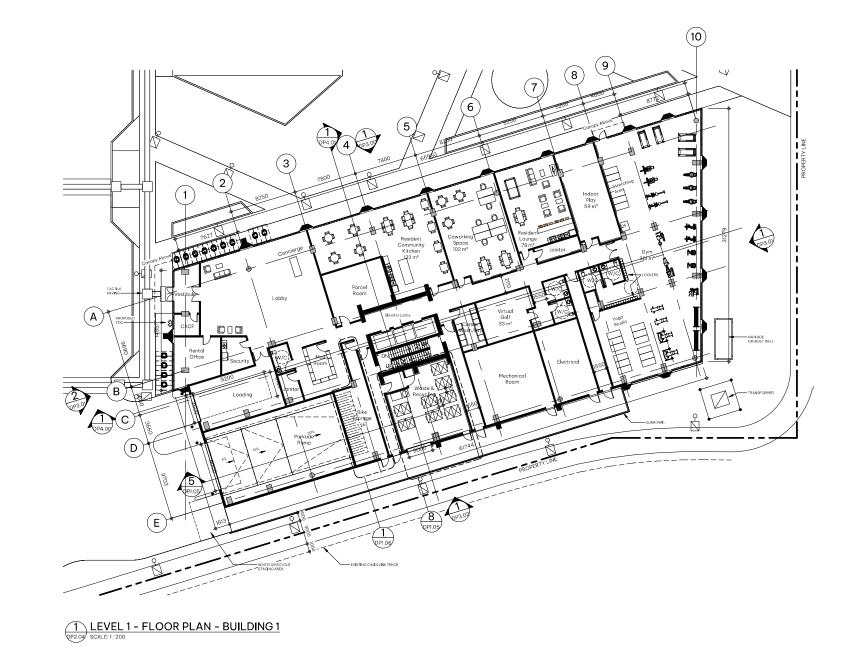



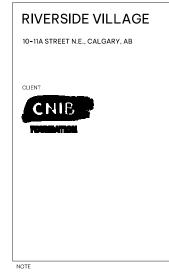


REVISIED D.P. SUBMISSION


# NOT FOR CONSTRUCTION

PROJECT NO. 223136 DRAWING TITLE


BUILDING 1 - LEVELS 2 THRU 6

DP2.05

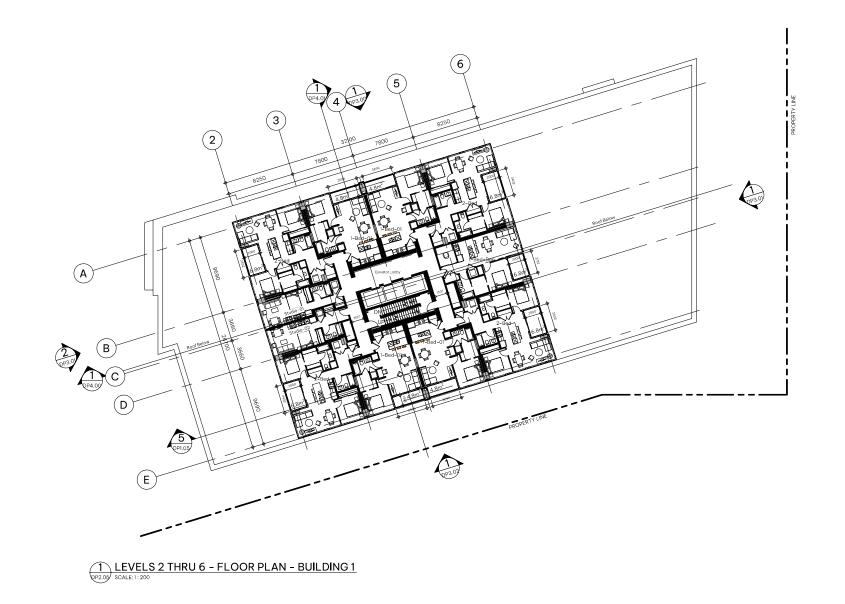


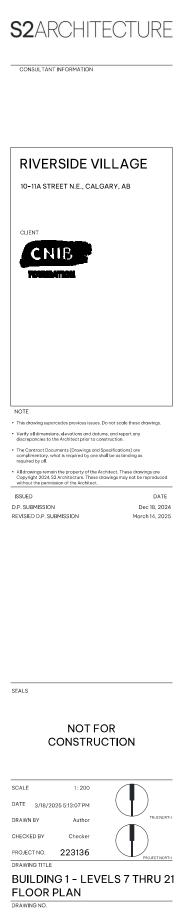

DP2.06

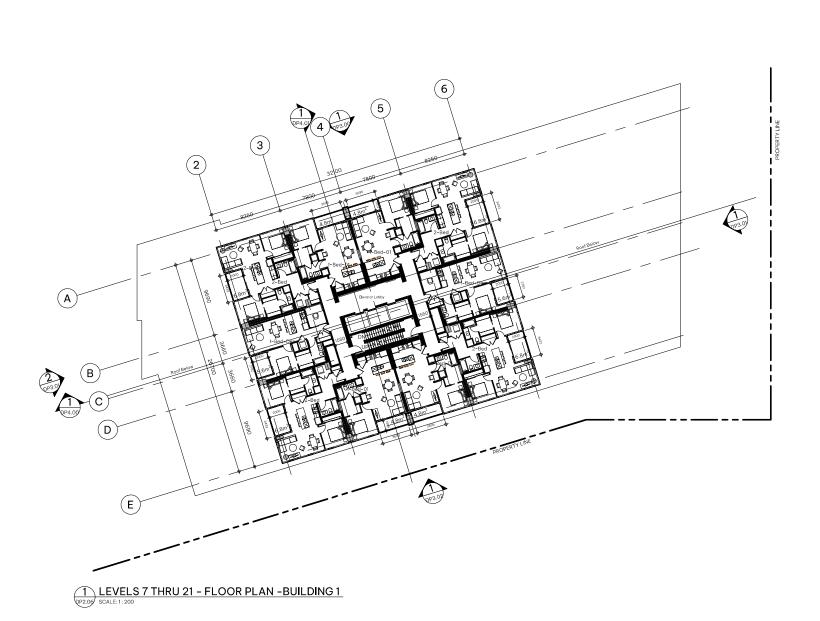



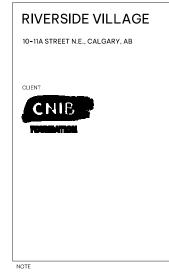


REVISIED D.P. SUBMISSION

# NOT FOR CONSTRUCTION

PROJECT NO. 223136 DRAWING TITLE

BUILDING 1 - LEVELS 22 THRU 26 FLOOR PLAN

DP2.07

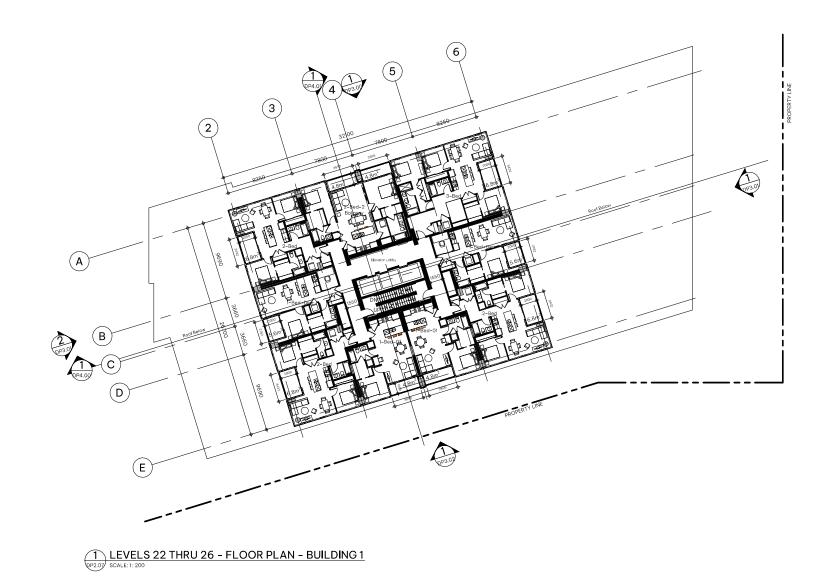

## **S2**ARCHITECTURE

CONSULTANT INFORMATION





REVISIED D.P. SUBMISSION

# NOT FOR CONSTRUCTION

PROJECT NO. 223136 DRAWING TITLE

BUILDING 1 - PENTHOUSE FLOOR PLAN LEVEL 27 DRAWING NO.

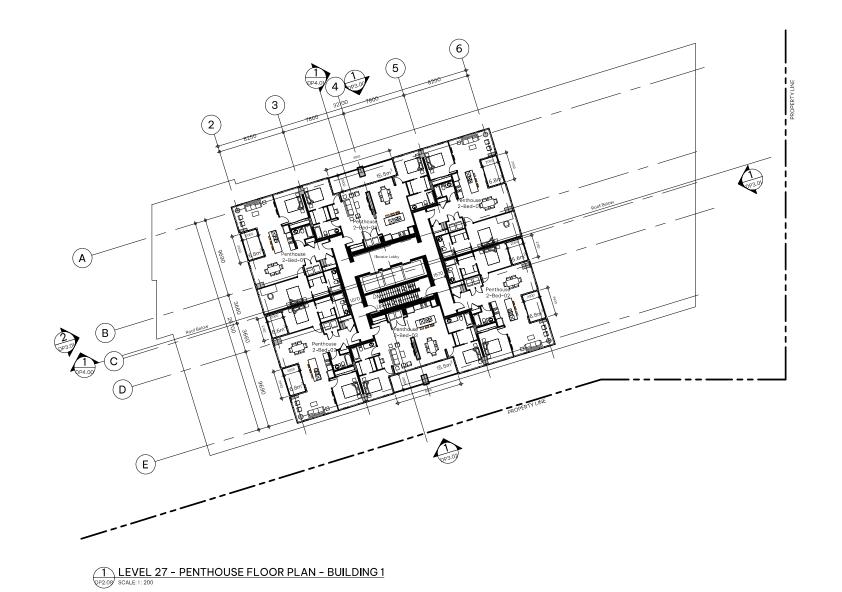


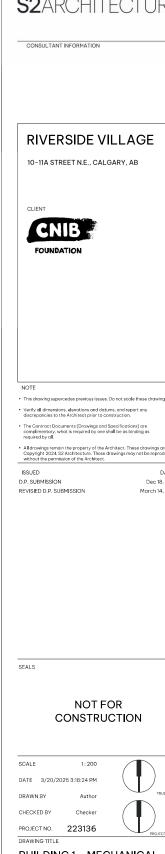





BUILDING 1 - MECHANICAL ROOM/ROOF PLAN DRAWING NO.


DP2.09

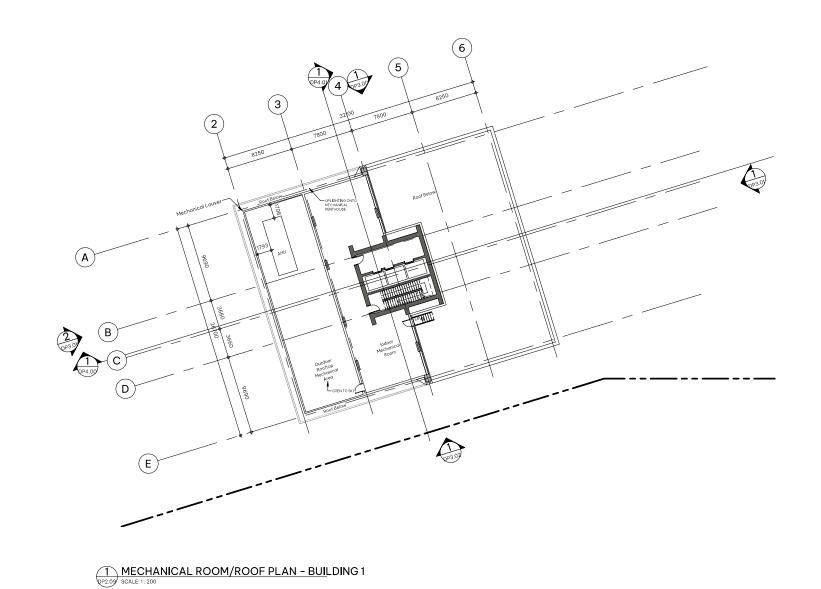

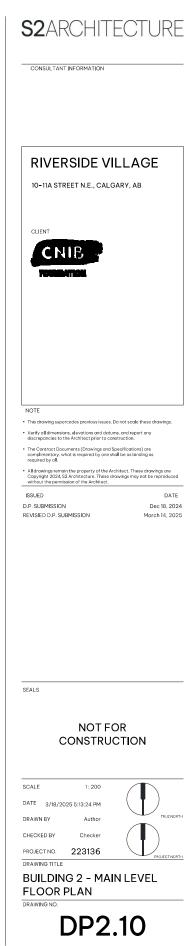


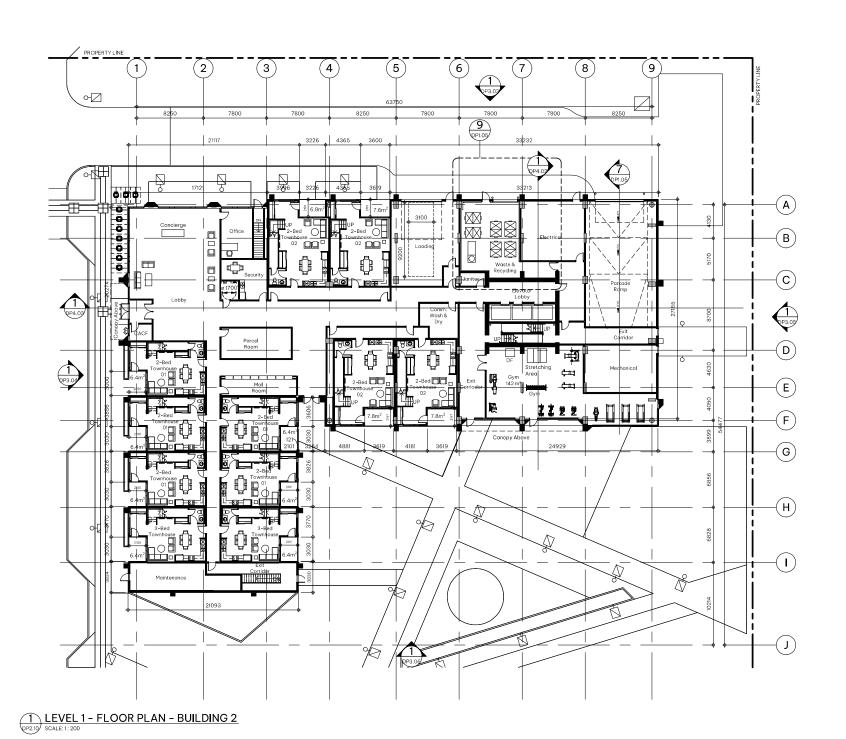


025\_0

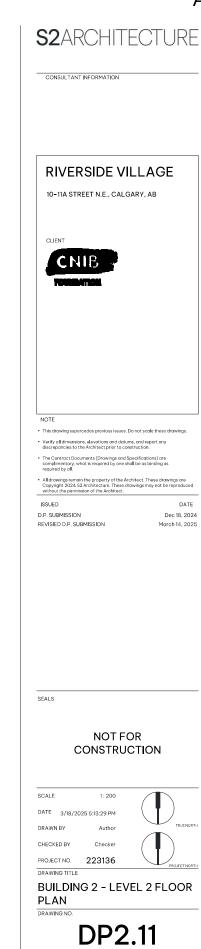


March 14, 2025

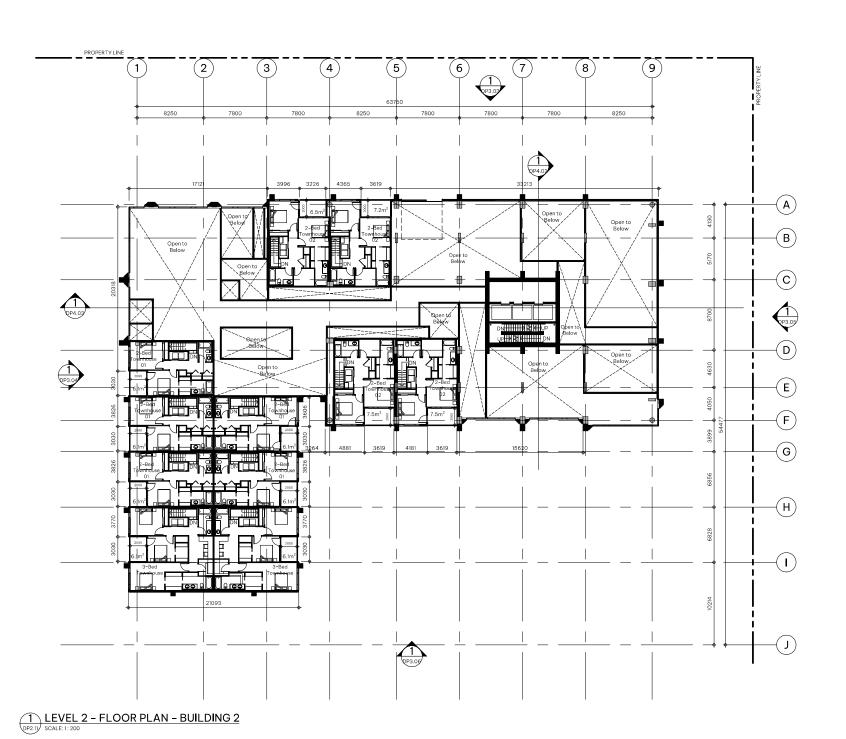


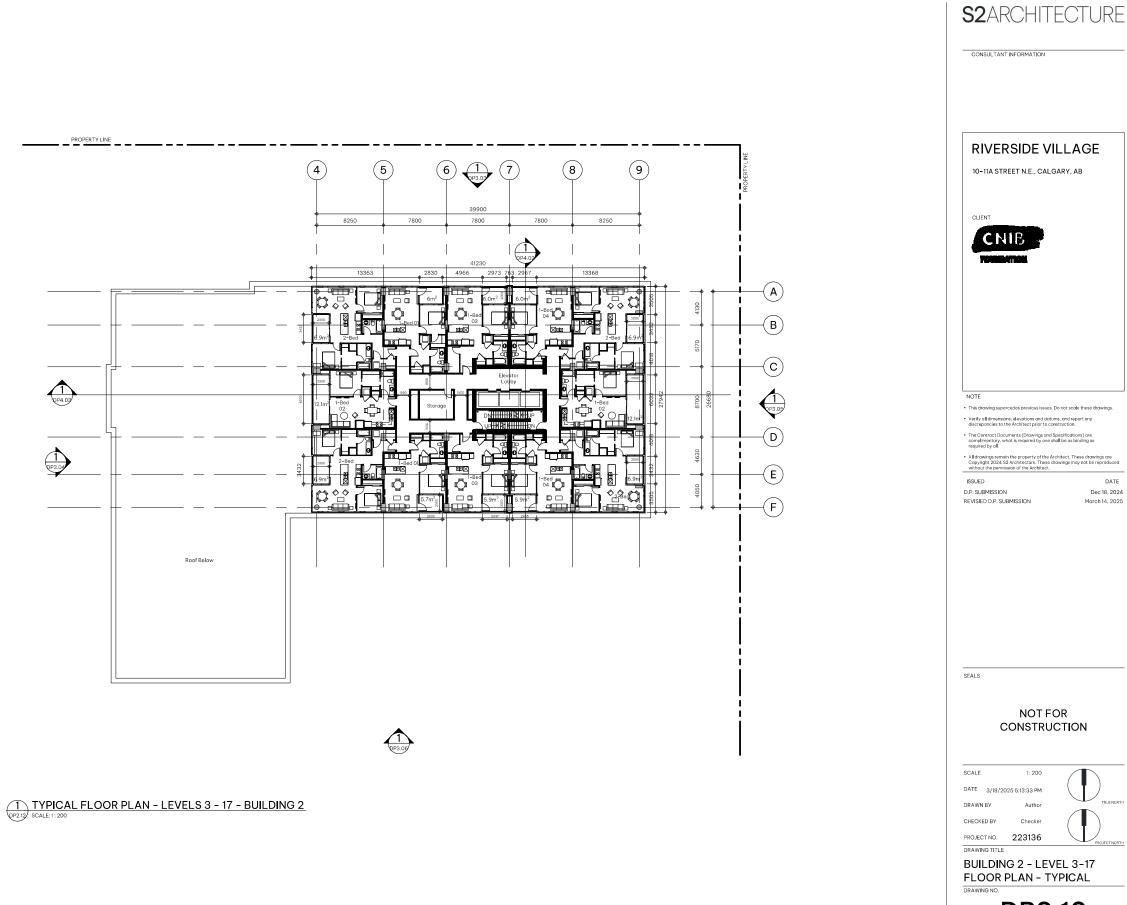



**DP2.12** 

March 14, 2025

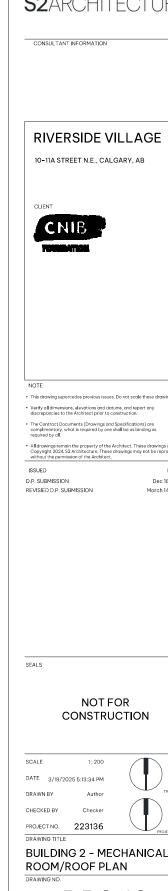

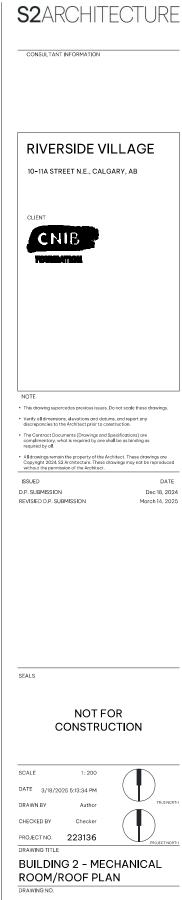

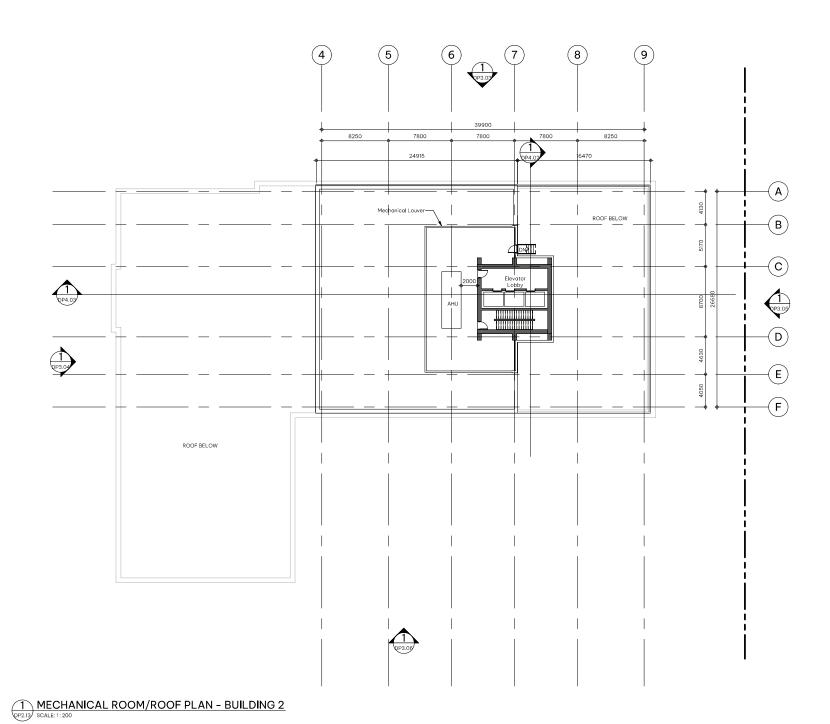

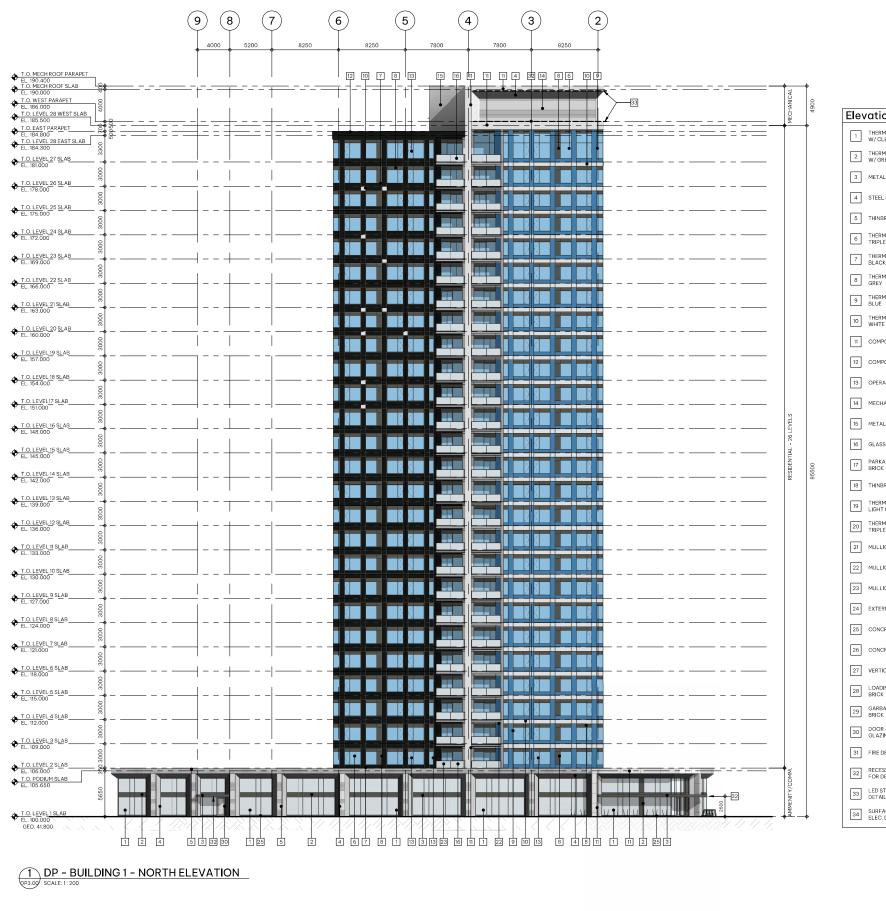

Elevation - Code Legend THERMALLY BROKEN ALUMINUM SHOP FRONT FRAMING W/ GREY SPANDREL 3 METAL CANOPY - TO MATCH GREY SPANDREL 4 STEEL FRAME 5 THINBRICK -WHITE 11 COMPOSITE METAL PANEL - WHITE 12 COMPOSITE METAL PANEL - BLACK 13 OPERABLE WINDOW 14 MECHANICAL LOUVERS - PAINTED TO MATCH BRICK 15 METAL PANEL - WHITE 16 GLASS GUARDRAIL - CLEAR GLAZING PARKADE O/H EXTERNAL DOOR - PAINTED TO MATCH BRICK 18 THINBRICK REVEAL - LIGHT GREY THERMALLY BROKEN ALUMINUM GLAZING SYSTEM TRIPLEPANE CLEAR GLASS 21 MULLION CAP - BLUE 22 MULLION CAP - WHITE 23 MULLION CAP - BLACK 24 EXTERNAL STEEL DOOR - PAINTED TO MATCH BRICK 25 CONCRETE CURB 26 CONCRETE PLANTER 27 VERTICAL SIDING - METAL CLAD WOOD - GREY 30 DOOR - ALUMINUM TO MATCH GREY SPANDREL W/ CLEAF GLAZING 31 FIRE DEPARTMENT CONNECTION 23 LED STRIP FEATURE LIGHT - REF. TO ELEC. DRAWINGS FOI DETAILS 34 SURFACE/WALL MOUNTED DOWNLIGHTING - REF. TO ELEC. DRAWINGS FOR DETAILS

**S2**ARCHITECTURE

CONSULTANT INFORMATION



Dec 18, 2024

REVISIED D.P. SUBMISSION March 14, 2025


SEALS


#### NOT FOR CONSTRUCTION

223136 DRAWING TITLE

**BUILDING 1 - NORTH ELEVATION** 

**DP3.00** 

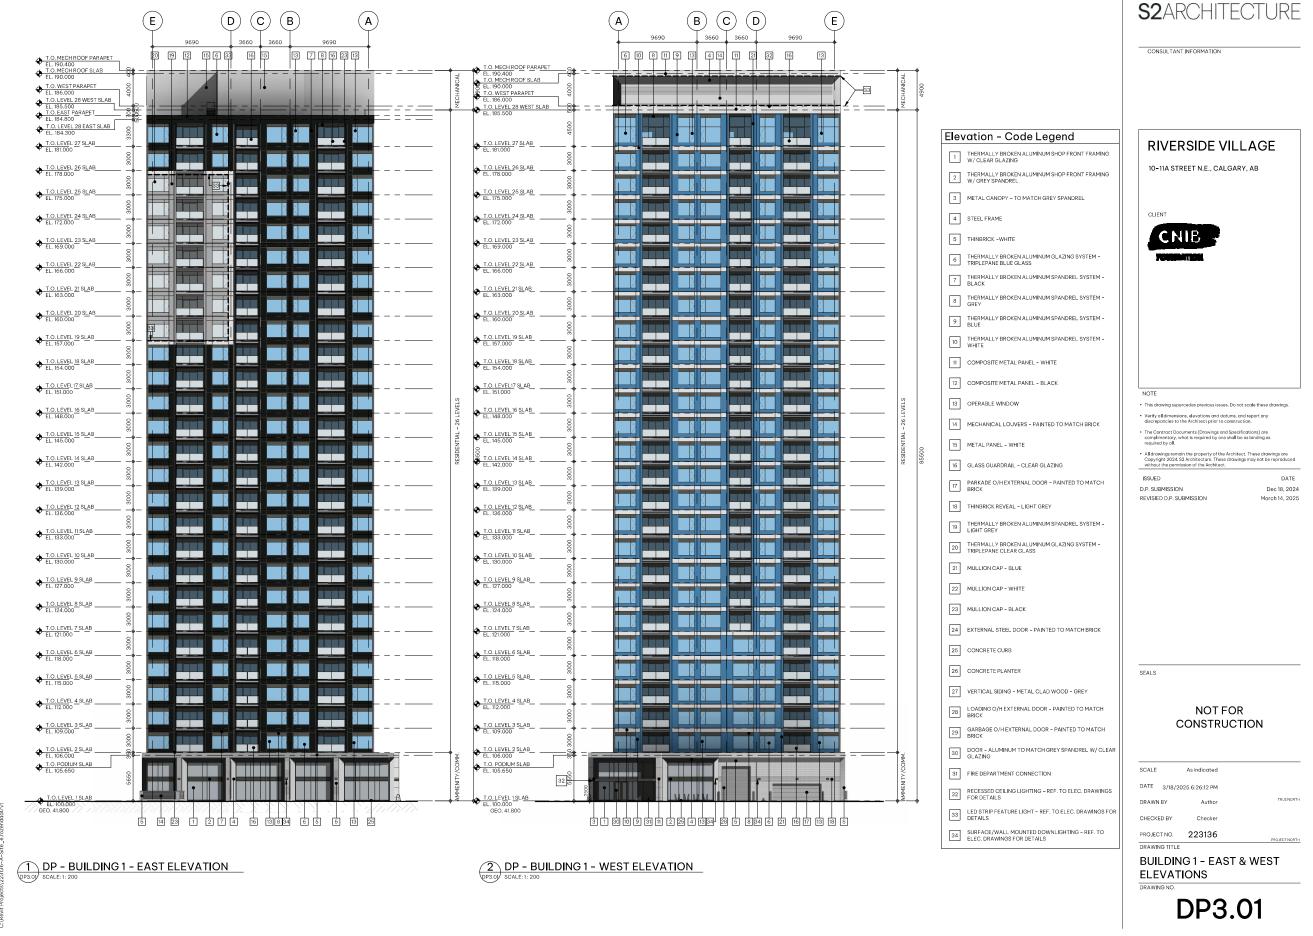

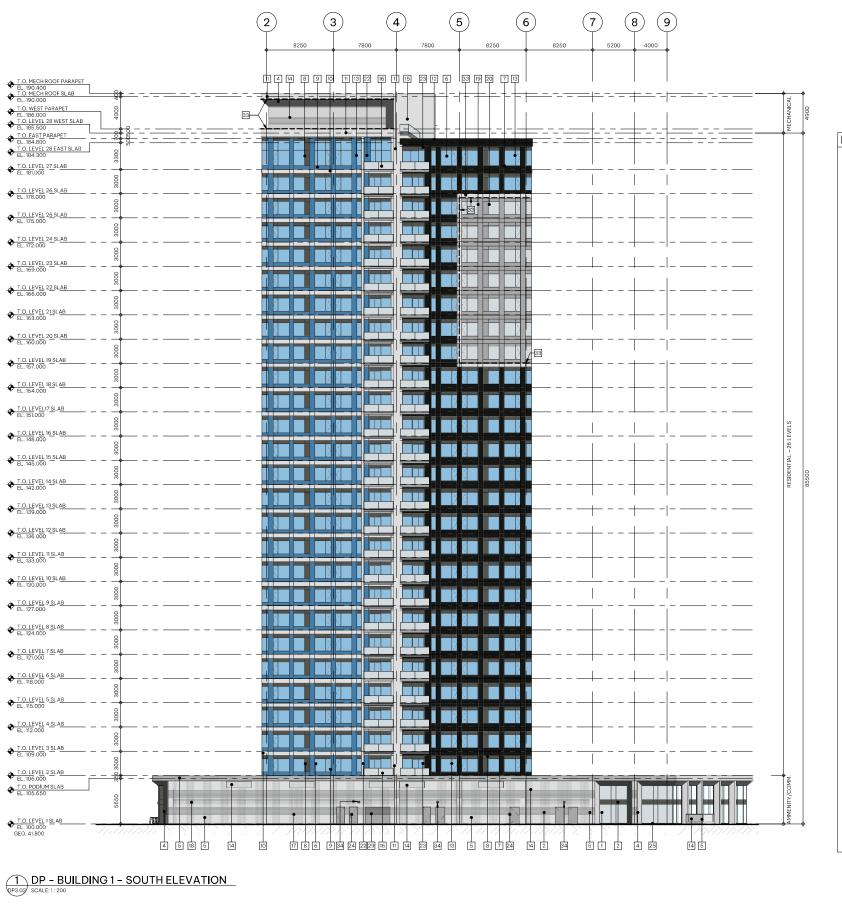

Elev	ation - Code Legend
1	THERMALLY BROKEN ALUMINUM SHOP FRONT FRAMING W/ CLEAR GLAZING
2	THERMALLY BROKEN ALUMINUM SHOP FRONT FRAMING W/ GREY SPANDREL
3	METAL CANOPY - TO MATCH GREY SPANDREL
4	STEEL FRAME
5	THINBRICK -WHITE
6	THERMALLY BROKEN ALUMINUM GLAZING SYSTEM - TRIPLEPANE BLUE GLASS
7	THERMALLY BROKEN ALUMINUM SPANDREL SYSTEM - BLACK
8	THERMALLY BROKEN ALUMINUM SPANDREL SYSTEM - GREY
9	THERMALLY BROKEN ALUMINUM SPANDREL SYSTEM - BLUE
10	THERMALLY BROKEN ALUMINUM SPANDREL SYSTEM - WHITE
11	COMPOSITE METAL PANEL - WHITE
12	COMPOSITE METAL PANEL - BLACK
13	OPERABLE WINDOW
14	MECHANICAL LOUVERS - PAINTED TO MATCH BRICK
15	METAL PANEL - WHITE
16	GLASS GUARDRAIL - CLEAR GLAZING
17	PARKADE O/H EXTERNAL DOOR - PAINTED TO MATCH BRICK
18	THINBRICK REVEAL - LIGHT GREY
19	THERMALLY BROKEN ALUMINUM SPANDREL SYSTEM - LIGHT GREY
20	THERMALLY BROKEN ALUMINUM GLAZING SYSTEM - TRIPLEPANE CLEAR GLASS
21	MULLION CAP - BLUE
22	MULLION CAP - WHITE
23	MULLION CAP - BLACK
24	EXTERNAL STEEL DOOR - PAINTED TO MATCH BRICK
25	CONCRETE CURB
26	CONCRETE PLANTER
27	VERTICAL SIDING - METAL CLAD WOOD - GREY
28	LOADING O/H EXTERNAL DOOR - PAINTED TO MATCH BRICK
29	GARBAGE O/H EXTERNAL DOOR - PAINTED TO MATCH BRICK
30	DOOR - ALUMINUM TO MATCH GREY SPANDREL W/ CLEAR GLAZING
31	FIRE DEPARTMENT CONNECTION
32	RECESSED CEILING LIGHTING - REF. TO ELEC, DRAWINGS

**S2**ARCHITECTURE

CONSULTANT INFORMATION



REVISIED D.P. SUBMISSION

March 14, 2025

SEALS


#### NOT FOR CONSTRUCTION

PROJECT NO. 223136 DRAWING TITLE

BUILDING 1 - SOUTH **ELEVATION** 

**DP3.02** 



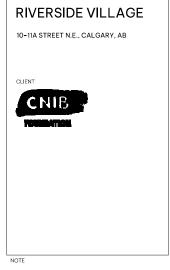

Elevation - Code Legend

3 METAL CANOPY - TO MATCH GREY SPANDREL

4 STEEL FRAME

5 THINBRICK - WHITE

11 COMPOSITE METAL PANEL - WHITE

12 COMPOSITE METAL PANEL - BLACK

16 GLASS GUARDRAIL - CLEAR GLAZING

18 THINBRICK REVEAL - LIGHT GREY

PARKADE O/H EXTERNAL DOOR - PAINTED TO MATCH BRICK

THERMALLY BROKEN ALUMINUM SPANDREL SYSTEM -LIGHT GREY

24 EXTERNAL STEEL DOOR - PAINTED TO MATCH BRICK

27 VERTICAL SIDING - METAL CLAD WOOD - GREY

34 SURFACE/WALL MOUNTED DOWNLIGHTING - REF. TO ELEC. DRAWINGS FOR DETAILS

31 FIRE DEPARTMENT CONNECTION

13 OPERABLE WINDOW

15 METAL PANEL - WHITE

21 MULLION CAP - BLUE 22 MULLION CAP - WHITE

23 MULLION CAP - BLACK

25 CONCRETE CURB 26 CONCRETE PLANTER

D.P. SUBMISSION REVISIED D.P. SUBMISSION March 14, 2025


SEALS

#### NOT FOR CONSTRUCTION

CHECKED BY PROJECT NO. 223136 DRAWING TITLE


BUILDING 2 - NORTH **ELEVATION** 

**DP3.03** 

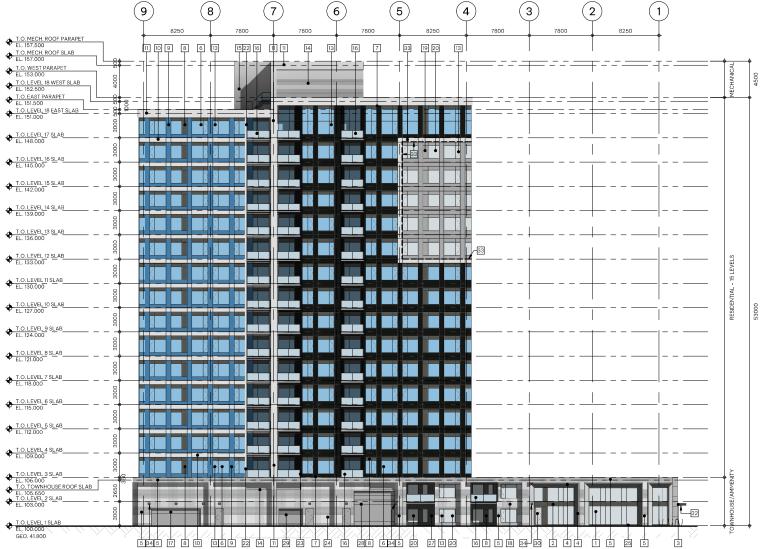

DP - BUILDING 2 - NORTH ELEVATION
SCALE: 1: 200



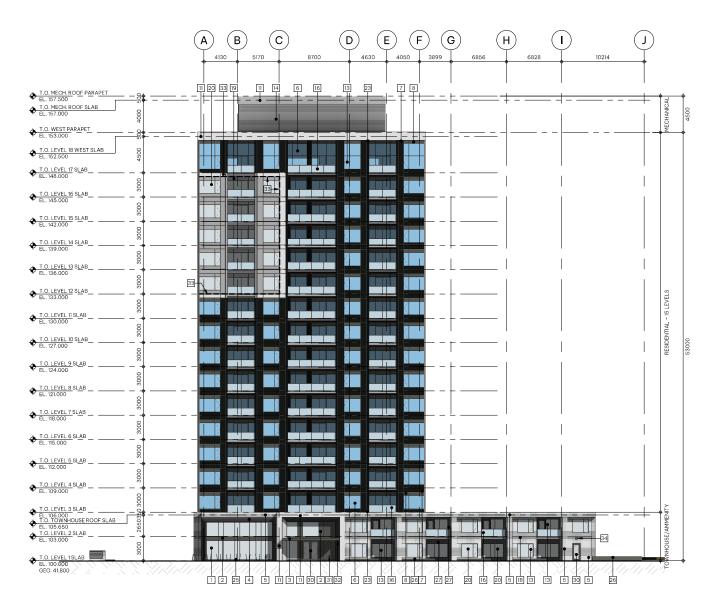

9 THERMALLY BROKEN ALUMINUM SPANDREL SYSTEM -BLUE 11 COMPOSITE METAL PANEL - WHITE 12 COMPOSITE METAL PANEL - BLACK 13 OPERABLE WINDOW 14 MECHANICAL LOUVERS - PAINTED TO MATCH BRICK 15 METAL PANEL - WHITE 16 GLASS GUARDRAIL - CLEAR GLAZING PARKADE O/H EXTERNAL DOOR - PAINTED TO MATCH BRICK 18 THINBRICK REVEAL - LIGHT GREY 19 THERMALLY BROKEN ALUMINUM SPANDREL SYSTEM -LIGHT GREY 21 MULLION CAP - BLUE 22 MULLION CAP - WHITE 23 MULLION CAP - BLACK 24 EXTERNAL STEEL DOOR - PAINTED TO MATCH BRICK 25 CONCRETE CURB 26 CONCRETE PLANTER 27 VERTICAL SIDING - METAL CLAD WOOD - GREY GARBAGE O/H EXTERNAL DOOR - PAINTED TO MATCH BRICK

31 FIRE DEPARTMENT CONNECTION

| 32 | RECESSED CELLING LIGHTING - REF. TO ELEC. DRAWINGS FOR DETAILS | LED STRIP FEATURE LIGHT - REF. TO ELEC. DRAWINGS FOI DETAILS |

34 SURFACE/WALL MOUNTED DOWNLIGHTING - REF. TO ELEC. DRAWINGS FOR DETAILS

Elevation - Code Legend

3 METAL CANOPY - TO MATCH GREY SPANDREL

4 STEEL FRAME

5 THINBRICK - WHITE

THERMALLY BROKEN ALUMINUM SHOP FRONT FRAMING W/ CLEAR GLAZING

7 THERMALLY BROKEN ALUMINUM SPANDREL SYSTEM - BLACK



all dimensions, elevations and datums, and report any spancies to the Architect prior to construction.

discrepancies to the Architect prior to construction.

complimentary, what is required by one shall be as binding as required by all.

 All drawings remain the property of the Architect. These drawings are Copyright 2024, S2 Architecture. These drawings may not be reproduced without the permission of the Architect.

 ISSUED
 DATE

 D.P. SUBMISSION
 Dec 18, 2024

 REVISIED D.P. SUBMISSION
 March 14, 2025

SEALS

## NOT FOR CONSTRUCTION

SCALE As indicated

DATE 3/18/2025 6:29:07 PM

DRAWN BY Author TRUENORTH

CHECKED BY Checker

PROJECT NO. 223136

PROJECT NO. 10 PROJECT NORTH

DRAWNS TITLE

BUILDING 2 - WEST ELEVATION

DP3.04

1 DP - BUILDING 2 - WEST ELEVATION
SCALE: 1: 200



CONSULTANT INFORMATION



Elevation - Code Legend THERMALLY BROKEN ALUMINUM SHOP FRONT FRAMING W/CLEAR GLAZING 3 METAL CANOPY - TO MATCH GREY SPANDREL 4 STEEL FRAME 5 THINBRICK -WHITE 6 THERMALLY BROKEN ALUMINUM GLAZING SYSTEM -TRIPLEPANE BLUE GLASS 7 THERMALLY BROKEN ALUMINUM SPANDREL SYSTEM - BLACK 11 COMPOSITE METAL PANEL - WHITE 12 COMPOSITE METAL PANEL - BLACK 13 OPERABLE WINDOW 14 MECHANICAL LOUVERS - PAINTED TO MATCH BRICK 15 METAL PANEL - WHITE 16 GLASS GUARDRAIL - CLEAR GLAZING PARKADE O/H EXTERNAL DOOR - PAINTED TO MATCH BRICK 18 THINBRICK REVEAL - LIGHT GREY 19 THERMALLY BROKEN ALUMINUM SPANDREL SYSTEM -LIGHT GREY THERMALLY BROKEN ALUMINUM GLAZING SYSTEM -TRIPLEPANE CLEAR GLASS 21 MULLION CAP - BLUE 22 MULLION CAP - WHITE 23 MULLION CAP - BLACK 24 EXTERNAL STEEL DOOR - PAINTED TO MATCH BRICK 25 CONCRETE CURB 26 CONCRETE PLANTER 27 VERTICAL SIDING - METAL CLAD WOOD - GREY 28 LOADING O/H EXTERNAL DOOR - PAINTED TO MATCH BRICK 31 FIRE DEPARTMENT CONNECTION 32 RECESSED CEILING LIGHTING - REF. TO ELEC, DRAWINGS FOR DETAILS

33 LED STRIP FEATURE LIGHT - REF. TO ELEC. DRAWINGS FOR DETAILS

34 SURFACE/WALL MOUNTED DOWNLIGHTING - REF. TO ELEC. DRAWINGS FOR DETAILS

RIVERSIDE VILLAGE 10-11A STREET N.E., CALGARY, AB CNIB

REVISIED D.P. SUBMISSION March 14, 2025

SEALS

#### NOT FOR CONSTRUCTION

CHECKED BY PROJECT NO. 223136 DRAWING TITLE


**BUILDING 2 - EAST ELEVATION** 

**DP3.05** 





CONSULTANT INFORMATION

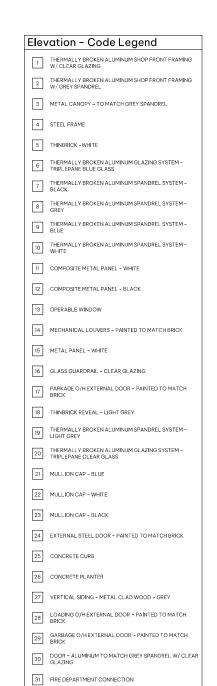

LED STRIP FEATURE LIGHT - REF. TO ELEC. DRAWINGS FOR DETAILS

SURFACE/WALL MOUNTED DOWNLIGHTING - REF. TO ELEC. DRAWINGS FOR DETAILS

34

ELEC. DRAWINGS FOR DETAILS




SEALS

### NOT FOR CONSTRUCTION


DRAWIN	NG TITLE	CO COUTU	
PROJEC		223136	PROJECT NORTH
CHECK	ED BY	Checker	
DRAWN	IBY	Author	TRUENORTH
DATE	3/18/20	25 6:30:07 PM	
SCALE		As indicated	

BUILDING 2 - SOUTH ELEVATION

DP3.06

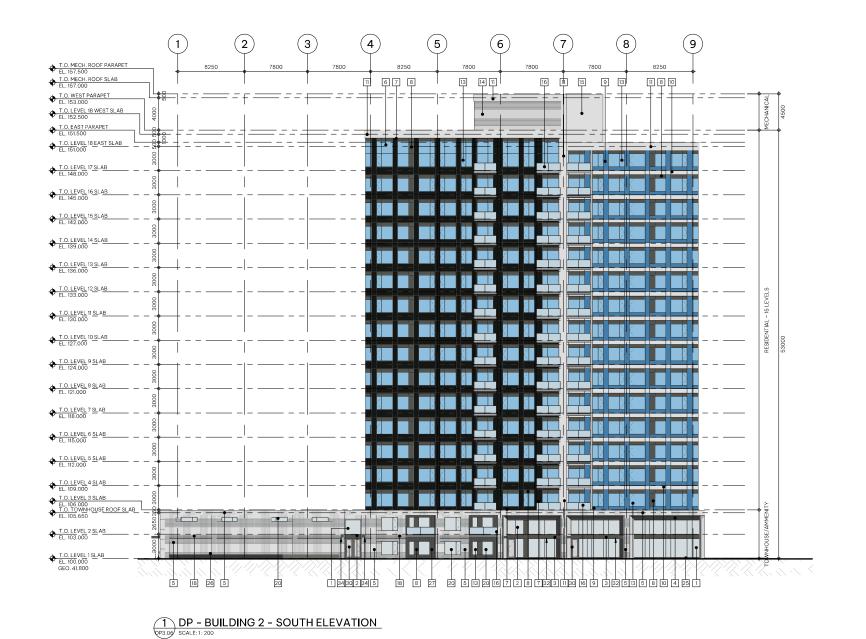


Projects\223136-A-Site\_e.rozendaal.rv

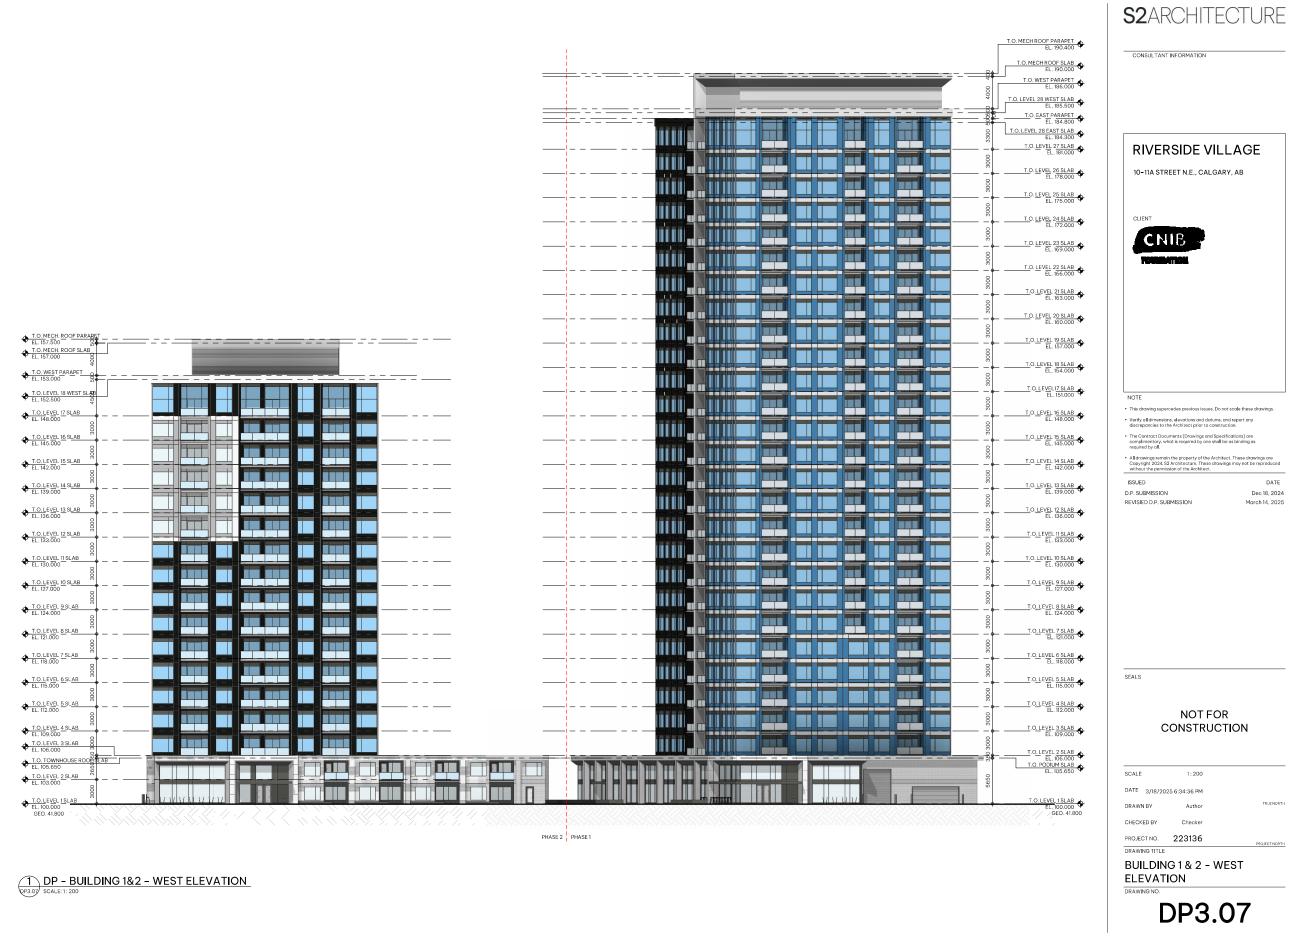

RIVERSIDE VILLAGE

10-11A STREET N.E., CALGARY, AB

CONSULTANT INFORMATION

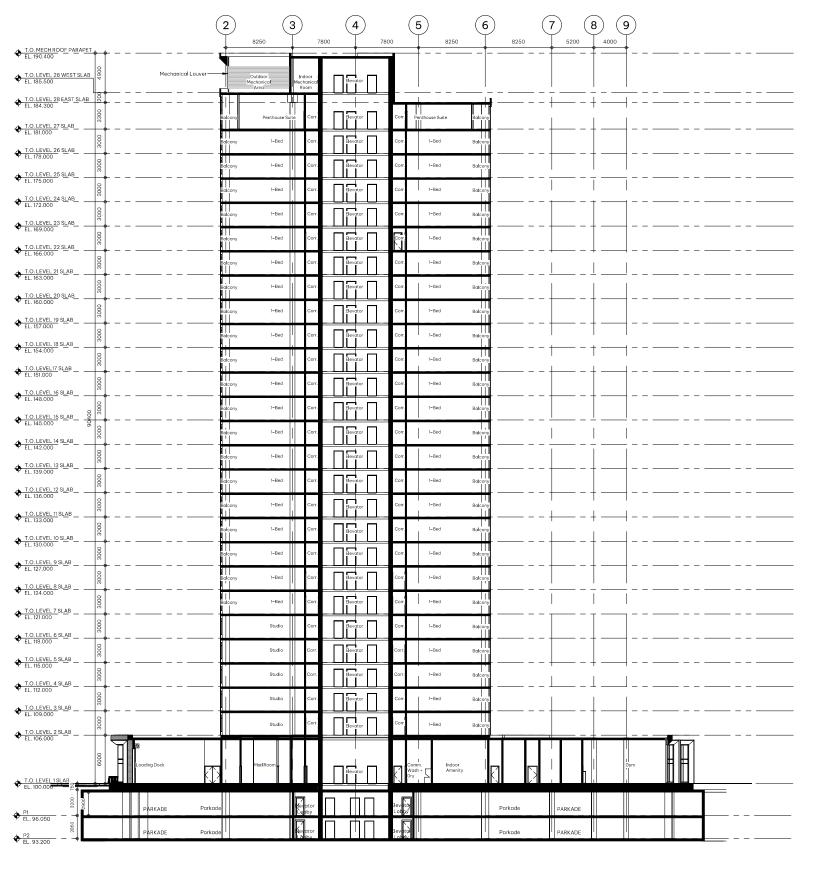


CNIB FOUNDATION Dec 18, 2024 March 14, 2025 D.P. SUBMISSION REVISIED D.P. SUBMISSION SEALS NOT FOR CONSTRUCTION DATE 3/20/2025 3:18:30 PM PROJECT NO. 223136 DRAWING TITLE BUILDING 1 - SECTION 1


**DP4.00** 

DP - BUILDING 1 - SECTION 1

SCALE:1:200

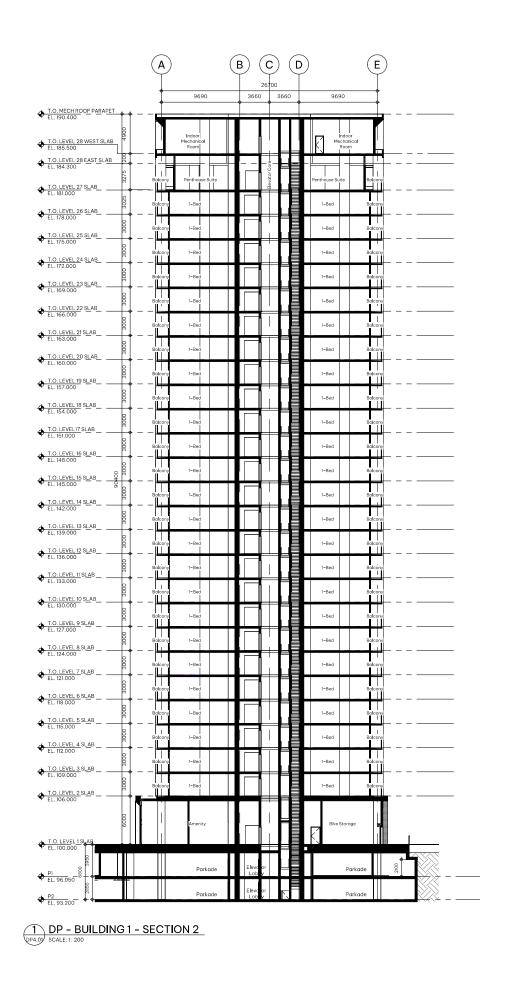

CONSULTANT INFORMATION

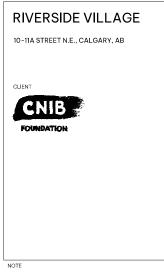

This drawing supercedes previous issues. Do not scale these draw

 Verify all dimensions, elevations and datums, and report discrepancies to the Architect prior to construction.

 The Contract Documents (Drawings and Specifications) are complimentary, what is required by one shall be as binding as required by all.

 All drawings remain the property of the Architect. These drawings are Copyright 2024, S2 Architecture. These drawings may not be reproduced

 ISSUED
 DATE

 D.P. SUBMISSION
 Dec 18, 2024

 REVISIED D.P. SUBMISSION
 March 14, 2025

SEALS

### NOT FOR CONSTRUCTION

 SGALE
 1:200

 DATE
 3/20/2025 3:18:38 PM

 DRAWN BY
 Author

 CHECKED BY
 Checker


 PROJECT NO.
 223136


 DRAWING TITLE
 FROJECT NORTH

BUILDING 1 - SECTION 2

DRAWING NO.

DP4.01

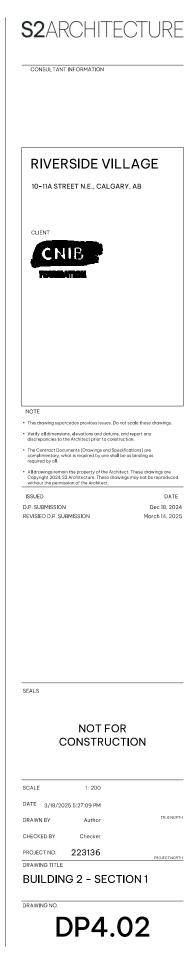


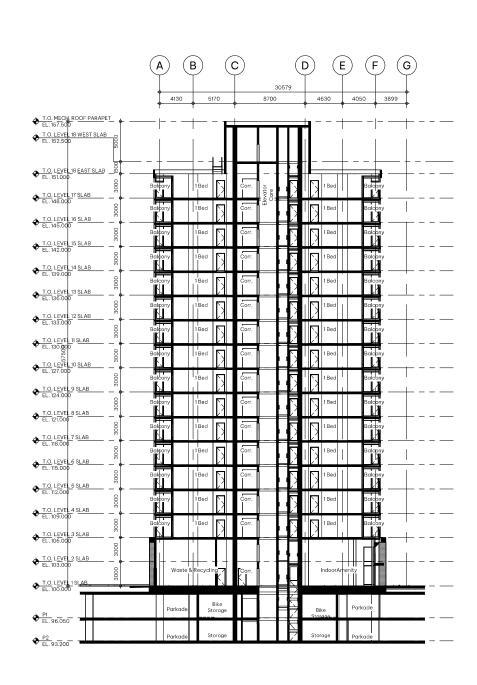


DP - BUILDING 2 - SECTION 1

Pr4.02 SCALE:1:200

C:\Rewit Projects\223136\_A\_Site\_ero

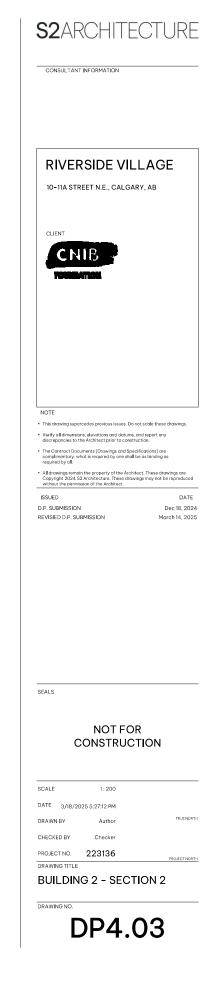

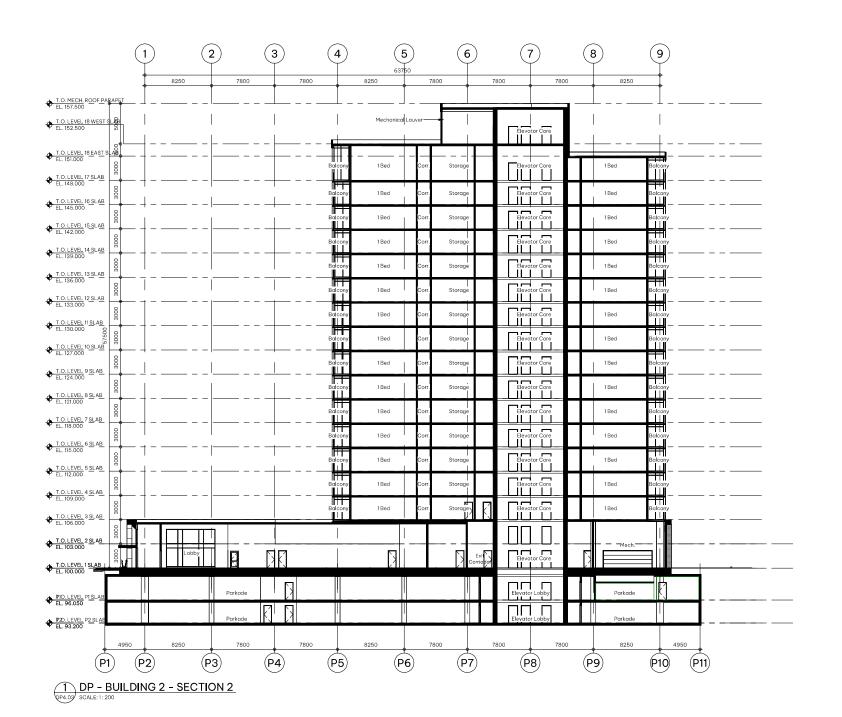

Projects\223136-A-Site\_e.rozendaa



YLINE DAY



SKYLINE NIGH

CONSULTANT INFORMATION

#### RIVERSIDE VILLAGE

10-11A STREET N.E., CALGARY, AB

CLIENT



NOT

- This drawing supercedes previous issues. Do not scale these draw
- Verify all dimensions, elevations and datums, and report discrepancies to the Architect prior to construction.
- The Contract Documents (Drawings and Specifications) are complimentary, what is required by one shall be as binding as
- All drawings remain the property of the Architect. These drawings are Copyright 2024, \$2 Architecture. These drawings may not be reproduced.

ISSUED D

D.P. SUBMISSION Dec 18, 202
REVISIED D.P. SUBMISSION March 14, 202

SEALS

# NOT FOR CONSTRUCTION

E 3/18/2025 6:34:37 PM

ID DV Chacker

PROJECT NO. 223136

PROJECT RENDERING - AERIAL PERSPECTIVE - SKYLINE

DRAWING NO.



BUILDING 1 - MAIN ENTRY (LOOKING SOUTH)



BUILDING 1 - SOUTH PEDESTRIAN WALKWAY (LOOKING WEST)

CONSULTANT INFORMATION

RIVERSIDE VILLAGE

10-11A STREET N.E., CALGARY, AB



REVISIED D.P. SUBMISSION

SEALS

## NOT FOR CONSTRUCTION

PROJECT NO. 223136 DRAWING TITLE

PROJECT RENDERING -BUILDING 1



BUILDING 2 - MAIN ENTRY + SHARED STREET (LOOKING SW)



BUILDING 2 - TOWNHOUSE UNITS (LOOKING NORTH)

CONSULTANT INFORMATION

#### RIVERSIDE VILLAGE

10-11A STREET N.E., CALGARY, AB

CLIENT



NOT

- This drawing supercedes previous issues. Do not scale these draw
- Verify all dimensions, elevations and datums, and report discrepancies to the Architect prior to construction.
- The Contract Documents (Drawings and Specifications) a complimentary, what is required by one shall be as binding
- All drawings remain the property of the Architect. These drawings are Copyright 2024, S2 Architecture. These drawings may not be reproduce

Copyright 2024, S2 Architecture. These drawings may not be reproduce without the permission of the Architect.

D.P. SUBMISSION Dec 18, 2024
REVISIED D.P. SUBMISSION March 14, 2025

SEALS

## NOT FOR CONSTRUCTION

----

ATE 3/18/2025 6:34:39 PN

IBY Author

PROJECT NO. 223136

DRAWING TITLE

PROJECT RENDERING -BUILDING 2

DRAWING NO.



OUTDOOR COMMON AMENITY - WEST ACCESS (LOOKING EAST)




OUTDOOR COMMON AMENITY - EAST ACCESS (LOOKING WEST)



OUTDOOR COMMON AMENITY - CENTRAL (LOOKING SOUTH)



CONSULTANT INFORMATION

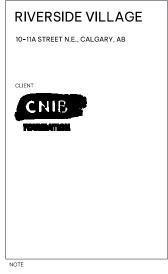


REVISIED D.P. SUBMISSION


SEALS

## NOT FOR CONSTRUCTION


PROJECT NO. 223136 DRAWING TITLE


PROJECT RENDERING -OUTDOOR COMMON AMENITY

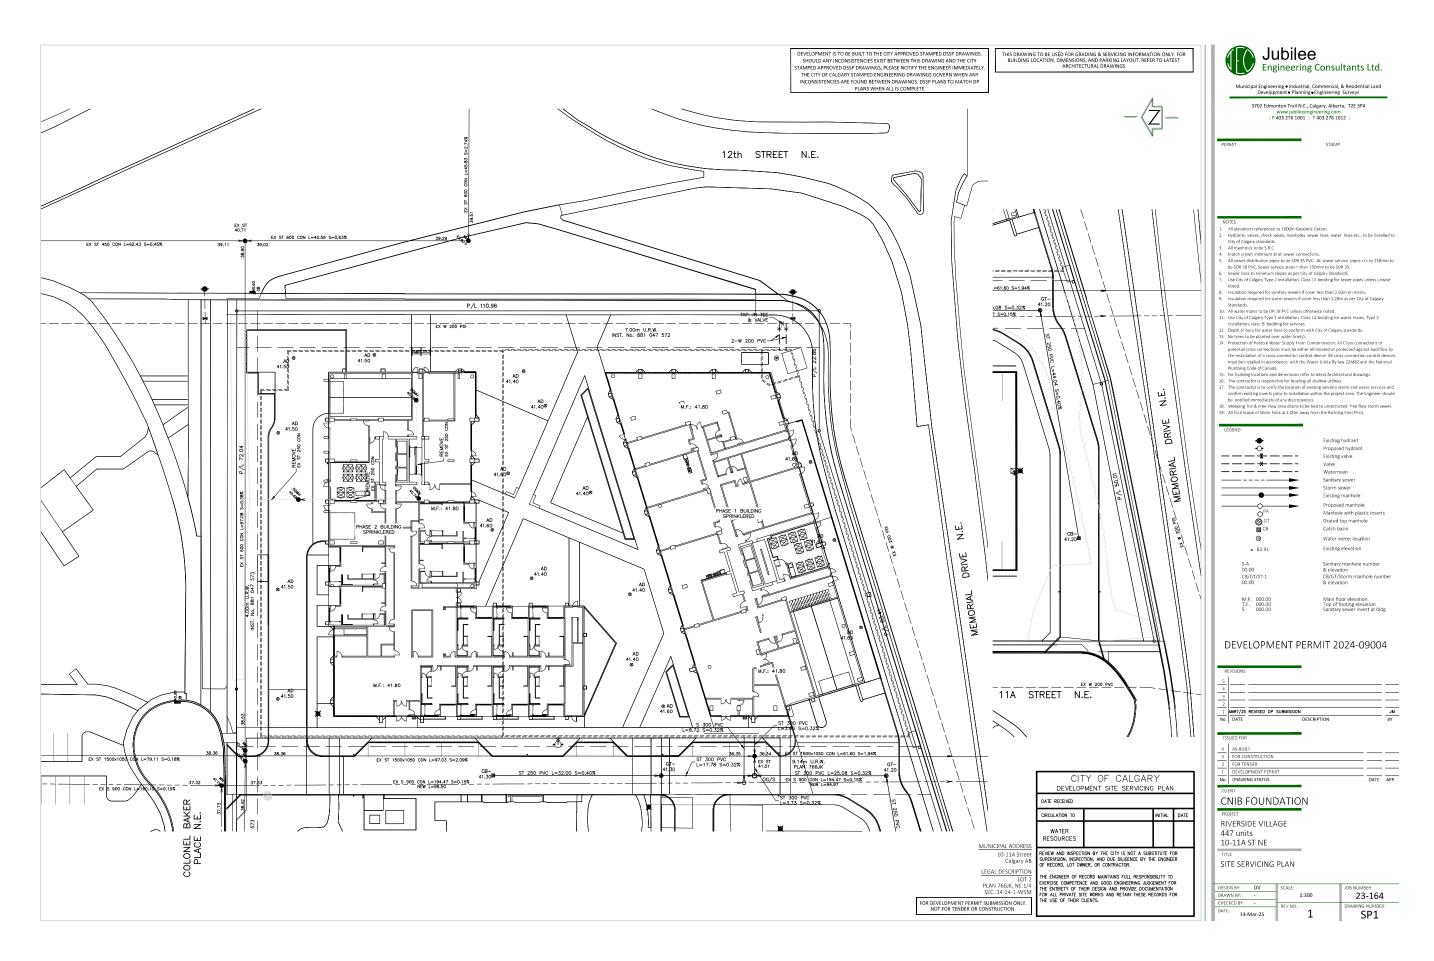


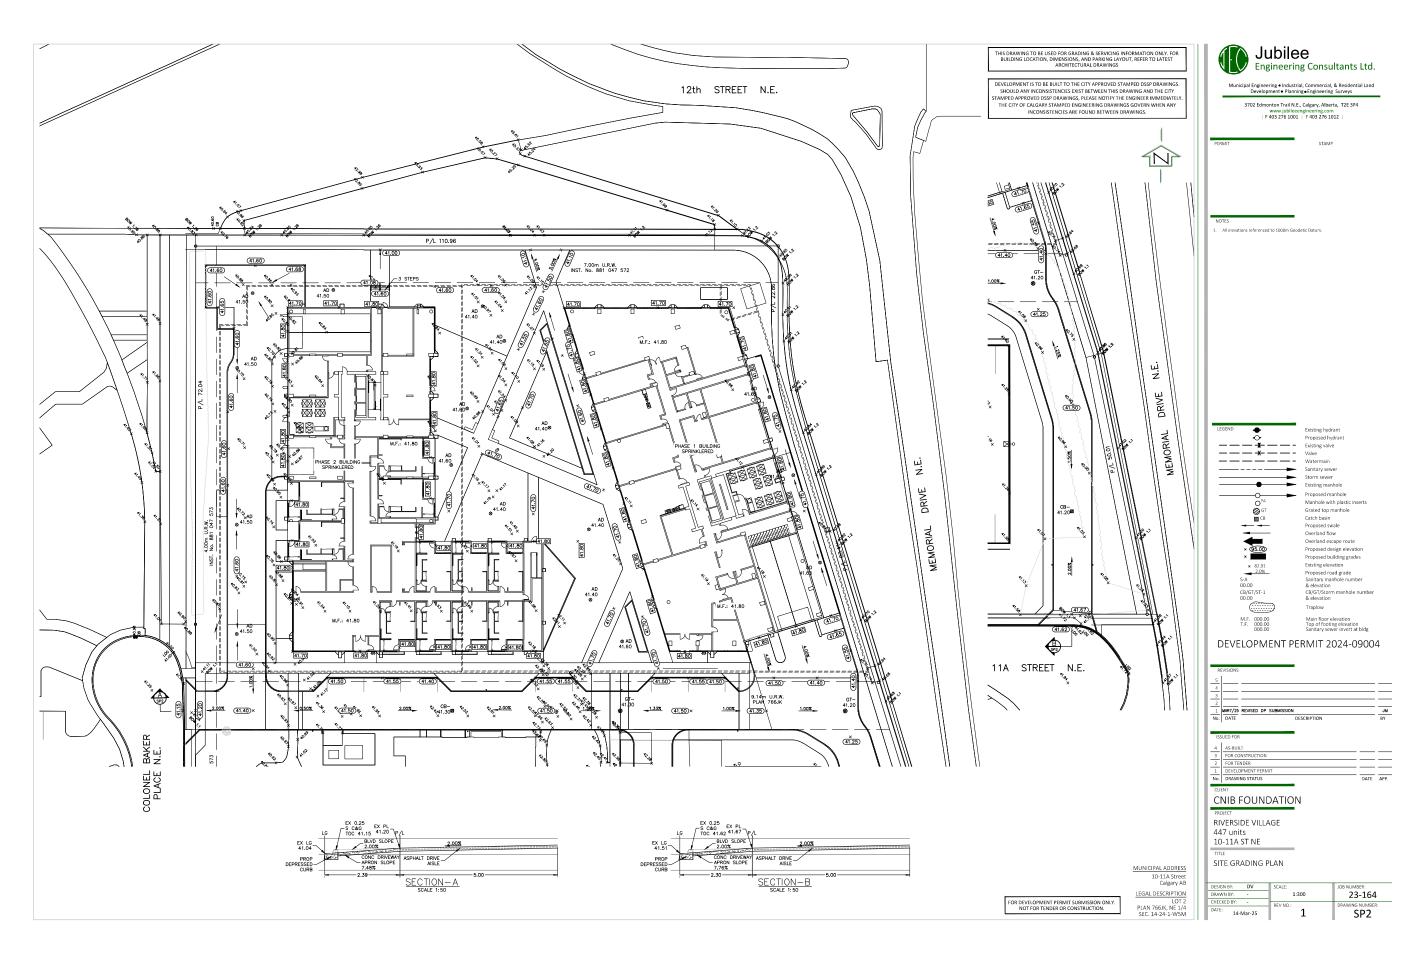




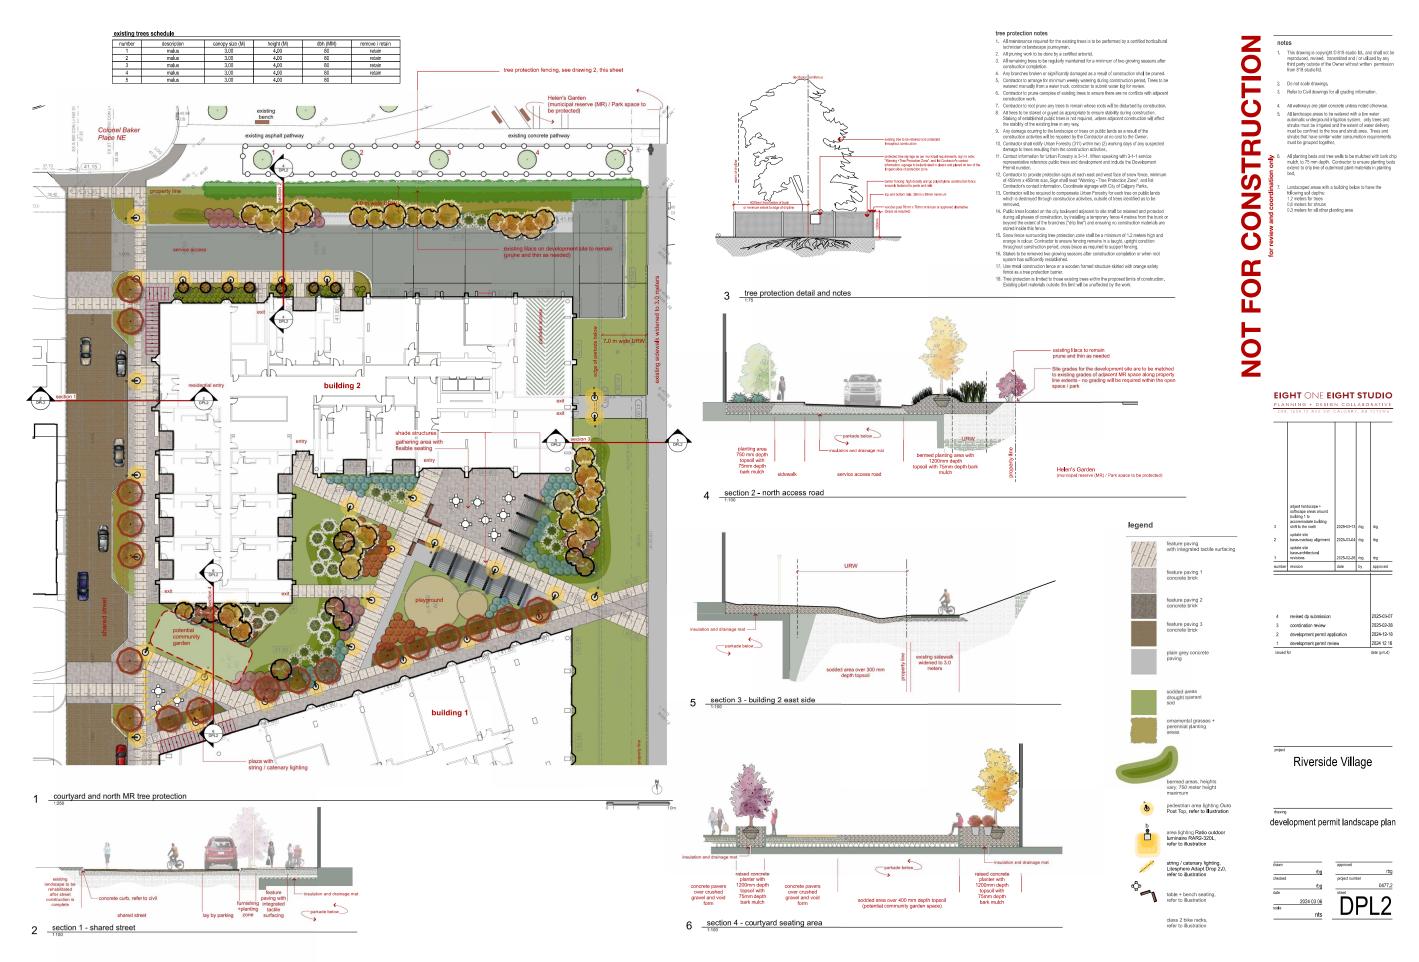


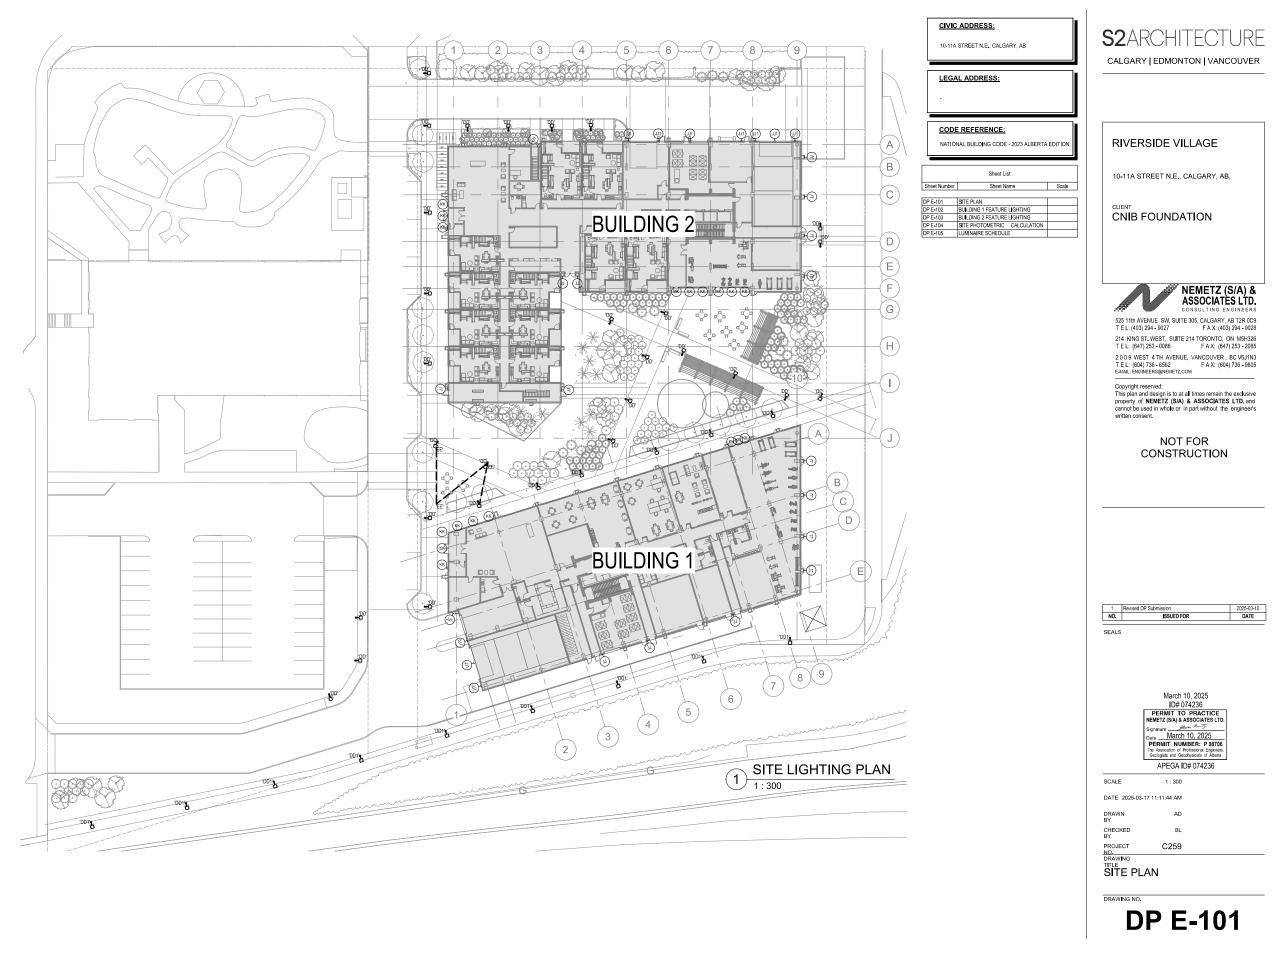

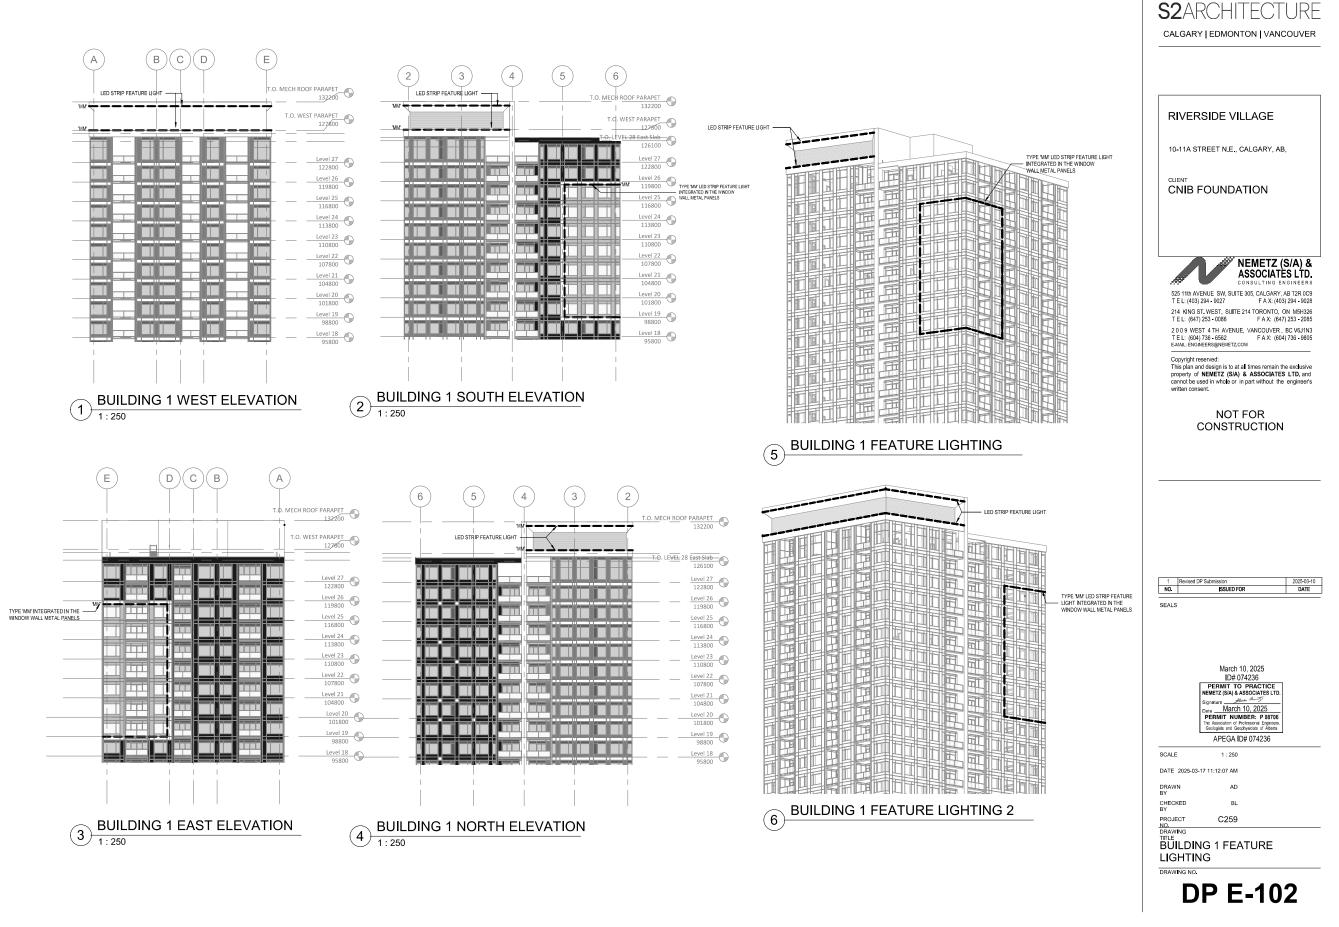

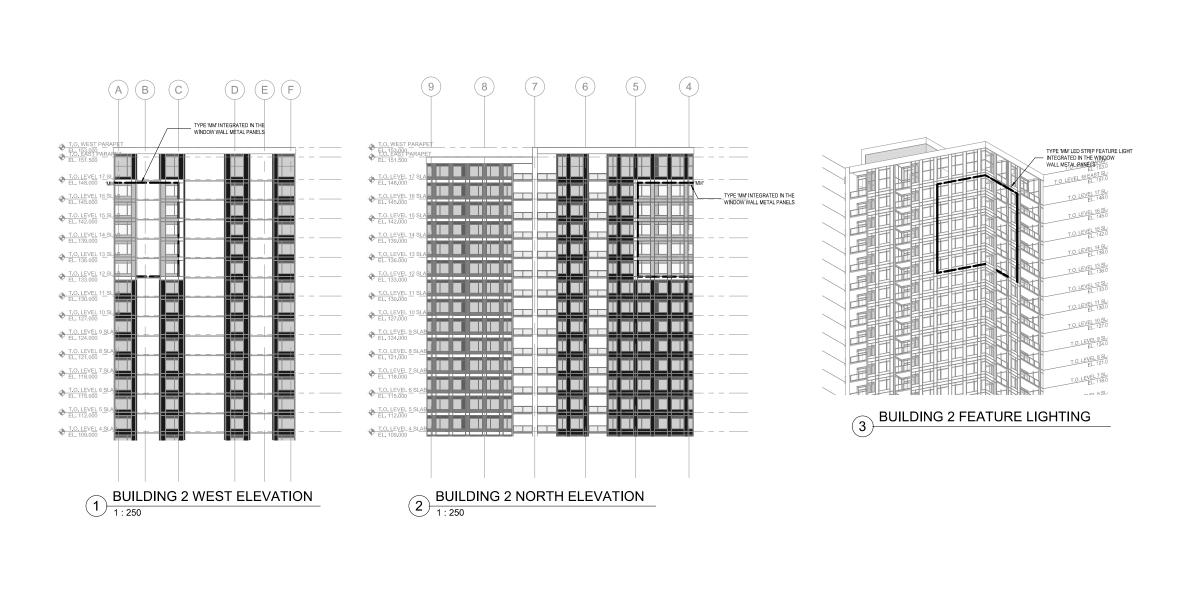



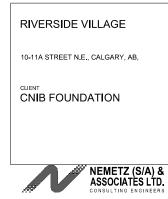

525 11th AVENUE SW, SUITE 305, CALGARY, AB T2R 0C9 TE L: (403) 294 - 9027 F A X: (403) 294 - 9027 F A X: (403) 294 - 9028 F A X: (403) 294 - 9028 F A X: (407) 253 - 2085 F A X: (604) 736 - 9805 E AMAL ENGREERS@HEMETZ.COM

E-MAIL: BAGNEERS@NEMETZ.COM

Copyright reserved:
This plan and design is to at all times remain the exclusive property of NEMETZ (S/A) & ASSOCIATES LTD. and cannot be used in whole or in part without the engineer's written consent.

NOT FOR CONSTRUCTION

March 10, 2025

ID# 074236

PERMIT TO PRACTICE

NEMEZ (S/A) & ASSOCIATES LTD.

Signature

March 10, 2025

PERMIT NUMBER: P 08706

The Association of Professoral Engineers

Colonigate of Geothylociation of Alberts

Obligation of Geothylociation of Alberts

Obligation of Contemplessor of Alberts

Obligation of Contemplessor of Alberts

APEGA ID# 074236

SCALE 1: 250


DATE 2025-03-17 11:12:15 AM

DRAWN AD
BY
CHECKED BL
BY
PROJECT C259
NO.

BUILDING 2 FEATURE LIGHTING

DRAWING NO.

**DP E-103** 

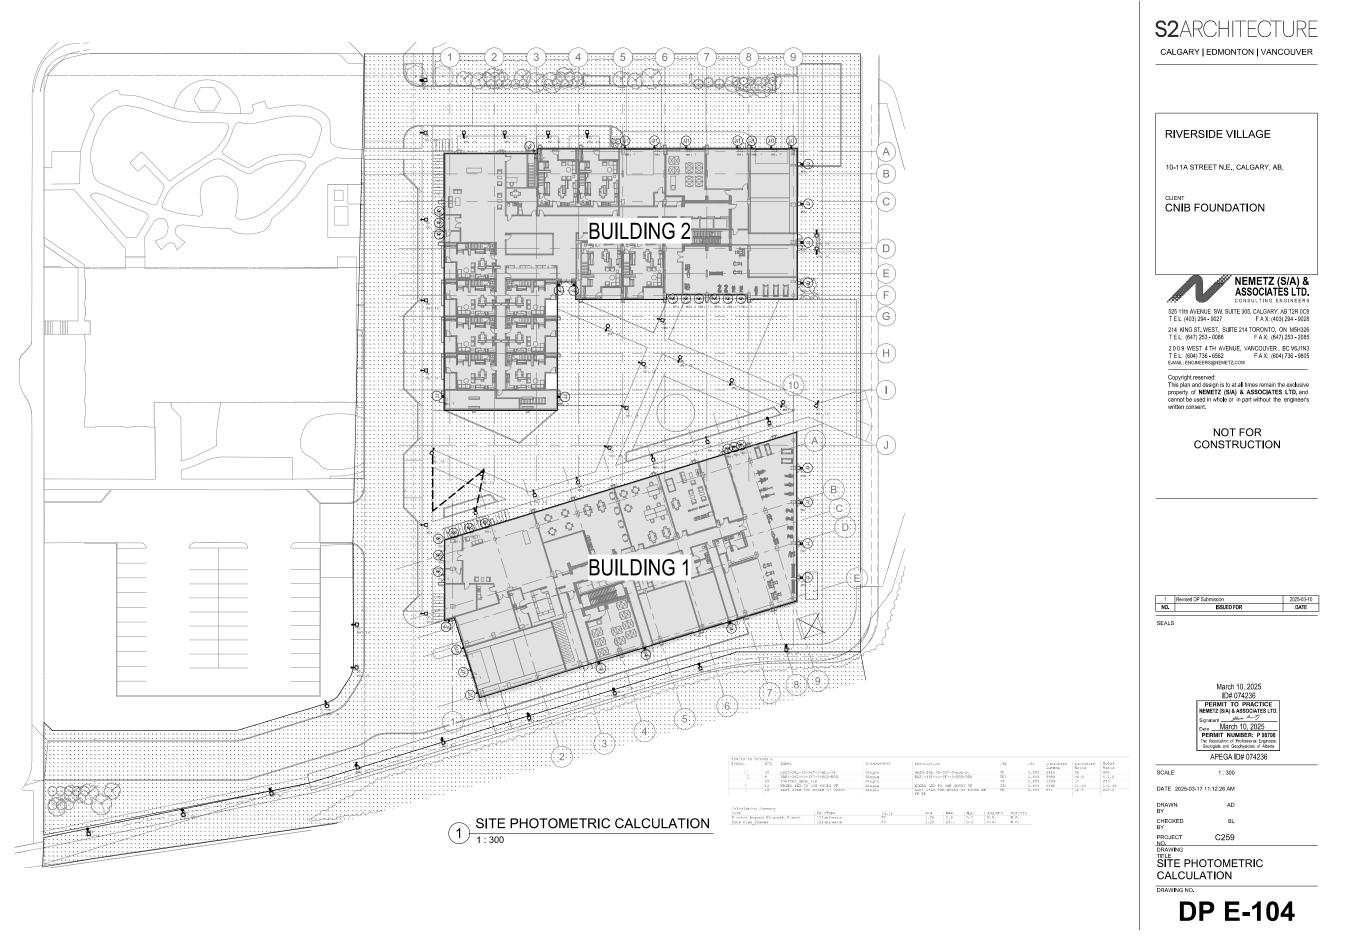

S2AR	CHITE	CTURE
CALGARY	EDMONTON	VANCOUVER

#### RIVERSIDE VILLAGE

10-11A STREET N.E., CALGARY, AB,

CNIB FOUNDATION

NEMETZ (S/A) & ASSOCIATES LTD.
CONSULTING ENGINEERS

525 11th AVENUE SW, SUITE 305, CALGARY, AB T2R 0C9 T E L: (403) 294 - 9027 F A X: (403) 294 - 9028 214 KING ST. WEST, SUITE 214 TORONTO, ON M5H326 T E L: (647) 253 - 0086 F A X: (647) 253 - 2085

2009 WEST 4TH AVENUE, VANCOUVER, BC V6J1N3 TEL: (604) 736 - 6562 FAX: (604) 736 - 9805 E-MAIL: ENGINEERS@NEMETZ.COM

Copyright reserved:
This plan and design is to at all times remain the exclusive property of NEMETZ (SIA) & ASSOCIATES LTD, and cannot be used in whole or in part without the engineer's written consent.

#### NOT FOR CONSTRUCTION

NO.	1 Revised DP Submission	
	ISSUED FOR	DATE
SEALS		
	March 10, 20 ID# 07423 PERMIT TO PAR NEMETZ (SA) & ASSOC Signature March 10, 2 PERMIT NUMBER: The Association of Professor Geologists and Geotypoists	CTICE IATES LTD.  1025 IP 08706 Ial Engineers.
	APEGA ID# 07	4236
SCALE		
DATE	2025-03-17 11:12:27 AM	
DRAW BY	N AD	
CHEC	ED BL	
BY	ст С259	

**DP E-105** 

LUMINAIRE SCHEDULE C259
<u>otes</u>
1. LIGHTING IS DESIGNED TO COMPLY WITH ENERGY CODE. THE CONTRACTOR SHALL NOT CHANGE LIGHTING WITHOUT ENGINEERS APPROVAL.
<ol> <li>PARKADE LIGHTING LOCATED IN SPRAY-ON INSULATION SHALL BE SET DOWN TO CLEAR THE INSULATION.         INSTALLATION OF ALL PARKADE LIGHTING FIXTURES TO BE CLEAR OF ALL OBSTRUCTIONS IN ORDER TO MAINTAIN PROPER LIGHT LEVELS. MINIMUM CLEAR HEIGHT FOR LIGHT FIXTURE</li> <li>TO BE 7'-6" (2.3m) ABOVE HANDICAP PARKING STALLS AND ACCESS ROUTE TO HANDICAP PARKING STALLS; 7'-0" (2.1m) ABOVE REGULAR STALLS AND DRIVEWAYS, UP TO 12'-0" (3.6m)         MAXIMUM. WHERE THE MINIMUM HEIGHT ABOVE STALLS IS NOT ATTAINABLE. WIRE GUARDS MUST BE USED. ALL LIGHT FIXTURES ABOVE DRIVE AISLES REQUIRE WIREGUARD PER C.E.C.</li> <li>LIGHTING IN MECHANICAL ROOMS, SERVICE ROOMS, CORRIDORS AND PARKADE TO BE SUSPENDED AS NECESSARY TO CLEAR MECHANICAL LINES AND DUCTS.</li> </ol>
5, LIGHTING IN SPRINKLER MECHANICAL ROOMS AND ELECTRICAL ROOMS SHALL BE ON EM POWER.
6. SURFACE MOUNTED WALL LIGHTS SHALL NOT BE SET LOWER THAN 6'-8" (205mm) TO CENTER OF OUTLET BOX WITHOUT SPECIAL PERMISSION FROM ELECTRICAL INSPECTOR.
7. ALL RECESSED LIGHTS LOCATED IN INSULATED CEILINGS MUST BE SUPPLIED C/W I.C. RATED HOUSINGS.
ANY CONTRACTOR PROPOSED ALTERNATE LIGHT FIXTURE IN LIEU OF SPECIFIED SHALL BE SUBJECT OF APPROVAL BY THE DESIGNER AND ENGINEER. SUBMIT A BREAKDOWN OF COST 8. SHOWING THE NET DIFFERENCE TO THE DEDUCTED OR ADDED TO THE TENDER PRICE IF ACCEPTED. INCLUDE FOR AND ASSUME RESPONSIBILITY FOR ANY ADDITIONAL COST INCURRED BY OTHER DISCIPLINES AND TRADES, RESULTING FROM SUBSTITUTION AS WELL AS LIGHTING SYSTEM PERFORMANCE.
9. E.C. TO ENSURE ALL LINEAR AND COMPACT FLUORESCENT LAMPS TO BE SUPPLIED AND INSTALLED ARE LOW MERCURY, WITH AVERAGE MERCURY CONTENT OF 70 PICOGRAMS PER LUMEN-HOUR OR BELOW.
10. ALL LIGHTING TO BE CSA OR CUL APPROVED AS A SYSTEM.
11. ALL LUMINAIRES CONTROLLED BY OCCUPANCY SENSOR MUST BE SUPPLIED WITH COMPATIBLE ELECTRONIC PROGRAM START BALLASTS.

12. MINIMUM CLEAR HEIGHT FOR LUMINAIRES LOCATED IN EXITS, EXIT CORRIDORS, PUBLIC AND OTHER MEANS OF EGRESS TO BE 7'-0" (2.1m).

12. MINIMOM CLEAR HEIGHT FOR LUMINAIRES LOCATED IN EXITS, EXIT CORRIDORS, PUBLIC AND OTHER MEANS OF EGRESS TO BE 7-0 (2.1 m).  13. CONTRACTOR AND/OR SUPPLIER TO PROVIDE UNIT PRICING OF EACH LUMINAIRE TO BE PROVIDED AT TENDER AS PART OF TENDER AND BID PROCESS.									
Image	Nemetz Type	Description	Location	Control	Lamp	Mounting			
LANDSCAPE AND EXTERIOR									
	DD	KIM LIGHTING OURO UR20 28L-30 3K80 2 UNV X (REFRE TO LANDSCAPE DESIGNER TO MOUNTING POLE POST OPTIONS)	SITE POLE LIGHTNG	PHOTOCELL & TIME CLOCK	30W LED 3000K 2816 LUMENS	POLE MH:16'			
	DD1	BEACON LIGHTING RATIO RAR-2-ST-72L-55-AM-3-X-UNV (LANDSCAPE DESIGNER TO CONFIRM MOUNTING ARM OPTIONS)	SOUTH SIDE POLE		55W LED 3000K 4000LUMENS	POLE MH:20'			
•	EE	TIVOLI LIGHTING ADOPT DROP 2.0 LSD2-STRND-X-X TO C/W DROP LSAD-DPR-X-30K-X & GLOBE LSA2-X (REFER TO LANDSCAPE DESIGNER FOR DETAILLS)	PLAZE L1 CATENARY LIGHTING		0.96W LED 3000K	CATENARY LIGHTING			
	IJ	BEGA 33817	ENTRY/EXIT DOORS		13.9W LED 3000K 1355 LUMENS	SURFACE/WALL			
	JJ1	LITHONIA LIGHTING WDGE2 LED P2 VF	LOADING-PARKING ENTRY		15W LED 3000K 1947 LUMENS	SURFACE/WALL			
100	кк	LITHONIA LIGHTING LLP4 13LM 30K MVOT G4 80CRI ZT HW XX WET LOCATION	SOFFIT MAIN ENTRANCE		11.7W LED 3000K 1300 DEL. LUMENS	RECESSED/ CEILING			
	мм	LED LINEAR VENUS TV WHITE HE15 W830 X IP67 TO C/W REQUIRED ACCESSORIES	FAÇADE FEATURE LIGHT BUILING 1-2		4.6W/FT LED 3000K	SURFACE/FAÇADE REFER TO ARCH FOR LENGTH AND DETAILS			
	NN	OPTION 1: BEGA FAÇADE FLOODLIGHT 84379 -GLOW BOX APPROACH	MECH ROOF TOP		7.5W/FT LED 3000K	SURFACE/FACADE			
		Option 2: LED LINEAR XOOLUM IP67 XOOLUM HYD HD15 W830 X -FRAME OUTLINE APPROACH	1		4.6W/FT LED 3000K	SURFACE/FACADE			