Calgary Planning Commission Report (CPC2021-1414) from 2021 October 21

Planning & Development Report to Calgary Planning Commission 2021 October 21 ISC: UNRESTRICTED CPC2021-1414 Page 1 of 3

Development Permit in Downtown Commercial Core (Ward 8) at 526 – 4 Avenue SW, DP2020-5899

RECOMMENDATION:

That Calgary Planning Commission **APPROVE** Development Permit DP2020-5899 for a New: Dwelling Unit, Office, Retail and Consumer Service at 526 – 4 Avenue SW (Plan 09T14296, Block 15, Lot 33) with conditions (Attachment 2).

RECOMMENDATION OF THE CALGARY PLANNING COMMISSION, 2021 OCTOBER 21: That with respect to Report CPC2021-1414, the following be approved:

That the Calgary Planning Commission recommend that DP2020- 5899 be referred to Administration to:

- identify ways that commercial/retail can be added along 5 Street SW;
- identify ways to consolidate the bike parking on level one or P1 of the parkade; and
- To explore ways to reduce spandrel or add glazing to east elevation;

To the satisfaction of Administration, and to report back to the Calgary Planning Commission no later than 2021 December 16.

HIGHLIGHTS

- This application proposes a new mixed-use development providing 268 dwelling units in a single 33-storey building (112 metres in height) with retail uses at-grade and the potential for small offices on the top floor.
- The proposed development would advance and align with the goals and policies of the *Greater Downtown Plan* and the *Municipal Development Plan* (MDP) which encourage downtown livability through new residences and supporting amenities.
- What does this mean to Calgarians? This application proposes new housing options in the Downtown Commercial Core where employment and amenities are easily accessible.
- Why does this matter? Promoting residential growth would allow for dense, urban, lowcarbon lifestyles and support the revitalization of downtown as a key component of Calgary's economy and tax base.
- The proposal aligns with Land Use Bylaw 1P2007.
- On 2021 April 26 Council approved a maximum of \$5 million in contributions to the Plus 15 fund to incentivize residential development downtown.
- Strategic Alignment to Council's Citizen Priorities: A city of safe and inspiring neighbourhoods.

DISCUSSION

This application in the Downtown Commercial Core was submitted by S2 Architecture on behalf of the landowner, La Caille Fourth Avenue Group, on 2020 September 18. The site is within the high-density fabric of Downtown and is currently developed with a single-storey commercial plaza. As per the Applicant Submission (Attachment 5), the site's vision is for a high-density Planning & Development Report to Calgary Planning Commission 2021 October 21 ISC: UNRESTRICTED CPC2021-1414 Page 2 of 3

Development Permit in Downtown Commercial Core (Ward 8) at 526 - 4 Avenue SW, DP2020-5899

tower consisting of dwelling units with supporting retail uses in a podium at grade. The top-floor units are proposed to be small offices, but may be developed as a large penthouse apartment.

The podium is three storeys tall with the upper storey being supported by columns. At-grade, the main entrance is recessed six metres beyond the columns. The tower is simple with identical floor plates for most of its height. Vertical lines of white panelling will extend the height of the building along its western façade, while the eastern façade will feature a variated pattern of three-tone grey panelling. The full development permit plans can be found in Attachment 4.

As part of the review process, this application was reviewed by the Urban Design Review Panel (UDRP) on 2020 September 30 where further review was recommended. Subsequent amendments to the plans were reviewed by the City Wide Urban Design team and accepted. Comments from UDRP are included in Attachment 3.

This proposal would be the first to make use of Council-approved funding meant to incentivize residential development downtown by offsetting the required contribution to the Plus 15 Fund of approximately \$1 million. The applicant is responsible for making the contribution to the Fund and The City will reimburse the contribution. The building is designed to allow connection to the Plus 15 network in the future, however physical connection to the network is not possible until the adjacent site is redeveloped.

Overall, the proposal would allow for residential growth downtown, furthering a shift from commercial use to residential use to promote greater vibrancy and revitalization in the Downtown Commercial Core. This aligns with the objectives and policies of the MDP and the *Greater Downtown Plan*.

A detailed planning evaluation of this application, including location maps, is provided in Attachment 1, Background and Planning Evaluation.

STAKEHOLDER ENGAGEMENT AND COMMUNICATION (EXTERNAL)

- Outreach was undertaken by the Applicant
- Public/Stakeholders were informed by Administration

Applicant-Led Outreach

As part of the review of the proposed development permit application, the applicant was encouraged to use the <u>Applicant Outreach Toolkit</u> to assess which level of outreach with public stakeholders and the community association was appropriate. They determined that no additional outreach would be undertaken.

City-Led Outreach

In keeping with Administration's practices, this application was circulated to stakeholders, notice posted on site and published <u>online</u>. No public comments were received at the time of writing this report. There is no community association for the subject area.

Following Calgary Planning Commission, Commission's decision will be advertised in accordance with the *Municipal Government Act*.

Planning & Development Report to Calgary Planning Commission 2021 October 21 ISC: UNRESTRICTED CPC2021-1414 Page 3 of 3

Development Permit in Downtown Commercial Core (Ward 8) at 526 - 4 Avenue SW, DP2020-5899

IMPLICATIONS

Social

This proposal would enable affordable and accessible housing in a location well served by existing infrastructure and within close proximity to services and transit.

Environmental

This application does not include any actions that specifically address the objectives of the *Climate Resilience Strategy*.

Economic

The proposal includes 268 dwelling units, 188 square metres of net retail space at-grade, and 186 square metres of office space on the top floor. This development would add housing to the Downtown in alignment with the goals of the Downtown Strategy and the economic development strategy <u>Calgary in the New Economy</u>.

Service and Financial Implications

No anticipated financial impact. This proposal would make use of Council-approved funding meant to implement the policies and objectives of the *Greater Downtown Plan* by incentivizing residential development.

RISK

There are no known risks associated with this proposal.

ATTACHMENTS

- 1. Background and Planning Evaluation
- 2. Conditions of Approval
- 3. Urban Design Review Panel Comments
- 4. Development Permit Plans
- 5. Applicant Submission

Department Circulation

General Manager (Name)	Department	Approve/Consult/Inform

Background and Planning Evaluation

Background and Site Context

The subject site is located in the Downtown Commercial Core at the northeast corner of 4 Avenue SW and 5 Street SW. The site is approximately 65 metres wide by 37 metres deep (215 by 125 feet) and has a total area of approximately 0.17 hectares (0.64 acres). Vehicular access to the site is provided through dual accesses onto 4 Avenue SW as well as the lane north of the site which accesses 5 Street SW. The 5 Street SW cycle track runs along the site's western property line.

The site is currently developed with a single-storey commercial building featuring a mix of retail uses. Surrounding development consists of a mixture of high-density commercial and residential uses in buildings ranging between six and 32 storeys in height. A two-storey commercial building is immediately east of the site.

The site is a five-minute walk (350 metres) from 7 Avenue SW where transit service is available via LRT and BRT, as well as access to the CORE Shopping Centre. The Bow River Pathway is located a similar distance to the north.

This proposal began with a pre-application enquiry submitted to The City on 2020 June 01. At the time, a major concern was the separation distances for any future mid-block tower. The applicant responded with careful placement of balconies and windows, giving Administration greater comfort supporting smaller separation distances and ensuring the future livability of the entire block.

Community Peak Population Table


As identified below, the Downtown Commercial Core reached its peak population in 2015.

Downtown Commercial Core		
Peak Population Year	2015	
Peak Population	9,083	
2019 Current Population	8,683	
Difference in Population (Number)	- 400	
Difference in Population (Percent)	- 4.4%	


Source: The City of Calgary 2019 Civic Census

Additional demographic and socio-economic information may be obtained online through the <u>Downtown Commercial Core Community Profile</u>.

Location Maps

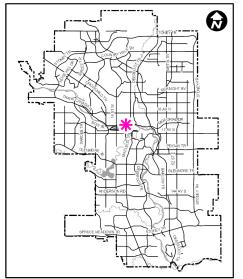



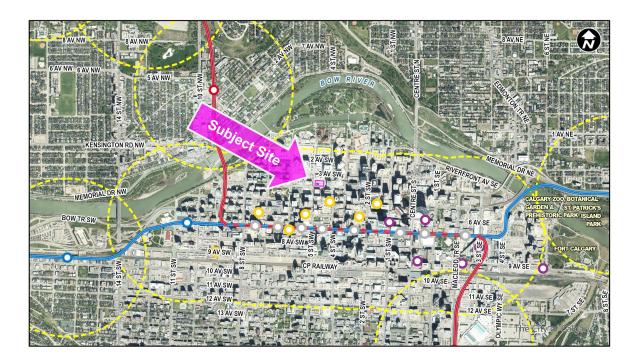

CPC2021-1414 Attachment 1 ISC:UNRESTRICTED

CPC2021-1569 - Attachment 1 ISC: UNRESTRICTED Page 2 of 6



Previous Council Direction

On 2021 April 26 Council approved "Realizing Calgary's Greater Downtown Plan – Initial Investments and Incentives" (C2021-0524), a \$200 million portfolio of investments meant to create momentum in Greater Downtown and further its revitalization. Key to this momentum is residential growth in the area which can offset lower commercial demand and create a critical mass of people to attract new amenities.

All significant residential development in the Downtown Commercial Core requires a mandatory contribution to the Plus 15 Fund; therefore, the contribution itself can serve as a financial barrier to development. As part of the Council-approved portfolio, a \$5 million fund was set aside to offset the required contribution. This application is the first to make use of the incentive fund and will be seeking to offset the required contribution of approximately \$1 million.

Planning Evaluation

Land Use

The site is designated as the Commercial Residential District (CR20 – C20/R20) which applies to most of the Downtown Commercial Core. The CR20 – C20/R20 District is designed to support high-rise, high-density developments that contribute to downtown's role as Calgary's pre-eminent destination for business, retail, entertainment and cultural activities. The District offers numerous opportunities for developments to earn bonus density through provision of desirable amenities such as connections to the Plus 15 system, a high-quality public realm atgrade, and publicly accessible private open space. Residential uses are particularly emphasized as being desirable.

CPC2021-1414 Attachment 1 ISC:UNRESTRICTED

CPC2021-1569 - Attachment 1 ISC: UNRESTRICTED Page 3 of 6

	Additional FAR	Total FAR
Base density (Dwelling Units)		3.0
On-Site Pedestrian Amenities (including Plus 15 connectivity)	12.0	15.0
Contribution to Central Business District Improvement Fund	0.12	15.12

This proposal makes use of available bonus incentives to achieve density as follows:

Development and Site Design

The proposed building consists of a three-story podium with a tower above for a total of 34 storeys. The placement of the building is constrained by the required 2.13 metre setbacks from both streets for public realm improvements, as well as an additional 2.2 metre setback required by the land use district. These setbacks, as well as the realities of parkade geometry below grade, have determined the location of the elevator core and therefore placement of the overall tower. A total of 268 residential units are proposed.

The south and west façades of the podium are recessed by 6.1 and 3.5 metres respectively, creating a wider public realm beneath the canopy, which is supported by four support columns. The canopy and columns serve to frame the main entrances to the residential lobby as well as the commercial retail units. In addition, the space creates opportunities for a plaza or semi-private patios should restaurant uses be desired.

The eastern third of the site is not envisioned for major development at this time but will be converted to a surface parking lot. This surface lot is to be screened by a decorative fence so as not to detract from the public realm.

The at-grade uses will extend into much of the second floor. A stairwell will provide access from grade to a future Plus 15 connection on the third floor. The third floor will also feature residential amenities including individual storage units, a co-working space as well as a gym. Additional common amenity space will be provided on the fourth floor in the form of an indoor lounge as well as an outdoor terrace. This additional outdoor amenity space is meant to offset the lack of private amenity space available to many units. The applicant proposed reducing the number of balconies to minimize heat loss via exposed floor slab, which Administration agreed to as a means of supporting energy efficiency.

Urban Design Review Panel

The Urban Design Review Panel (UDRP) reviewed the application at its initial submission and provided comments. In general, UDRP's comments reflect an acknowledgement of what the project is trying to accomplish with its simplicity but urged the applicant to make several refinements to the plans. Comments from UDRP questioned the utility of the Plus 15 connection in this location. However, the Land Use Bylaw requires that all buildings seeking to make use of bonus density must design their buildings with Plus 15 connectivity in mind.

In response to UDRP's comments, the applicant provided additional articulation to the building façade (particularly at-grade to highlight the commercial entrances), continued the south façade treatment around to the west façade, and instituted several changes to the common outdoor amenity space.

CPC2021-1414 Attachment 1 ISC:UNRESTRICTED

Transportation

The site benefits from strong connectivity for all mobility modes. Both local and rapid transit are available within 300 metres (a five-minute walk), a cycle track connection is immediately adjacent to the site, and the grid network of downtown provides multiple connection points for pedestrians.

Commercial loading and servicing bays will be accessed from the lane, as will the four-level underground parkade. Bicycle parking will be spread throughout the parkade as well as on the second floor, which will otherwise be used for mechanical and storage. At-grade bicycle parking will be clustered along the western façade of the building close to the cycle track.

Environmental Site Considerations

The development has been designed such that the location of all electrical and mechanical equipment is above the 1-in-100-year flood level. An environmental site assessment was provided that identified no evident environmental concerns.

Utilities and Servicing

Water, sewer and storm sewer connections are all available from both 4 Avenue SW and 5 Street SW. Relevant studies have been provided that confirm capacity exists to service the proposed development.

Legislation and Policy

South Saskatchewan Regional Plan (2014)

The recommendation by Administration in this report has considered and is aligned with the policy direction of the <u>South Saskatchewan Regional Plan</u> which directs population growth in the region to Cities and Towns and promotes the efficient use of land.

Interim Growth Plan (2018)

The recommendation aligns with the policy direction of the Calgary Metropolitan Region Board's <u>Interim Growth Plan</u> (IGP). The proposed development builds on the principles of the IGP by means of promoting efficient use of land, regional infrastructure, and establishing strong, sustainable communities.

Municipal Development Plan (Statutory - 2009)

This application falls within the Greater Downtown Activity Centre as identified on Map 1: Urban Structure in the *Municipal Development Plan*. Policy for this area intends to support Downtown as the urban destination of choice for Calgarians by promoting residential development and livability.

Climate Resilience Strategy (2018)

This application provides more efficient use of land in alignment with Program 6: Land-Use and Transportation Planning of the <u>*Climate Resilience Strategy*</u>, but no other climate adaptation or mitigation measures are provided.

Greater Downtown Plan (Non-Statutory – 2021)

This application aligns with the vision and principles of the <u>Greater Downtown Plan</u> primarily by advancing its first strategic move: strengthening neighbourhoods to create vibrant urban life. To that end, policies meant to make downtown living more attractive and to shift the image of the

CPC2021-1414 Attachment 1 ISC:UNRESTRICTED Downtown Commercial Core rely on increased population downtown in order to increase demand for amenities and make them more cost-effective to provide.

The western portion of the Downtown Commercial Core is an area particularly hard-hit by economic recession due to its older supply of commercial floor space. This proposal can provide a substantial amount of additional foot traffic to help bolster local retail demand and can aid in attracting new office tenants who are seeking more livable areas in which to locate. The creation of a new public plaza in front of this building offers opportunities for place-making initiatives that can transform this block into a more desirable, vibrant location.

Land Use Bylaw (2007)

This development permit requires the following relaxations to the Land Use Bylaw. Administration has reviewed each relaxation individually and considers each relaxation to be acceptable for the reasons outlined below.

Bylaw Relaxations				
Regulation	Standard	Provided		
1298 Residential	Common Amenity Space Outdoors (6)(c) must have a contiguous area of not less than 50.0m ² with no dimension less than 6.0m;	Plans indicate outdoor amenity dimension of 5.0m (-1.0m). Relaxation supported. Additional information provided regarding design of the space.		
Amenity Space	Common Amenity Space Indoors (6)(c) must have a contiguous area of not less than 50.0m ² with no dimension less than 6.0m;	Plans indicate indoor amenity dimension of 4.7m (-1.3m). Relaxation supported. Additional information provided regarding design of the space.		
1318 Locations of Uses within Buildings	(5) Only those uses listed in the Residential Group of Schedule A to this Bylaw, with the exception of Hotel uses, may share an area of a parking structure with residential uses.	Plans indicate shared parking between the residential and commercial uses within the parkade. Relaxation supported. The office use is only one possibility and consists of 2 stalls maximum.		
1325 Motor Vehicle Parking Stalls	(c) the <u>visitor parking stall</u> requirement is 0.1 stalls per <u>unit</u> .	Plans indicate 20 (-7) visitor stalls. Relaxation supported due to high degree of site connectivity.		
1331 Location of Bicycle Parking Stalls	Bicycle parking stalls – class 1 must be located at-grade or within the first parkade level directly below grade.	Plans indicate Bicycle – Class 1 stalls located below the first parkade level. Relaxation supported.		

Conditions of Approval

Prior to Release Requirements

The following requirements shall be met prior to the release of the permit. All requirements shall be resolved to the satisfaction of the Approving Authority:

Planning:

- 1. A Development Agreement shall be executed in conformity with all reports, plans and materials submitted to and approved by the Development Authority, including:
 - A Plus 15 Development Agreement with The City to the satisfaction of the City Solicitor,
 - The delineation of Plus 15 easement areas, schedules, maintenance obligations, and details regarding reimbursement of the required contribution to the Plus 15 Fund;
 - Details of responsibilities for and construction of all improvements within the adjacent public rights-of-way, and
 - Details with respect to contributions to off-site improvement funds in accordance with the Bonus standards of Part 10 of Land Use Bylaw 1P2007.
- Submit contribution to the Plus 15 fund at the current rate at the time of payment. Please contact <u>Charmaine Buhler</u>, Senior Engineer, 403-268-1771 for the current Plus 15 fund rate prior to payment.

Development Engineering:

3. Submit three (3) sets of the Development Site Servicing Plan details to Development Servicing, Inspections and Permits, for review and acceptance from Water Resources, as required by Section 5 (2) of the *Utility Site Servicing Bylaw 33M2005*. Contact <u>developmentservicing2@calgary.ca</u> for additional details.

For further information, refer to the following:

Design Guidelines for Development Site Servicing Plans https://www.calgary.ca/PDA/pd/Documents/urban_development/publications/DSSP-Design-Guidelines.pdf

Development Site Servicing Plans CARL (requirement list) http://www.calgary.ca/PDA/pd/Documents/development/development-site-servicingplan.pdf

Note: <u>Each proposed parcel</u> requires a separate storm connection. Storm service must be to 4thAV to avoid connection to double duct. For more information contact water resources.

4. Remit payment (certified cheque) for the infrastructure upgrades for the Centre City communities, in the amount of **\$203,608.59** to Development Engineering. This levy includes both the Centre City Utility Levy approved under the Centre City Utility Levy Bylaw 38M2009 and an amount approved by Council for community recreation,

CPC2021-1414 Attachment 2 ISC:UNRESTRICTED Page 1 of 6

transportation, parks upgrading, and greenways. The amount identified above is determined by using \$4710.00 per meter of site frontage (on avenues only) for the proposed development (*43.229m on 4 AV SW*).

OR

Apply for the Off-Site Levy Payment Relief Program and execute a Centre City Levy Agreement for the payment of Centre City levies pursuant to Bylaw 38M2009, delaying payment to Development Completion Permit. **This option is only applicable on Development Permits to be released by December 31, 2020**.

To obtain the application and the Centre City Levy Agreement, contact the Infrastructure Strategist, Calgary Approvals Coordination (DEBBIE MEILI at 4032688223 or deborah.meili@calgary.ca)

Note: Centre City Levy is being charged as per the <u>Proposed Property Line</u>. If site is not subdivided the centre city levy will be charged for the entire length of parcel along 4 AV SW

5. After the Development Permit is approved but prior to its release, the landowner shall execute an Off-Site Levy Agreement for the payment of off-site levies pursuant to Bylaw 2M2016. The off-site levy is based on a 2020 development approval date and was based on the following:

Description	Unit(s)		
526 4 AV SW	Existing Comm: 1115m2 - New Comm: 202m2/New 1 Bed: 148/New 2 Bed: 120		

Based on the information above, the **preliminary estimate** is **\$160,130.10**. **Should payment be made prior to release of the development permit, an Off-Site Levy Agreement will not be required.**

- Include the completed Payment Submission Form, which was emailed to the applicant.
- Only certified cheques or bank drafts made payable to the City of Calgary are acceptable.

To obtain an off-site levy agreement or for further information, contact the Calgary Approvals Coordination, Infrastructure Strategist (DEBBIE MEILI at 4032688223 or deborah.meili@calgary.ca) or <u>offsitelevy@calgary.ca</u>.

Transportation:

6. Execute and register on title an Access Easement Agreement with the City of Calgary over Lot 33, Block 1, Plan 0914296 (Servient Lands) in favour of 4 Avenue & 5 Street S.W. (Dominant Lands) for the purpose of pedestrian access. The agreement and registerable access right of way plan shall be to the satisfaction of the Director, Transportation Planning and the City Solicitor. A standard template for the agreement and an Instruction Document will be provided by the Transportation CPAG Generalist.

CPC2021-1414 Attachment 2 ISC:UNRESTRICTED Submit an original copy of the executed agreement and the certificate of title(s), indicating the agreement is registered on title, for all affected parcels. **This is to be registered over the Bylaw/ Public realm setback areas.**

7. Remit a performance security deposit (certified cheque, bank draft, letter of credit) for the proposed infrastructure listed below within the public right-of-way to address the requirements of the Business Unit. The amount of the deposit is calculated by Roads and is based on 100% of the estimated cost of construction.

The developer is responsible to arrange for the construction of the infrastructure with their own forces and to enter into an Indemnification Agreement with Roads at the time of construction (the security deposit will be used to secure the work).

<u>Roads</u>

- a. Construction of new sidewalks adjacent to site frontages (4 Avenue & 5 Street S.W.),
- b. Construction of two new wheelchair ramps,
- c. Construction of new City tree trenches along site frontages to City standards,
- d. Rehabilitation of existing driveway crossings, sidewalks, curb and gutter, etc., should it be deemed necessary through a site inspection by Roads personnel.
- 8. Remit payment (certified cheque, bank draft) for the proposed infrastructure listed below within the public right-of-way to address the requirements of the Business Units. The amount is calculated by the respective Business Unit and is based on 100% of the estimated cost of construction.

The developer is responsible to coordinate the timing of the construction by City forces. The payment is non-refundable.

<u>Roads</u>

a. Street lighting upgrading adjacent to site frontages (If required).

Parks:

No comments.

Permanent Conditions

The following permanent conditions shall apply:

Planning:

- 9. The development shall be completed in its entirety, in accordance with the approved plans and conditions.
- 10. No changes to the approved plans shall take place unless authorized by the Development Authority.
- 11. A Development Completion Permit shall be issued for the development **before the use** is commenced or the development occupied. A Development Completion Permit is independent from the requirements of Building Permit occupancy. Call Development Inspection Services at 403-268-5311 to request a site inspection for the Development Completion Permit.

CPC2021-1414 Attachment 2 ISC:UNRESTRICTED

- 12. Upon completion of the main floor (storey) subfloor of the building proof of the geodetic elevation of the constructed main floor (storey) subfloor of the building must be submitted to and approved by the Development Authority prior to any further construction proceeding. Email confirmation to <u>geodetic.review@calgary.ca</u>.
- 13. All areas of soft landscaping must be watered as identified on the approved plans.
- 14. All parking and driving aisles shall be fully paved with a minimum of 50 mm asphaltic concrete or equivalent material to the satisfaction of the Development Authority.
- 15. All electrical servicing for freestanding light standards shall be provided from underground.
- 16. The walls, pillars and ceiling of the underground parkade shall be painted white or a comparable light colour.
- 17. The light fixtures in the parkade shall be positioned over the parking stalls (not the drive aisles).
- 18. All stairwell doors and elevator access areas shall be installed with a transparent panel for visibility.
- 19. Handicapped parking stalls shall be located as shown on the approved plans released with this permit. Handicap parking stall(s) shall be clearly designated, signed and located close to the entrance of the building with barrier-free accessibility.
- 20. All roof top mechanical equipment shall be screened as shown on the approved plans.
- 21. Loading and delivery shall take place in the designated loading stall as shown on the approved plans and shall, at no time, impede the safety of pedestrian movements and use of the parking lot.
- 22. Parking/Multi-purpose space (as identified on the approved plans) and landscaping must be separated by a 150mm (6 inch) continuous, poured in place, concrete curb or equivalent material to the satisfaction of the Development Authority, where the height of the curb is measured from the finished hard surface.
- 23. The waste and recycling facilities shall be kept in a good state of repair at all times and the doors shall be kept closed while the enclosures are not actively in use for delivery or removal of refuse.

Development Engineering:

- 24. If during construction of the development, the developer, the owner of the titled parcel, or any of their agents or contractors becomes aware of any contamination,
 - a. the person discovering such contamination shall immediately report the contamination to the appropriate regulatory agency including, but not limited to, Alberta Environment, Alberta Health Services and The City of Calgary (311).
 - b. on City of Calgary lands or utility corridors, The City of Calgary, Environmental and Safety Management division shall be immediately notified (311).

25. The developer / project manager, and their site designates, shall ensure a timely and complete implementation, inspection and maintenance of all practices specified in erosion and sediment control report and/or drawing(s) which comply with Section 3.0 of The City of Calgary Guidelines for Erosion and Sediment Control. Any amendments to the ESC documents must comply with the requirements outlined in Section 3.0 of The City of Calgary Guidelines for Erosion and Sediment Control.

For other projects where an erosion and sediment control report and/or drawings have not been required at the Prior to Release stage, the developer, or their designates, shall, as a minimum, develop an erosion and sediment control drawing and implement good housekeeping practices to protect onsite and offsite storm drains, and to prevent or mitigate the offsite transport of sediment by the forces of water, wind and construction traffic (mud-tracking) in accordance with the current edition of The City of Calgary Guidelines for Erosion and Sediment Control. Some examples of good housekeeping include stabilization of stockpiles, stabilized and designated construction entrances and exits, lot logs and perimeter controls, suitable storm inlet protection and dust control.

The City of Calgary Guidelines for Erosion and Sediment Control can be accessed at: <u>www.calgary.ca/ud</u> (under publications).

For **all soil disturbing projects**, the developer, or their representative, shall designate a person to inspect all erosion and sediment control practices a minimum of every seven (7) days and during, or within 24 hours of, the onset of significant precipitation (> 12 mm of rain in 24 hours, or rain on wet or thawing soils) or snowmelt events. Note that some practices may require daily or more frequent inspection. Erosion and sediment control practices shall be adjusted to meet changing site and winter conditions.

- 26. Stormwater runoff must be contained and managed in accordance with the "Stormwater Management & Design Manual' all to the satisfaction of the Director of Water Resources.
- 27. The grades indicated on the approved Development Site Servicing Plan(s) must match the grades on the approved Development Permit plans. Upon a request from the Development Authority, the developer or owner of the titled parcel must confirm under seal from a Consulting Engineer or Alberta Land Surveyor, that the development was constructed in accordance with the grades submitted on the Development Permit and Development Site Servicing Plan.
- 28. Prior to issuance of a Development Completion Permit or any occupancy of the building, payment shall be made for off-site levies pursuant to Bylaw 2M2016. To obtain a final estimate, contact the Infrastructure Strategist, Calgary Approvals Coordination (DEBBIE MEILI at 4032688223 or deborah.meili@calgary.ca) or offsitelevy@calgary.ca.
- 29. **Prior to issuance of a Development Completion Permit or any occupancy of the building**, payment shall be made for Centre City levies pursuant to Bylaw 38M2009. To obtain an invoice, contact the Infrastructure Strategist, Calgary Approvals Coordination (DEBBIE MEILI at 4032688223 or deborah.meili@calgary.ca) or <u>offsitelevy@calgary.ca</u>.

Transportation:

- 30. For the life of the Development, the occupants of the building will be permitted to use the elevators to access the class #1 bike facilities.
- 31. The Access Easement Agreement for the purpose of pedestrian access shall remain over Lot 33, Block 1, Plan 0914296 (Servient Lands) in favour of 4 Avenue & 5 Street S.W. (Dominant Lands) until such time as required by the Development or Subdivision Authority in connection with DP2020-5899 or extinguished with the consent of the Development or Subdivision Authority obtained through an application in writing to the Development or Subdivision Authority which shall be accompanied by a registerable discharge of easement and a copy of the certificate of title downloaded or obtained within one week of submission of the application.
- 132. The developer shall be responsible for the cost of public work and any damage during construction in City road right-of-ways, as required by the Manager, Transportation Planning. All work performed on public property shall be done in accordance with City standards.
- 33. Indemnification Agreements are required for any work to be undertaken adjacent to or within City rights-of-way, bylawed setbacks and corner cut areas for the purposes of crane operation, shoring, tie-backs, piles, surface improvements, lay-bys, utility work, +15 bridges, culverts, etc. All temporary shoring, etc., installed in the City rights-of-way, bylawed setbacks and corner cut areas must be removed to the satisfaction of the Manager of Transportation Planning, at the applicant's expense, upon completion of the foundation. Prior to permission to construct, contact the Indemnification Agreement Coordinator, Roads at roadsia@calgary.ca

Parks:

- 34. Public trees located on the boulevard adjacent to the development site shall be retained and protected unless otherwise authorized by Urban Forestry.
- 35. The submitted plans indicate that the removal of existing public trees along property frontage. As per the City of Calgary Tree Protection By-law, a letter of authorization to remove public trees is required from Parks Urban Forestry. The applicant is to contact Urban Forestry at 311 or email <u>tree.protection@calgary.ca</u> to make arrangements for the letter and compensation.
- 36. Any tree planting in the City boulevard shall be performed and inspected in accordance with Parks Development Guidelines and Standard Specifications Landscape Construction (current edition). Applicant is to contact the Parks Development Inspector at 311 or 403-804-9417 to arrange an inspection.

Urban Design Review Panel Comments

Date	September 30, 2020			
Time	1:00			
Panel Members	PresentDistributionChad Russill (Chair)Chris Hardwicke (Co-Chair)Terry KlassenGary MundyColin FriesenBeverly SandalackMichael SydenhamRyan AgreyBen BaileyJack VanstoneNoorullah Hussain ZadaJeff LynessGlen PardoeState			
Advisor	David Down, Chief Urban Des	signer		
Application number	DP2020-5899			
Municipal address	526 4 Av SW			
Community	Downtown Commercial Core			
Project description	New: Dwelling Unit, Office, Re	New: Dwelling Unit, Office, Retail and Consumer Service		
Review	first			
File Manager	Derek Pomreinke			
City Wide Urban Design	Dawn Clarke			
Applicant	S2 Architecture			

*Based on the applicant's response to the Panel's comments, the Chief Urban Designer will determine if further review will include the Panel or be completed internally only by City Wide Urban Design.

Summary

The building under review, titled '4th Avenue Tower', is a 30 storey residential tower on a two storey lobby and retail podium which includes a Plus 15 link accommodated at the north façade. It is located at the west side of the north edge of the downtown core just south of the developing Eau Claire residential area. It meets the basic planning objectives of various Calgary downtown plans and is an adequate urban design solution for this site but could be improved to provide a stronger urban presence with more defined architectural character. The Panel's position is the project needs further refinement to achieve the goals of good quality urban design.

The goal of the design is stated to be 'deliberately simple'. In this regard the project is perhaps too successful the result being that the building has little to say about contemporary design or culture. The panel noted the following items that could benefit from more design development:

1. The lot to the east could benefit from an extension of the retail space from the building. This could be considered as a temporary measure before future assembly and if/when development happens to the east. This would serve to enliven the streetscape to a greater degree than the proposed surface parking lot. One other, albeit somewhat of a lesser consideration from the urban edge, is noted below that would achieve a greater outcome than the current proposal.

2. The south facing elevation on the corner does take advantage of the available southern exposure. The flat planes of glass at ground level and the repetitive nature of the tower elevations offer little in terms of finegrain character. A more articulate form for the tower and a stronger architectural statement at the corner of the podium would generate a presence that would enhance the urban environment and wayfinding in this part of the core.

3. The inclusion of the Plus 15 at the edge of the core in a primarily residential building is of questionable value. Unless this connects the downtown center to some meaningful destination beyond the building or is skillfully integrated with the ground plane, this Plus 15 will attract pedestrian traffic away from the at-grade realm and achieve a less desirable outcome in the opinion of the Panel.

CPC2021-1414 Attachment 3 ISC:UNRESTRICTED

Applicant Response

2021 January 27

- 1. "The lot to the east could benefit from an extension of the retail space from the building. This could be considered as a temporary measure before future assembly and if/when development happens to the east. This would serve to enliven the streetscape to a greater degree than the proposed surface parking lot. One other, albeit somewhat of a lesser consideration from the urban edge, is noted below that would achieve a greater outcome than the current proposal."
 - a) The east and west lots are to be subdivided to create two separate parcels. Each of these parcels are to have different ownership. This application is for the residential tower on the west side of the site. The east site is to be left undeveloped for future development. The east parcel plus the adjacent landowner (Caesar's restaurant) provides enough land area to develop a mid-block Phase Two development. The dimension of the east parcel of land plus the Caesar's restaurant site is 40.280 meters, our proposed west tower is 39.24 meters in width. S2 has also designed a residential tower in East Village (INK) which is on a 30.5 meter-wide, mid-block lot which was approved and built. This addresses the concern that a future tower has the necessary space to be developed in the future. Please refer to revised DP1.00.
 - b) The proposed "pocket" parking lot will provide a multi-purpose amenity for existing businesses in a part of the City with few at-grade parking options.
 - c) In response to the UDRP's comments the Design Team have removed parking spaces, thereby pushing the parking further north to align with the exterior south façade of the building and increasing the public realm at grade and further developed a feature decorative screen along the southern edge of the parking lot to conceal the cars beyond and provide a unique urban respite with seating and landscaping along 4th Avenue complementing the proposed treatment in front of the proposed new residential tower. Please refer to revised DP1.00.
 - d) The construction of a low-rise retail extension on a different owner's property is not considered a temporary solution, we feel the development of a well screened surface lot which has the opportunity to act as a multi-use space is more appropriate for the remaining lands today.
- 2. "The south facing elevation on the corner does take advantage of the available southern exposure. The flat planes of glass at ground level and the repetitive nature of the tower elevations offer little in terms of fine-grain character. A more articulate form for the tower and a stronger architectural statement at the corner of the podium would generate a presence that would enhance the urban environment and wayfinding in this part of the core."
 - a) The south and west facing elevations have been revisited to provide a stronger architectural statement at the corner and greater fine-grained detail has been incorporated into the podium level, addressing wayfinding aspects of the project. Please refer to revised DP4.00, DP4.01 and coloured elevations DP4.00A and DP4.01A.
 - b) Two canopies have been added to the elevations on both 4th Avenue S.W. and 5th Street S.W. The first canopy is at the second level above the residential entry which projects beyond the tenmeter-high exposed exterior columns and wraps around the corner of the building to the west identifying the residential entry. This canopy will define the residential entrance and lobby from both the west and south. Thin LED lights have been added to the soffit of the canopy and are to

CPC2021-1414 Attachment 3 ISC:UNRESTRICTED CPC2021-1569 - Attachment 1

ISC: UNRESTRICTED

be extended into the building to create a strong residential entry both inside and out. The second canopy is located above the retail spaces at approximately ten feet in height and extends from the retail units east to the property line. This canopy projects off the building four feet and will have feature lights in the soffit to give a human scale to the outdoor patio areas. Having the two canopies at different heights introduces a more human scale to the façade and creates a differentiation between the residential and retail uses along the 4th Avenue SW frontage. Please refer to revised DP4.00 and DP4.00A.

- c) The base of the building has been increased in height to +/-700 mm (2.3 ft) to allow for a durable material and ground the building, the material is to be the same material as is represented on the east and west podium level. By increasing the height of the base this will address any potential maintenance issues around the base. Please refer to revised DP4.00 and DP4.00A.
- d) The entrance to the residential use at the corner has now incorporated an arch below the lower canopy with the underside of the arch at ten feet in height which allows the opportunity to add both surface mounted entry lights on either side of the entry and the project name and address above the doors, this arch is to be the same material as the base. At each of the retail entrances there have been columns introduced on either side of the entry doors to highlight where the respective entrances are, the materials on the columns are to be the same as the base. Please refer to revised DP4.00 and DP4.00A.
- e) The tower has been purposefully designed to keep the simplicity of the tower form. The main feature of the tower are the walls on the east side which are a patterned composite panel system which will add textural character to the building and this treatment is continued from the top of the podium to the roof to tie the podium to the tower element above and will act to also screen the mechanical equipment of the roof. Please refer to revised DP4.01 and DP4.01A.
- 3. "The inclusion of the Plus 15 at the edge of the core in a primarily residential building is of questionable value. Unless this connects the downtown center to some meaningful destination beyond the building or is skillfully integrated with the ground plane, this Plus 15 will attract pedestrian traffic away from the at-grade realm and achieve a less desirable outcome in the opinion of the Panel."
 - a) The Plus 15 system in downtown Calgary is in place and this project is respecting the guidelines to allow for the continuity of this system. Presently, La Caille has an approved Development Permit for a 52-storey, mixed-use development for the entire site which does connect to the existing Plus 15 system.
 - b) The intent of development in downtown Calgary is to respect the Plus 15 network and allow for future connectivity; at this time it is unknown what the next destination will be.
 - c) Being a Winter City, Calgarians utilize the Plus 15 system throughout the year, more so in the winter months. However, we do understand that the Plus 15 will attract pedestrian traffic away from the at-grade realm. Access to the Plus 15 system is provided along 5th Street SW. Please refer to revised DP2.03 and DP4.00.

CPC2021-1414 Attachment 3 ISC:UNRESTRICTED CPC2021-1569 - Attachment 1 ISC: UNRESTRICTED Page 3 of 6

	Urban Design Element		
Creativity Encourage	e innovation; model best practices		
	oproach as it relates to original ideas or innovation		
UDRP Commentary	The building is overtly simple to a fault in form and is not considered a strong urban design solution. The Panel recommends an increased focus to create character and identity by adding variety to the tower elevations and more articulation to the ground level glazing. The three prominent south-facing columns represent basic minimalism – a more innovative design response to framing the entrance is encouraged.		
Applicant Response	The Design Team have reviewed the podium level façade articulation and introduced canopies above the residential and retail entrances and added more fine-grain detail to the base. Description of the changes is addressed above in the response to Question 2. Please refer to revised DP4.00.		
Context Optimize buuses, heights and der	uilt form with respect to mass and spacing of buildings, placement on site, response to adjacent nsities		
 Massing relations 	ship to context, distribution on site, and orientation to street edges		
 Shade impact on 	public realm and adjacent sites		
UDRP Commentary Generally, the massing and size are appropriate in this context and the ground level doe respond to the south exposure. The missing element is observed to be smaller scale articulation. There is currently a missed opportunity to enhance the corner treatment. Potential solution			
Applicant Response	may include smart wayfinding attributes that reinforce placemaking qualities.The Design Team have reviewed the design based on the comment above and have reworked the lower podium level to introduce both fine-grain details as well as addressing the corner and assisting with the wayfinding aspect of identifying the residential front door and defining it differently than the retail entrances. Further detail is provided in the 		
	nes street edges, ensures height and mass respect context; pay attention to scale ition to public realm at grade		
UDRP Commentary	Overall massing is appropriate, and the landscaping approach has clarity but the fine-grain detail is missing. In the reviewed design, there is a noticeable lack in small scale articulation for the building, which does not sufficiently address human scale.		
Applicant Response	The Design Team have reviewed the massing and the contribution to the public realm at grade, as such, canopies at various heights have been introduced along with additional detail at the podium level. Please refer to the response to Question 2 above for a more detailed breakdown of what has been introduced. Please refer to revised DP4.00 and DP4.00A.		
	The landscape palette is intended as simple with a modular language tying into the building interface. At a broader scale, a pattern of wide charcoal color concrete bands running north-south at regular intervals set the rhythm of the public realm experience. The charcoal bands are also used as organizing elements for the boulevard trees and planting bed delineating the transition from public to private. Additionally, finer charcoal bands running east-west adds a finer grain of pattern as a user moves from south to north, approaching the building from public realm to private realm. The planting beds further add a layer of fine-grain through the introduction of layered planting with low evergreen shrubs along the edge of the sidewalk, with a layer of taller grasses behind. A 200mm (6 inch) curb has been introduced around each of the planting beds to provide greater definition to the planting beds. Please refer to revised DP-L1.		
 Parking entrances 	junction of land-use, built form, landscaping and public realm design s and at-grade parking areas are concealed on at entrances and solar exposure for outdoor public areas nse		
UDRP Commentary	The surface parking area should be reviewed further. Commentary to extend commercial frontage at-grade and along 4 th Avenue would significantly improve the urban edge. Another consideration discussed by the Panel is the potential for integration of the parking, plaza and laneway into multiuse space with a south side gateway connection and temporary placemaking, to enhance this area.		

Applicant Response	The surface parking on the new east parcel has been reduced in size whereby stalls have been removed and a visual screen has been introduced to separate the surface parking from the public realm along 4th Avenue. The screen in in line with the building façade which allows for the public realm space defined on the west site to continue to the east. A south pedestrian access point has been provided against the building allowing access from the Avenue frontage plaza space to the surface parking multiuse space. Please refer to revised DP1.00 and DP6.01.
	ve visual and functional connections between buildings and places; ensure connection to
existing and future ner	
	esign, walkability, pathways through site
	RT stations, regional pathways and cycle paths ay materials extend across driveways and lanes
UDRP Commentary	+15 not supported in this location, as it significantly detracts from the Urban Realm
obra commonary	environment at-grade.
Applicant Response	The Design Team have reviewed the Plus 15 location and feel that it responds to the connectivity of the Plus 15 system. We understand that it potentially detracts from the Urban Realm but does address the provision of the connectivity to the Plus 15 system. Access to the Plus 15 system is directly off the sidewalk along 5th Street SW and will be signed appropriately. Please refer to revised DP1.00 and DP4.00.
Animation Incorpora	ate active uses; pay attention to details; add colour, wit and fun
	ributes to an active pedestrian realm
 Residential units p 	
	eresting and enhance the streetscape
UDRP Commentary	Building design as reviewed is relatively sterile. While it is noted as integrating a high degree of glazing, there is little articulation and animation of the façade. Fine grain details at the podium are recommended by the Panel.
	Improved rendering quality for a project of this stature is recommended. This would provide a more accurate representation of the project and therefore a more informed Panel commentary. Some technical aspects of the ability for the 'highly articulated metal panels' to provide as much relief in the built condition as shown in the renderings is identified as being an area of concern.
Applicant Response	The Design Team have reviewed the podium level glazing articulation and introduced various elements to create a more human scale at grade for the public realm. Please refer to the response to Question 2 above. Please refer to revised DP4.00 and coloured elevation DP4.00A, and appended images and material board.
Accessibility Ensur	e clear and simple access for all types of users
 Barrier free design 	
	gibility, and natural wayfinding
UDRP Commentary	Accessibility seems to meet requirements
Applicant Response	
	esigns accommodating a broad range of users and uses
	ty, at-grade areas, transparency into spaces
	and project porosity
UDRP Commentary	Retail allows for a variety of uses and provides transparency into the space, however corner character and fine grain details are missing.
Applicant Response	The Design Team have reviewed the at grade uses which include the entry to the residential tower as well retail uses fronting onto 4th Avenue. Canopies, lighting, definition of entries
	has been incorporated into the design. The corner treatment has been continued around the corner from 4 th Avenue S.W. to 5th Street S.W. Please refer to the response to Question 2 above for more detailed information. Please refer to revised DP4.00, DP4.00A, DP-L1 and DPE1.1.
	blanning and building concepts which allow adaptation to future uses, new technologies relating to market and/or context changes
UDRP Commentary	While the Panel appreciates the flexibility aspect of a simple design, areas such as the
ODIA Commentary	rooftop amenity are noted as being 'just pavers' and provide little guidance regarding actual use. In the current format, the rooftop space should not be considered as amenity space.

CPC2021-1414 Attachment 3 ISC:UNRESTRICTED

Applicant Response	 Applicant to further review the 'Outdoor Amenity' on level 3 along the northside of the building. This location presents three private patio areas immediately adjacent to a thin strip of outdoor amenity, thus creating an awkward interface with one another. Providing larger private balconies and eliminating the outdoor amenity in this area appears one solution, that may be worth exploring, to reduce potential conflict. The Design Team have reviewed the Outdoor Amenity space on level 4 (formerly level 3, per DP package). The modified design responds to comments regarding how the space is to be laid out and utilized. A trellis structure has been added directly outside the doors from the building. Under this trellis will be movable furniture and barbeques for resident use, as well as built-in planters to help define the space. There is to be a screen added which separates the Outdoor Amenity space on the east side from the units facing north. There is to be no public access to the rooftop space directly in front of the private patio areas of the units facing north. Please refer to revised DP2.06, DP-L2 and DPE1.2.
Safety and securiNight time design	
UDRP Commentary	Ground level and parking areas have adequate sight lines and surveillance. No significant concerns are identified in the presented package.
Applicant Response	The new landscape 'pockets' are to have a raised 200 mm (8 inch) curb around them to articulate wayfinding, increase soil volume for plants and frame the landscaped walking space. The building has also been refined to add greater fine-grain detail as well as addressing wayfinding concerns. Please refer to the response to Question 2 above which outlines the further refined details being incorporated. Please refer to revised DP1.00, DP-L1 and DPE1.1.
Orientation Provide	clear and consistent directional clues for urban navigation
Enhance natural	-
UDRP Commentary	See Context regarding comments on wayfinding. Applicant might consider a slightly raised curb under street tree canopy to balance and frame the landscaped walking space along 4th avenue & 5th streets.
Applicant Response	
Sustainability Be a Site/solar orientat 	ware of lifecycle costs; incorporate sustainable practices and materials ion and passive heating/cooling and sustainable products
UDRP Commentary	No meaningful sustainability aspects were discussed as part of the presentation.
Applicant Response	Low-maintenance, drought-tolerant shrubs and decorative grasses are proposed in the planters to ensure viability and sustainability of the proposed planting palette from a maintenance and environmental perspective. Please refer to revised DP-L1.
 Use of low mainter 	te long-lasting materials and details that will provide a legacy rather than a liability enance materials and/or sustainable products a avoid maintenance issues
UDRP Commentary	Applicant to review podium materiality, as critical area to enhance project materiality in relationship with the at-grade areas. Landscaping requires adequate planting and soil depth. Soil cell technology should be considered to improve the health of the urban tree canopy
Applicant Response	The Design Team have reviewed the materiality and maintenance aspects of the base of the building. The glazing has been raised up 700 mm (2.3 ft) to allow for proper maintenance and durability for the project. This base is continued along the west face of the resident lobby on 5th Street S.W. as well as along the south façade by the resident entry and the retail uses fronting onto 4th Avenue S.W. The materials to be used are the same as the materials on the podium walls on the west and east elevations. Please refer to the response to Question 2 above for a more detailed description on modifications. Please refer to revised DP1.00. Adequate planting depth and soil volume has been provided in keeping with best industry
	practices and City of Calgary requirements for planting over the parkade, to ensure long term viability of the plants. Please refer to DP-L2.

Development Permit Plans



4th AVENUE TOWER - DP2020-5899 DTR 2 - 03.31.2021

Design Team



Drawing List

DP0.00	COVER SHEET	198-01SVC	
DP0.01	PROJECT INFORMATION	198-01GRA	D
DP0.02	SITE PHOTOS		
DP0.03	EXISTING SURVEY	DP-L1	LA
DP0.04	CONSOLIDATION PLAN	DP-L2	LA
DP1.00	SITE PLAN		
DP1.01	SHADOW STUDY		
DP1.02	SITE ACCESS DIAGRAMS	DPE1.1	EL
DP1.03	FAR BONUS DIAGRAMS	DPE1.2	A١
DP2.00	PARKADE LEVEL P04 PLAN		LA
DP2.01	PARKADE LEVEL 02		
DP2.02	PARKADE LEVEL 01		
DP2.03	LEVEL 01 PLAN - MAIN FLOOR		
DP2.04	LEVEL 02 - STORAGE		
DP2.05	LEVEL 03 PLAN		
DP2.06	LEVEL 04 PLAN - RESIDENTIAL & AMENITY		
DP2.07	LEVEL 05 - 33 - TYPICAL RESID. FLOOR PLATE		
DP2.08	LEVEL 34 - OFFICE / MECHANICAL		
DP2.09	MECHANICAL CHILLERS		
DP2.10	ROOF TOP SCREEN		
DP4.00	BUILDING ELEVATIONS - S & W		
DP4.00A	BUILDING ELEVATIONS - COLOURED - S & W		
DP4.01	BUILDING ELEVATIONS - N & E		
DP4.01A	BUILDING ELEVATIONS - COLOURED - N & E		
DP5.00	BUILDING SECTIONS		
DP5.01	BUILDING SECTIONS		
	DETAILS		
DP6.02	SITE DETAILS		

CPC2021-1569 Attachment 1 CPC2021-1414 **ATTACHMENT 4**

PRELIMINARY SERVICING PLAN PRELIMINARY GRADING PLAN

LAYOUT PLAN - PODIUM

LAYOUT PLAN

ELECTRICAL SITE PLAN

AMENITY LEVEL, MECHANICAL PENTHOUSE LAYOUT & LUMINAIRE SCHEDULE

S O T F A		. Turt ÷ Minus SW Minus SW n	
COVER SHEET	4th Avenue Tower	#526 4TH AVENUE SW, CALGARY, AB, LOT 33, BLOCK 1, PLAN 0914296 LACAILLE	
cc	NOT F DNSTRU	FOR JCT I ON	
drawings. Verify all dime discrepancies are taken to fa face of stud fo walls, unless	nsions, elevations and to the Architect prior ice of exterior sheathin ir interior partitions, ar noted otherwise on the	sours. Do not scale these datums, and report any to construction. Dimensions (a face of concrete block, dicentreline of demissing e drawing, the Architect, These Indirecture, These drawings permission of the Architect,	
REVISION A D.P. S A DTR A DTR S		09.18.202 01.27.202 03.31.202	chitecture.c
SCALE DATE DRAWN BY CHECKED E		10:18:55 AM	3182-A-Base_d.ramire.
DRAWING		P0.00	C:/Revit Projects/215
			Pag


ge 1 of 31

Page 22 of 54

Vicinity Map	By-Law Zoning	Floor Area Ratio	Motor Vehicle Parking Requirements	Waste & Recycling Requirements		2
SITE (PARCEL A + B)	PART 13, DIVISION 2 - COMMERCIAL RESIDENTIAL DISTRICT (CR20-C20/R20) Part 13, Division 3 - Incentive Density	MAMMUM PERMITTED F.A.R. (SM) PROPOSED F.A.R. 1730.5 SM X 15.0 FAR 25,957 SM	THERE ARE NO REQUIREMENTS FOR COMMERCIAL PARKING IN THIS ZONE. PARKING RELAXATION FOR VISITOR STALLS COUNT TO BE REQUESTED, SUPPORTED BY THE TRAFFIC IMPACT STATEMENT.	*WASTE & RECYCLING CALCULATIONS BASED ON OTY / PUBLIC SERVICE STANDARDS TO MEET APPOXIMATE NEEDS. NO OFFICIAL REQUIREMENTS FOR PRIVATE PICK-UP.		
(PARCEL A + B)	COMMERCIAL RESIDENTIAL DISTRICT (CR-20-C20/R20) INCENTIVE DENSITY (PART 13, DANSION 3) USF-	GFA: +/- 26,161 SM 15,12 (+/- 204 sm EXCESS) FLOOR AREA RATIO CALCULATIONS	SUPPORTED BY THE TRAFFIC MARAGEST ALL EMENT. RESIDENTIAL - UNIT PARKING LINTE FACTOR (STALL PER	RESDENTIAL WASTE & RECVCLING NO. OF BINS (3 ydr) STORAGE DESCRIPTION QUANTITY RECURED PROVIDED REQUIRED PROVIDED STAGING	30	ペローマーキーした(1)UI・モー d009984 HRANDSSMedeman SW Hypery 46 RDEsisted (1998-06 Enands VOB 2K4
10007 7710000	DWELLING UNITS FLOOR AREA RATIO (FAR) = 3.0 ADDITIONAL INCENTIVE FAR = 12.0	DWELLING UNITS FAR: 3.0 × 1730.5 SM = ±5191.5 SM BONUSING FAR: 12.0 × 1730.5 SM = ±20.766 SM	DESCRIPTION QUANTITY DIVELLING UNITY REQUIRED PROVIDED RESIDENTIAL STANDARD 268 0.5 134 134	DESUMPTION DURINTITI REGISTED PROVIDED PROVIDED PROVIDED PROVIDED STRAING DWELLING UNIT 268 27 - 243m ² - 122m ²	T, Ro	Henry we pushed and a furnish of the second se
0033 //10956 DC 42D2010 42D2010 42D20000 42D200000000000000000000000000000000000	MAX POSSIBLE FAR = 15,0 PUBLIC AMENITY ITEMS THAT MUST BE PROVIDED TO ACHEVE ADDITIONAL FAR OF 12.0. Table 8 tem 80.4(a)(b) and (c):	$15.0 \times 1730.5 \text{ SM} = \pm 25.957 \text{ SM}$ EXCESS FAR: 26,161 SM (0FA) = 25.957 SM (15.0 FAR) = $\pm 204 \text{ SM}$ (0.12 FAR)	RESIDENTIAL - VISITOR PARKING			
	(a) at grade pedestrian circulation – public sidewalk setback area where: the portion of a parcel adjacent to a street must be a hard surface kindscaped area and: where it is part of an arcade must provide, an unobstructed depth of a minimum of 3.5 metres that does not contain structural elements of a building between grade and the bottom of the storey 	TOTAL GROSS FLOOR AREA TO BE ACHIEVED THROUGH BONUSING AND FINANCIAL Contributions.	QUANTITY DWELLING UNIT) REQUIRED PROVIDED RESIDENTIAL VISITOR 270 0.1 27 20	CALCULATIONS: RESIDENTIAL NAMETA CONCENT NO DECEMBER (200 NMTE (10) NO MAL BO AND	7	
[↑] DC 21 A 33 B 1 17 S 92D2008 0914297 ARW	above; and (B) where it is not part of an arcade, must not contain <u>structural elements of a building (1)</u> between grade and the bottom of the storev above for a minimum depth of 2,2 metres;	Area Summary	OFFICE - PARKING GROSS USABLE FACTOR	WASTE & RECYCLING PRODUCED (268 UNTS; 10) X3 yd ⁶ = 80.4 yd ⁶ BINS RECURRED 80.4 yd ⁶ y 3yd ⁶ = 26.8 BINS STORAGE AREA RECURRED 24.1 yd ⁶ y 200 AB BINS STAGNG AREA RECURRED 24.1 yd ⁶ Y STORAGE AREA (2 = 120.6 m ²	INFORMATION	Cower 0914296 ACAILLE 219182
8111784 731143 7811- 8111784 4 AV SM	(b) at grade pedestrian circulation provided within a triangular area formed on a corner parcel by the two property lines, as determined by Table 1, Road Rights-of-Way, and a straight line which intersects them 7.5 metres from where they meet which: (i) must not contain any buildings within 3.0 metres from where they meet;	NOTE: BALCONY, PATIO, TERRACE AND DECK AREAS, AND MECHANICAL AREAS OPEN TO THE ELEMENTS (LEVEL 35) ARE NOT INCLUDED IN GROSS FLOOR AREA CALCULATIONS.	USE FLOOR AREA STALL PER REQUIRED PROVIDED OFFICE 195.0 m 0.7 100 m2 2 2	TOTAL ROOM AREA REQUIRED: 361.8 m² COMMERCIAL WASTE & REFORLING PRODUCED 2 CRUs x 1 yd³ = 2 yd³	RMA	
41 11961 U&ARW 16 41 11961 U&ARW	(ii) may only contain pillars and structural supports in areas which are greater than 3.0 metres of where they meet; and (iii) must be a minimum height of 4.6 metres measured vertically from grade;	GROSS FLODR AREA Level 1 - Main 1038 m ² Gross Building Area Level 2 - Storape 350 m ² Gross Building Area		BINS RECURED 2 yth / 3 yth = 0.67 BINS STORAGE AREA RECURED 188 sm (9 sm / 1000 sm) = 9 sm STAGING AREA RECURED 9 m² STORAGE AREA / 2 = 4.5 m²	INFC	UG PLAI
1511960 PLANA1	(c) +15 Skywalk System provisions where: (i) +15 Skywalk System elements for potential connection to the +15 Skywalk System on the parcel and to adjoining parcels: (A) +15 Skywalk System walkway with an unobstructed width of 4.5 metres oriented in a manner	Level 3 - Amenity 1092 m² Gross Building Area Level 4 775 m² Gross Building Area Level 5 (Typ, 5-33) 775 m² Gross Building Area	Bicycle Parking Requirements	TOTAL ROOM AREA REQUIRED: 4.5 m² OFFICE WASTE & RECYCLING PRODUCED 2.0FFICES x 1. yd² = 2. yd³	ECT	<u> </u>
	that provides the greatest opportunity for connection to, and extension of, the +15 Skywalk System, as shown on a plan approved by the Development Authority: (B) structural supports, all locations indicated on a plan approved by the Development Authority, that	Level 6 775 m² Gross Building Area Level 7 775 m² Gross Building Area	RESIDENTIAL UNIT FACTOR STALL DESCRIPTION QUANTITY PER DWELLING REQUIRED PROVIDED	BINS RECURED 2 y0 ⁴ / 3 y0 ⁴⁰ = 0.67 BINS STORAGE AREA REQUIRED 190 sm (9 sm /1000 sm) = 9 sm STAGING AREA REQUIRED 9 m ⁴ STORAGE AREA / 2 = 4.5 m ²	PROJECT	I Ave Block
Municipal Address	would allow for possible expansion of the +15 Skywalk System bridge which must be incorporated into the overall structure and design of the building; and (C) vertical movement opportunities between grade and the second storey within a building, which must include:	Level 9 775 m² Gross Building Area Level 10 775 m² Gross Building Area	DESCRIPTION QUANTITY PER DWELLING REQUIRED [PROVIDED] CLASS 1 PARKING 268 1 268 268 CLASS 2 PARKING 268 0.1 27 28	TOTAL ROOM AREA REQUIRED: 4.5 m² Total Bins 26.8 + 0.67 + 0.67	E	4th ^{-33, B}
#526 4TH AVENUE SW CALGARY, AB. LOT 33, BLOCK 1, PLAN 0914296	 a <u>nublicly accessible elevator: and (2)</u> (II) either a pair of escalators or a staircase with a <u>minimum unobstructed width of 2.0 metres (3);</u> and 	Level 11 775 m² Gross Building Area Level 12 775 m² Gross Building Area Level 13 775 m² Gross Building Area Level 14 775 m² Gross Building Area	RETAIL	IF INCLUDES COMPACTOR BINS REGURED 28.1 BINS / 4 γσ ⁶ = 7.0 BINS STORARE AREA REQUIRED 7 BINS x 9 m ² = 63 m ²		Б
Legal Address	(ii) a financial contribution to the +15 Skywalk System Fund in accordance with the +15 Policy.	Level 14 775 m² Gross Building Area Level 15 775 m² Gross Building Area Level 16 775 m² Gross Building Area Level 16 775 m² Gross Building Area	DESCRIPTION QUANTITY REQUIRED PROVIDED CLASS 1 PARKING 188 sm 0 250 sm 1 1	STACING AREA REQUIRED 65 m ² STORAGE AREA / 2 = 31,5 m ² COMPACT AREA REQUIRED: 10 m ² TOTAL ROOM AREA REQUIRED: 10 4.5 m ² TOTAL ROOM AREA REQUIRED: 10 4.5 m ²		AB, L
LOT 33, BLOCK 15, PLAN 0914296	By-Law Setback	Level 17 775 m ² Gross Building Area Level 18 775 m ² Gross Building Area Level 19 775 m ² Gross Building Area	CLASS 2 PARKING 188 sm 1 250 sm 1 1 OFRCE FACTOR (STALL	Peridential Amerity Space		GARY, <i>H</i>
Site Summary	FRONT: 0.0m REAR: 0.0m SIDE: 0.0m	Level 20 775 m ² Gross Building Area Level 21 775 m ² Gross Building Area Level 22 775 m ² Gross Building Area	DESCRIPTION QUANTITY STALL PER PER CLASS 1 PARKING 190 sm 1 1 1	Residential Amenity Space		ILGA
SITE AREA: PARCELS A + B 2,599.7m ² 0.64 a.c/ 0.26 ha	NOTE: - 2.134m PUBLIC REALM SETBACK LOCATED ALONG 4TH AVENUE SW AND 5TH STREET SW.	Level 23 775 m ² Gross Building Area Level 24 775 m ² Gross Building Area Level 25 775 m ² Gross Building Area	CLASS 2 PARKING 190 sm 1 1000 sm 1 1	REQUIRED: 268 UNITS X.S.O.SM. PER UNIT – 1340 SM PROPOSE:		, CAL
PARCEL A (WEST OF PROPOSED PROPERTY LINE) 1730.5 m ²	-7.5m VSBRUTY TRANSLE SETBACK. BULDINGS, RINSHED GRADE OF A PARCEL AND VSEGETATION WITHIN A CORPHEN VSBRUTY THANGLE MUST NOT BE LOCATED BETWEEN 0.75 METRES AND 4.6 METRES ABOVE THE LOWEST ELEVATION OF THE STREET, -6m SETBACK FROM PROPERTY LINE ADJACENT TO A LANE; MS SETBACK FROM PROPERTY LINE	Level 26 775 m ² Gross Building Area Level 27 775 m ² Gross Building Area Level 28 775 m ² Gross Building Area	TOTAL REQUIRED BICYCLE - CLASS 1 PARKING (WALL-MOUNTED VS FLOOR-MOUNTED): RESIDENTIAL BIKE STORAGE	100 04-05 320 SM + 431 SM + 399 SM = 1150 SM PROPOSED BREAKDOWN		Ś
0.43 ac / 0.17 ha	ADJACENT TO ANOTHER PROPERTY, FOR DWELLING UNIT GLAZING.	Level 29 775 m² Gross Building Area Level 30 775 m² Gross Building Area Level 31 775 m² Gross Building Area	LEVEL - 02 0 WALL-MOUNTED 40 FLOOR-MOUNTED	PRIVATE AMENTY SPACE 6 UNITS (LEVEL 04) x 5 SM - 20 SM		AVENUE
	Proposed Development	Level 32 775 m² Gross Building Area Level 33 775 m² Gross Building Area Level 34 - Mech P 01 / Office 431 m² Gross Building Area	LEVEL-01 22 WALL-MOUNTED	2 UNITS X 29 FLOORS X 5 SM = <u>290 SM</u> TOTAL = 320 SM		H AVE
	DWELLING UNITS (DISCRETIONARY USE) RETAIL AND CONSIMER SERVICE (DISCRETIONARY USE) OFFICE DISCRETIONARY USE)	Level 35 Mech Chillers 0 m²l Gross Building Area Grand total 35 26161 m²	PARKADE - P1 40 WALL-MOUNTED 0 FLOOR-MOUNTED	COMMON AMENITY SPACE (TOTAL REQUIRED AMENTY SPACE – PRIVATE AMENITY SPACE) 1340 SM – 320 SM – 1020 SM		3 4TH
	BUILDING CLASSIFICATION AS PER ALBERTA BUILDING CODE: GROUP C, ANY HEIGHT, SPRINKLERED	Dwelling Unit Count	PARKADE - P2 36 WALL-MOUNTED 30 FLOOR-MOUNTED	INDOOR / OUTDOOR SPLIT (MAX 50% INDOOR) 1202 SM / 2		#526
		UNIT NAME UNIT TYPE UNIT AREA QUANTITY	PARKADE - P3 36 WALL-MOUNTED	LEVEL 03 GYM = 219 SM COWORNING SPACE / CAPE = 212 SM		
	Building Height	UNIT 01 2 BED 90.8 m² 30 UNIT 02 1 BED 63.4 m² 29	30 FLOOR-AIOUNTED PARKADE - P4 0. WALL-MOUNTED	TOTAL = 431 SMI) LEVEL 04		
	THERE IS NO MAXIMUM BULLINIG HEIGHT, EXCEPT THAT THE SUNLIGHT PROTECTION AREA MUST NOT BE PLACED IN GREATER SHADOW BY A DEVELOPMENT AS MASURED 10.0m FOR PORTIONS OF A BULLINIG WITH IN 3m OF A STREET FOR STREET-ORIENTED MULTI-RESIDENTIAL	UNIT 03 2 BED 88.9 m ² 29 UNIT 04 1 BED 59.2 m ² 29 UNIT 05 1 BED 59.2 m ² 29	3 HELORAUUNITED TOTAL RESIDENTIAL 134 WALL-MOUNTED	0/UTDOR AMENTY = 297 SM NDOR AMENTY = 102 SM TOTAL = 399 SM		
	BUILDINGS. REFER TO DP1.01 FOR SHADOW STUDY. PROPOSED HEIGHT: 111.75 m / 1160.02 GEO	UNIT 06 2 BED 88.9 m² 29 UNIT 07 1 BED 63.4 m² 29 UNIT 08 2 BED 90.8 m² 30	134 WALL-MOUNTED 134 FLOOR-MOUNTED 268 RESIDENTIAL BIKE STALLS			
		UNITO9 1 BED 55.1 m² 30 UNIT12 1 BED 63.4 m² 1	COMMERCIAL & OFFICE BIKE STORAGE			
		UNIT 13 2 BED 95.0 m² 1 UNIT 16 2 BED 95.0 m² 1 UNIT 17 1 BED 63.4 m² 1	2 WALL-MOUNTED <u>TOTAL:</u> REOD: 270			
		TOTAL 268	PROVIDED: 270			
		UNIT 13 AND 16 ARE DESIGNED TO BE UNIVERSAL LEVEL 04 ONLY.	RESIDENT ACCESS TO CLASS I BICYCLE STORAGE ON PA, P3, P2, P1, L1, AND L2, RESIDENTS ARE PERMITTED USE OF ELEVATOR FOR BICYCLE STORAGE ACCESS FOR LIFE OF THE BUILDING. REFER TO PATH OF ACCESS AND NOTE INDICATED ON DP2.03.			NOT FOR
		Density	_		CC	DNSTRUCTION
		DENSITY (UNITS PER HECTARE) UNITS HECTARE 268 0.17 1,576			drawings.	upercedes previous issues. Do not scale these nsions, elevations and datums, and report any
					discrepancies are taken to fai	Issona, revealous and outline, and report any to the Architect prior to construction. Dimensions be of exterior sheathing, face of concrete klock, r interior partitions, and centreline of demising oded otherwise on the drawing.
						emain the property of the Architect. These Sopyright 2020, S2 Architecture, These drawings produced without the permission of the Architect.
					REVISION	DATE
					🖄 DTR 1	
						03.31.2021
					SCALE	d.amirezco
					DATE DRAWN BY CHECKED B	
					DRAWING N	ste
						DP0.01
14 Attachment 4						Page

CPC2021-1569 Attachment 1

CPC2021-1414 ATTACHMENT 4

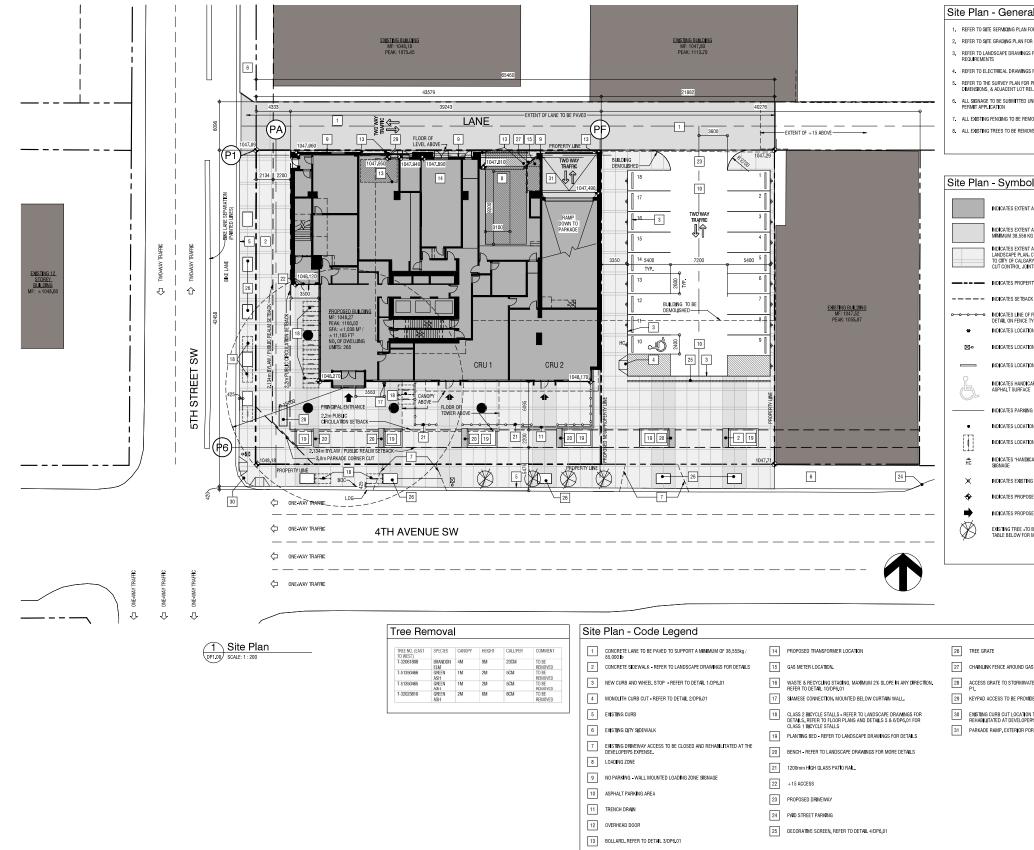

CPC2021-1569 Attachment 1

CPC2021-1414 ATTACHMENT 4

AI NOTES OR SITE SPECIFIC REQUIREMENTS R ALL RELATED SITE GRADING FOR ALL LANDSCAPE SPECIFIC SFOR PROPOSED LIGHTING PROPERTY LINE & RIGHT-OF-WAY	a Q V N N		
In the provide the second of t	SITE PLAN	4th Avenue Tower #526 4TH AVENUE SW, CALGARY, AB, LOT 33, BLOCK 1, PLAN 0914296 LACAILLE	
IS METER, REFER TO DETAIL 7/0P6.01 TER TANK LOCATED ON PARKADE LEVEL DED FOR WASTE FACILITIES I TO BE MAINTAINED, TO BE NS EXPENSE. INTIDIN OF RAMP HEATED.	This drawing drawings. Very gladies in the second second in the second second in the second second drawing and may not be no drawing and drawing and dra	2 03.31.2021 As indicated 10/12/2021 10:19:15 AM MC Y JC	Revit Projects (219182 A Base dramirezcorbo@s2architecture.com.nt
	DRAWING	DP1.00	2:/Revit Projects/2

RIVERBANK + RIVERBANK PROMENADE

















BARCLAY MALL




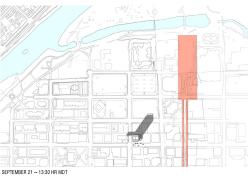




MEWATA ARMOURY + McDOUGALL SCHOOL

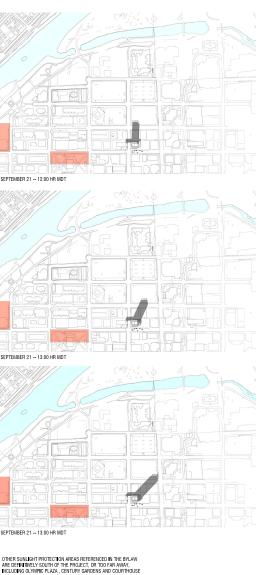

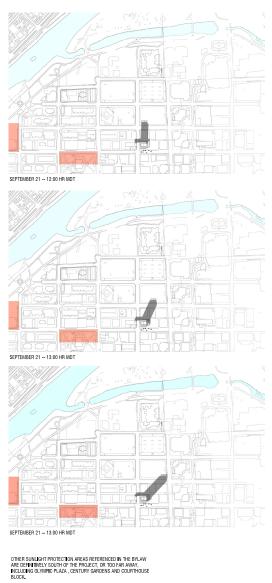

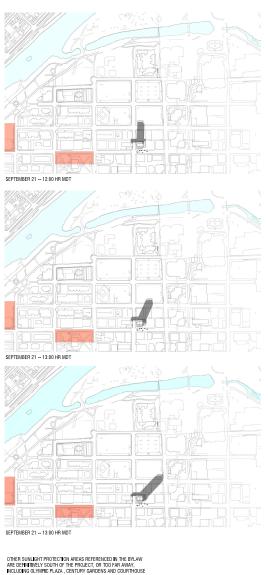

CPC2021-1414 Attachment 4 ISC: UNRESTRICTED CPC2021-1569 - Attachment 1 ISC: UNRESTRICTED

CPC2021-1569 Attachment 1


CPC2021-1414 ATTACHMENT 4






SHADOW STUDY	4th Avenue Tower #526 4TH AVENUE SW, CALGARY, AB, LOT 33, BLOCK 1, PLAN 0914296 LACAILLE					
NOT FOR CONSTRUCTION The drawing supercodes previous issues, Do not scale these available to the supercode spectrum of the scale these versions are supercoded and statumes, and regord target are staten to face of scale of the scale the scale the scale of state of the information, and confidence of demaining walls, unless roles of demained and the scale the scale of scale of scale of the scale theory is the scale theory of the scale scale scale scale scale scale scale scale scale scale of scale scale scale scale scale scale scale scale scale scale of scale scale scale scale sc						
1 D.P. SUBMISSION OR.18,2020						
REMISION DATE 1 D.P. SUBMISSION 08.18.2020 SCALE 1 : 12 DATE 101/2/2021 10:19:25 AM DRAWN BY AG OR CHECKED BY JC JC						
DRAWING NO. DP1.01						
Page 4 of 31						

Page 25 of 54

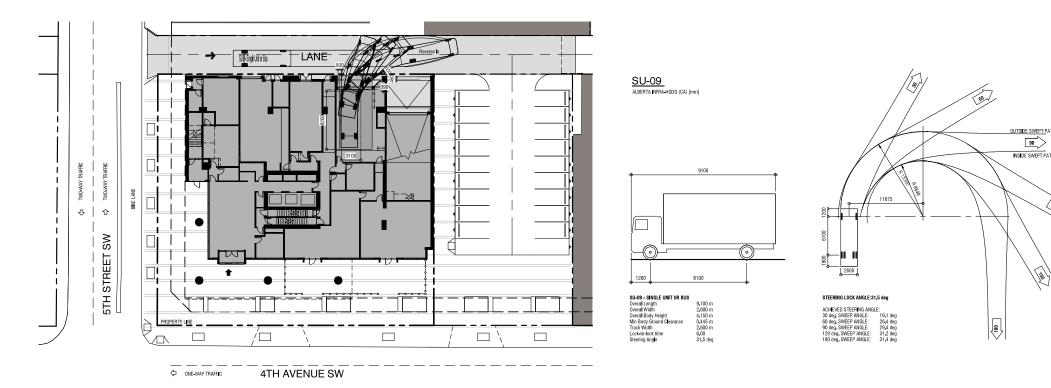



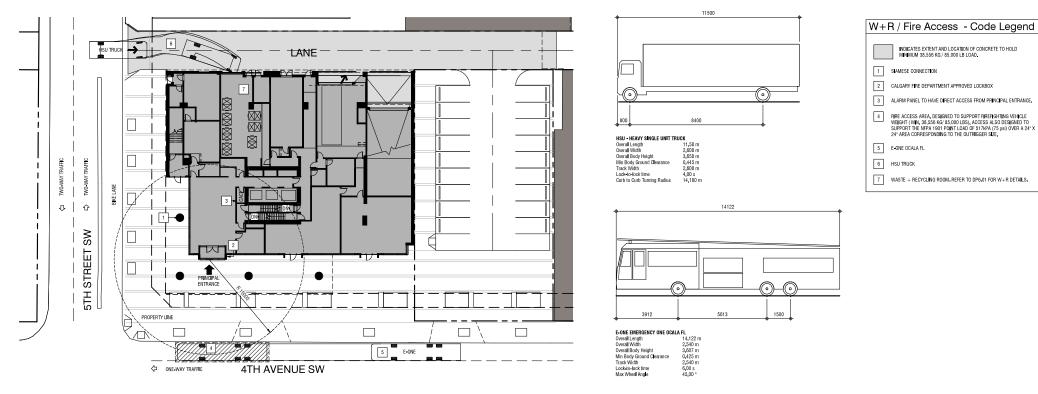

4 Waste + Recycling Collection / Fire Access


CPC2021-1414 Attachment 4 ISC: UNRESTRICTED CPC2021-1569 - Attachment 1 ISC: UNRESTRICTED

CPC2021-1569 Attachment 1

CPC2021-1414 ATTACHMENT 4

		IT al e nue EW Kog⊄anada V68 2K4	
SITE ACCESS DIAGRAMS	4th Avenue Tower	#526 4TH AVENUE SW, CALGARY, AB, LOT 33, BLOCK 1, PLAN 0914296 LACAILLE	
This drawing drawings Verify all dim discrepancies are taken to f face of stud f walls, unless	NOT F DNSTRU supercodes previous its to the Architect prior to ace of exercor sheating or inferior participes, and noted otherwise on the		un nd
A D.P. A DTR A DTR A DTR SCALE DATE DRAWN BY	2 As indicated 10/12/2021 10	09.18,2020 01.27,2021 03.31.2021	0187-A-Base d ramirezconho@e0architacture com
DRAWING		P1.02	Douit Broiocte/0101

Page 5 of 31

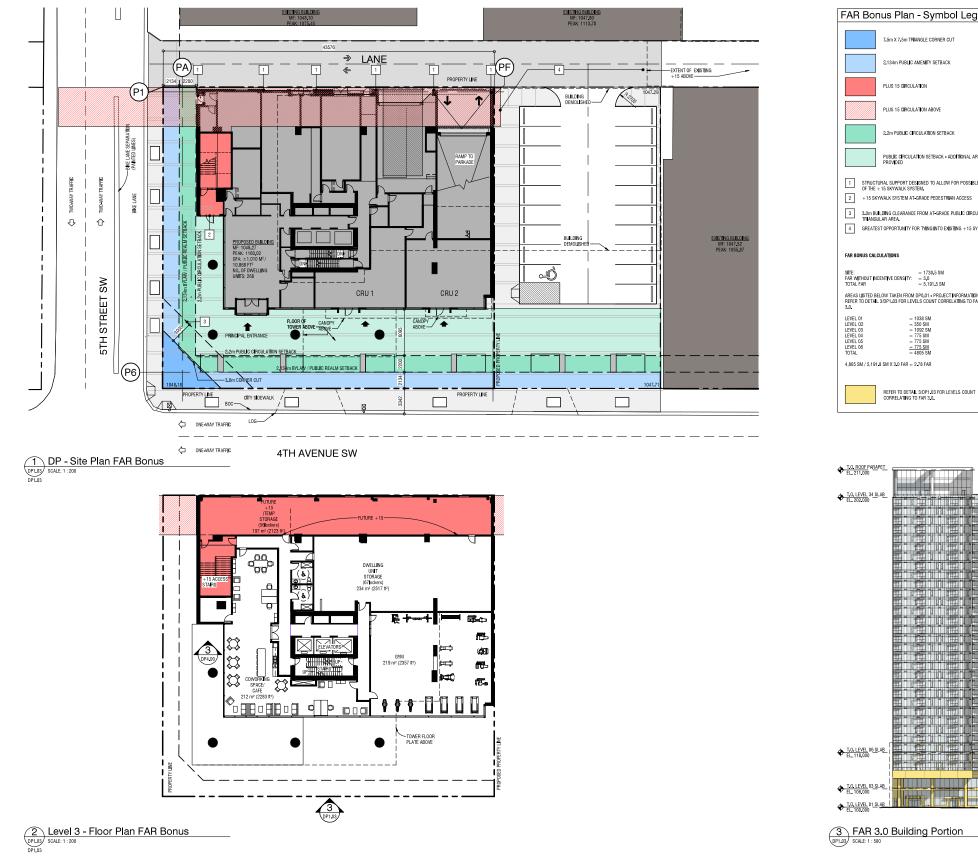


CPC2021-1569 Attachment 1

CPC2021-1414 ATTACHMENT 4

Legend	
IONAL AREA	
POSSIBLE EXPANSION	
LIC CIRCULATION	
G +15 SYSTEM.	
NOITAMAC	
ORMATION. ING TO FAR	
S COUNT	
mi	-
	-
	ļ
	-
	<u>.</u>


Received and the second					
FAR BONUS DIAGRAMS	4th Avenue Tower #526 4TH AVENUE SW, CALGARY, AB, LOT 33, BLOCK 1, PLAN 0914296 LACAILLE				
NOT FOR CONSTRUCTION					
This drawing separateles previous issues, Do not scale these classifier. Very all clinearies and datums, and report any decorpancies to the Architect profe construction. Dimensione are liable to their deciming lases do converte lacks, and the second clinearies and the second lases of the additional second lases and the second lases of walks, unless coled dominant on the drawing. All drawings remain the property of the Architect Trave may not be improduced without the permission of the Architect <u>PEVMSION DATE</u>					
A D.P. SUBMISSION 00,18,2020 A DTR 1 01,27,2021 A SCALE As indicated					
DATE DRAWN BY CHECKED E	10/12/2021 10:19:45 AM Author	2182_0_Bace d r			
DRAWING NO. DP1.03					

Page 6 of 31

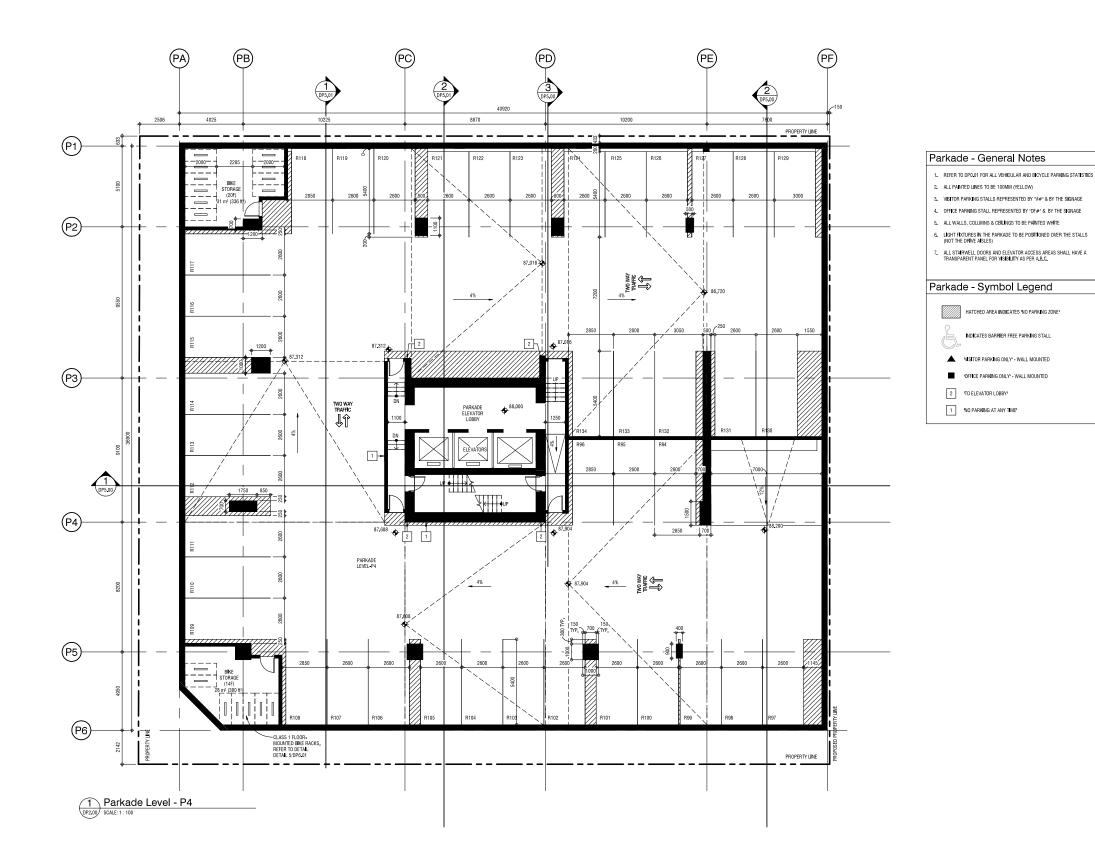


CPC2021-1569 Attachment 1

CPC2021-1414 ATTACHMENT 4

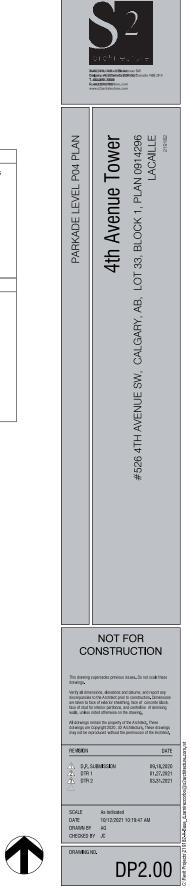

Page 7 of 31

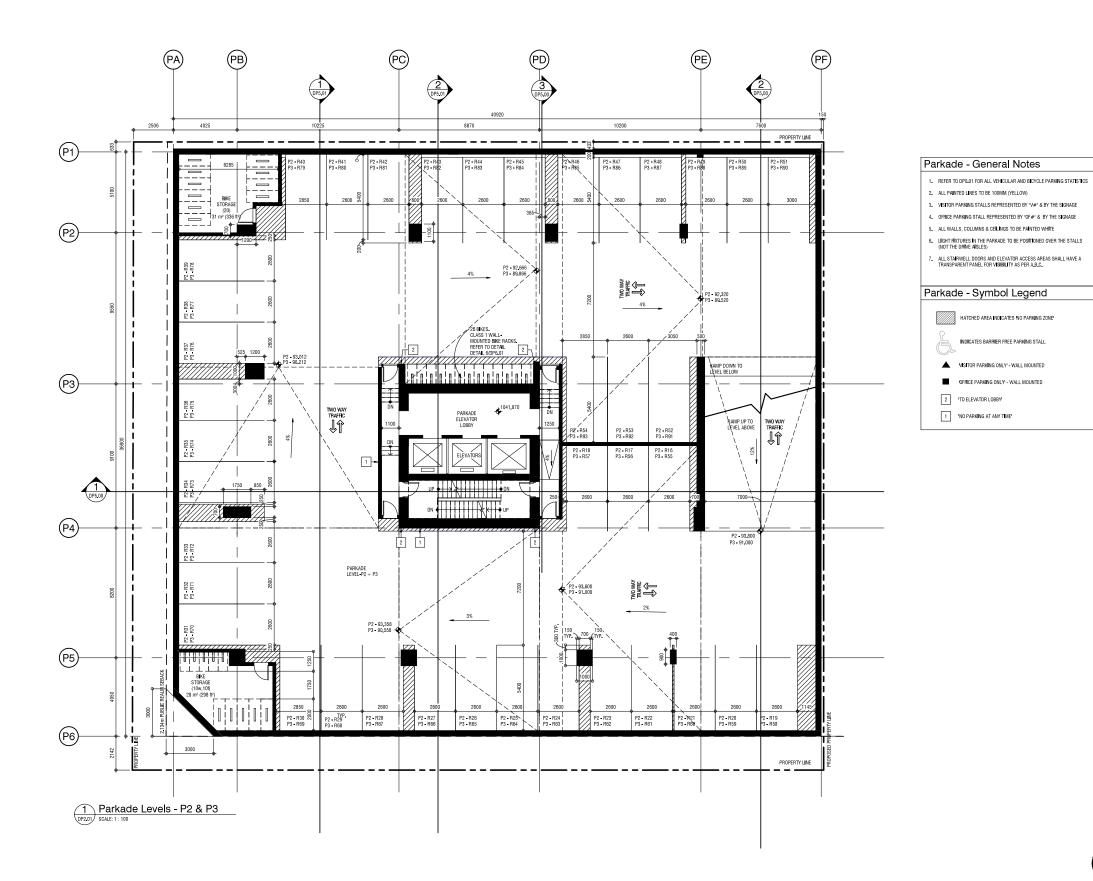


CPC2021-1569 Attachment 1

CPC2021-1414 ATTACHMENT 4


s T R M		
PARKADE LEVEL 02	4th Avenue Tower #526 4TH AVENUE SW, CALGARY, AB, LOT 33, BLOCK 1, PLAN 0914296 LACAILLE	
co	NOT FOR DNSTRUCTION	
drawings. Verify all dime discrepancies are taken to fa face of stud fo walls, unless	supercodes previous issues. Do not solar these melons, elevations and datums, and report any to the Anthelic prore to construction. Dimensions to the Anthelic prore to construction. Dimensions meter determine on the drawing meter determine on the drawing produced without the permission of the Anchhel.	-
	DATE SUBMISSION 09,16,2020 1 01,27,2021	\Revit Projects/219182-A-Base_d ramirezcorbo@s2architecture.com.rvt
SCALE DATE DRAWN BY CHECKED E	As indicated 10/12/2021 10:19:49 AM AG 3Y JC	219182 A Base d rami
DRAWING	DP2.01	0:/Revit Projects/2

Page 8 of 31

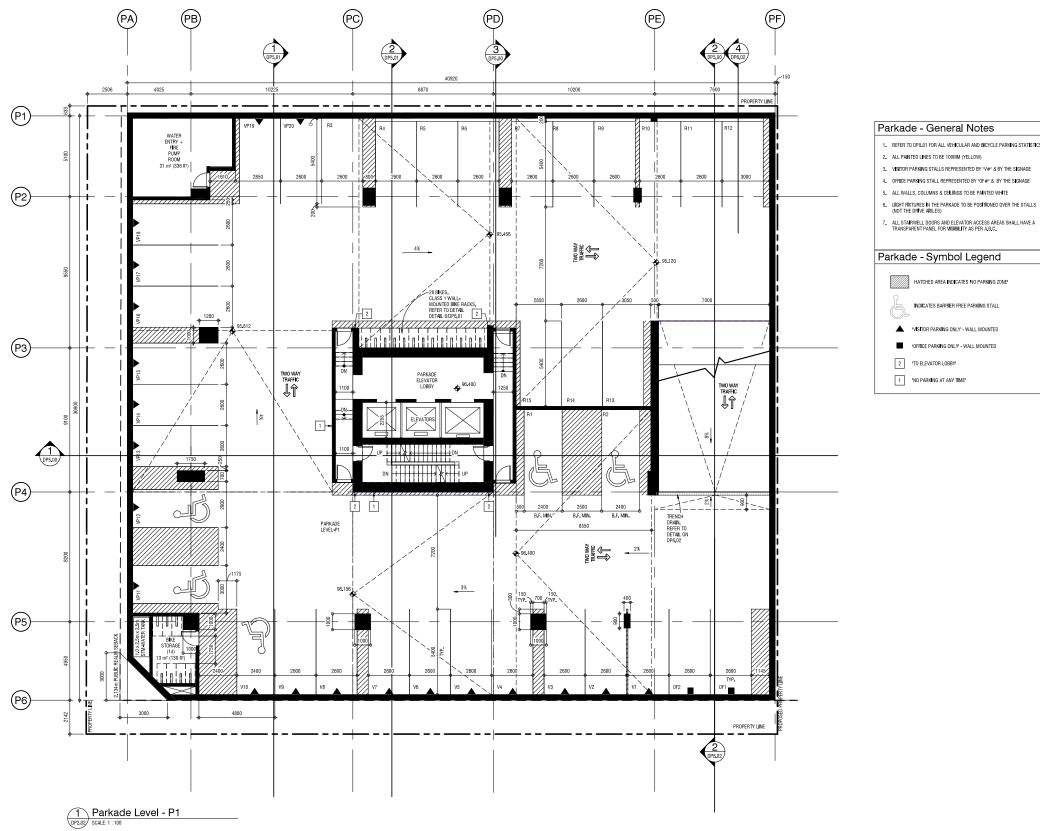

4. OFFICE PARKING STALL REPRESENTED BY "OF#" & BY THE SIGNAGE

- 5. ALL WALLS, COLUMNS & CEILINGS TO BE PAINTED WHITE
- 6. LIGHT FIXTURES IN THE PARKADE TO BE POSITIONED OVER THE STALLS (NOT THE DRIVE AISLES)

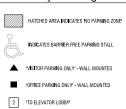


CPC2021-1569 Attachment 1

CPC2021-1414 **ATTACHMENT 4**

RKING STATISTICS	

PARKADE LEVEL 01	4th Avenue Tower #526 4TH AVENUE SW, CALGARY, AB, LOT 33, BLOCK 1, PLAN 0914296 LACAILLE	
co	NOT FOR DNSTRUCTION	
Varibual dime	supercedes previous issues. Do not scale these insions, elevations and datums, and report any	
discrepancies are taken to fa face of stud fo walls, unless	to the Architect prior to construction. Dimensions ace of exterior sheathing, face of concrete block, or interior partitions, and centreline of demising noted otherwise on the drawing.	
All drawings r drawings are may not be re REVISION	emain the property of the Architect, These Copyright 2020, S2 Architecture, These drawings produced without the permission of the Architect DATE	M de
	SUBMISSION 09.18.2020	c, filent Projects 219152-ASaedramirezoehogo/Saethineturu.com.nr
SCALE DATE DRAWN BY CHECKED B		9182-A-Base_dramire
DRAWING	DP2.02	215 Revit Projects 215

Page 9 of 31

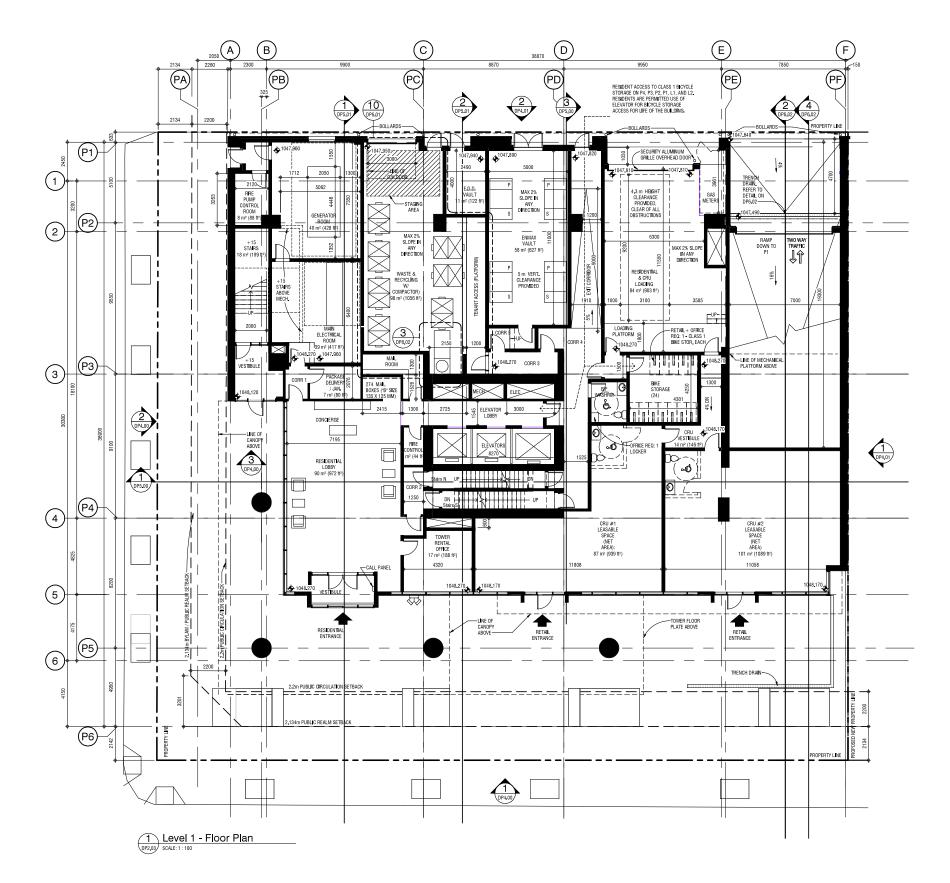


CPC2021-1569 Attachment 1

CPC2021-1414 ATTACHMENT 4

TEVEL DE LA	a c T R W		2 21 June Reg Grands Vog 2K4		
CONSTRUCTION The drawing superviseds previous issues. Do not scale these many supervised previous issues, Do not scale these many supervised issues and takens, and record takens out of take of interpretations; and order takens out, and takens out of drawing and the drawing. All drawing menning trengority of the Architecture, These drawing on the interpretations of the Architecture.	LEVEL 01 PLAN - MAIN FLOOR	4th Avenue Tower	#526 4TH AVENUE SW, CALGARY, AB, LOT 33, BLOCK 1, PLAN 0914296 LACAILLE	2002	
drawing. We'ry a diameans, elevations and fature, and recort any discognances in the Activity per to controllor. Dimensions are treater to face of a control to the control face of table for interce particles, and certreline of dimension wells, unless notice dimension on the drawing. All disrwangs and cognition 2003. Site Architect, These dimensions are produced without the permission of the Architect may not be reproduced without the permission of the Architect	co				
REVISION DATE ① D.P. SUBMISSION 09.18,2020	drawing, Whyly dia smallarsky, a hydror and datum, and report any designations to the Architeg root to construction. Unaverse an issue to take on denor healthing, have downstree and an issue to take on denor healthing, have downstree and and and the formation provides and and and while, unless root downsee on the downset. These downset and downset are Compared 2020. So Architecture, Twee downset may not be reported without the permission of the Architect.				
A D.P. SUBMISSION 09.18,2020 Å DTR 1 01.27,2021 Å DTR 2 03.31,2021					
SCALE 1:100 DATE 10/12/2021 10:19:54 AM DRAWN BY AG CHECKED BY JC DRAWING NO. DRAWING NO.	DATE DRAWN BY CHECKED E	10/12/2021 1 AG Y JC	0:19:54 AM	ATE 020 021 021	



Page 10 of 31

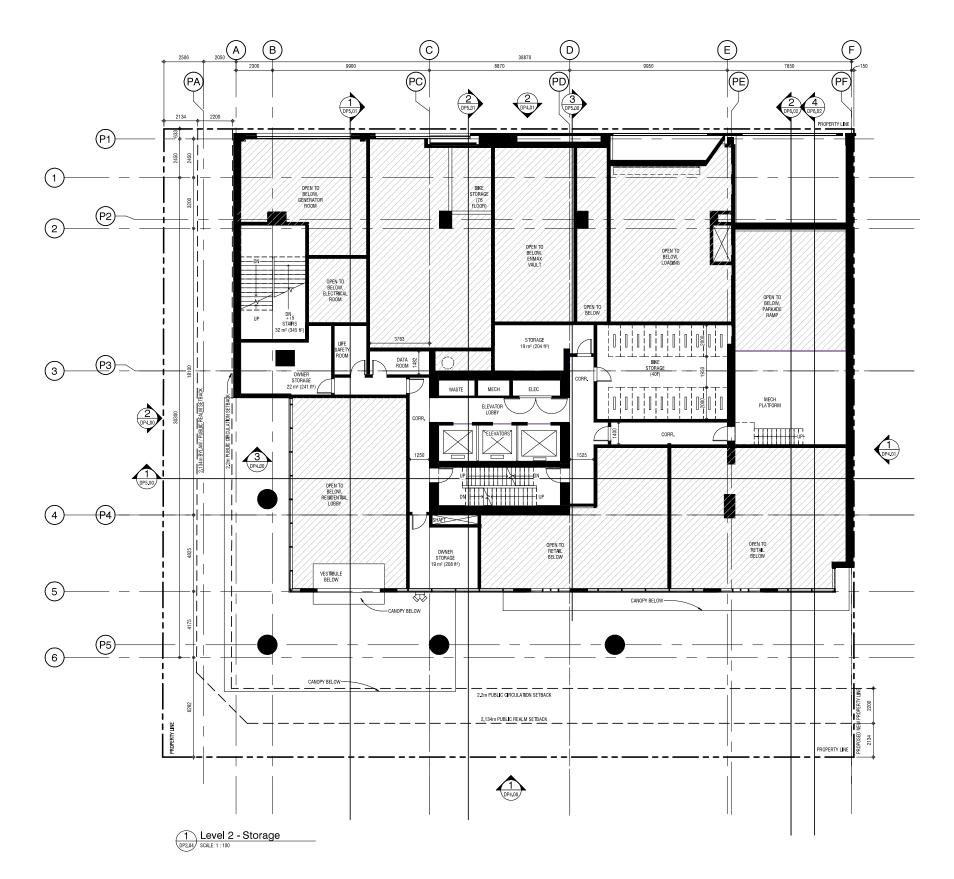


CPC2021-1569 Attachment 1

CPC2021-1414 ATTACHMENT 4





Page 11 of 31

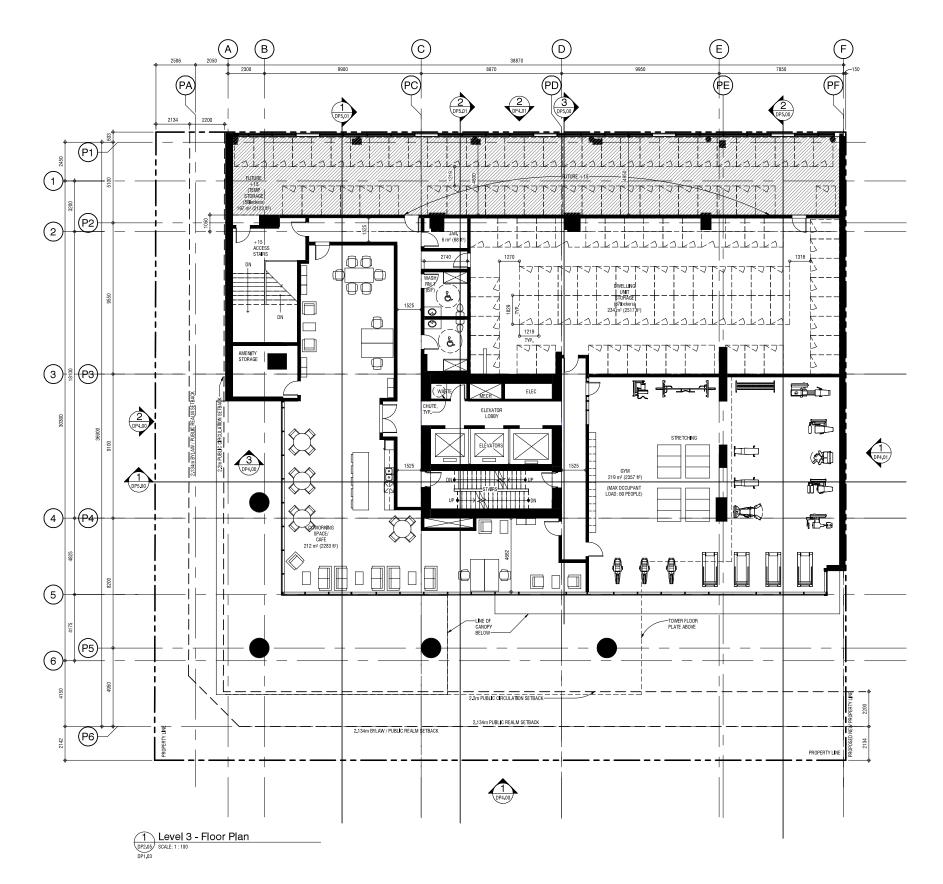


CPC2021-1569 Attachment 1

CPC2021-1414 ATTACHMENT 4





Page 12 of 31

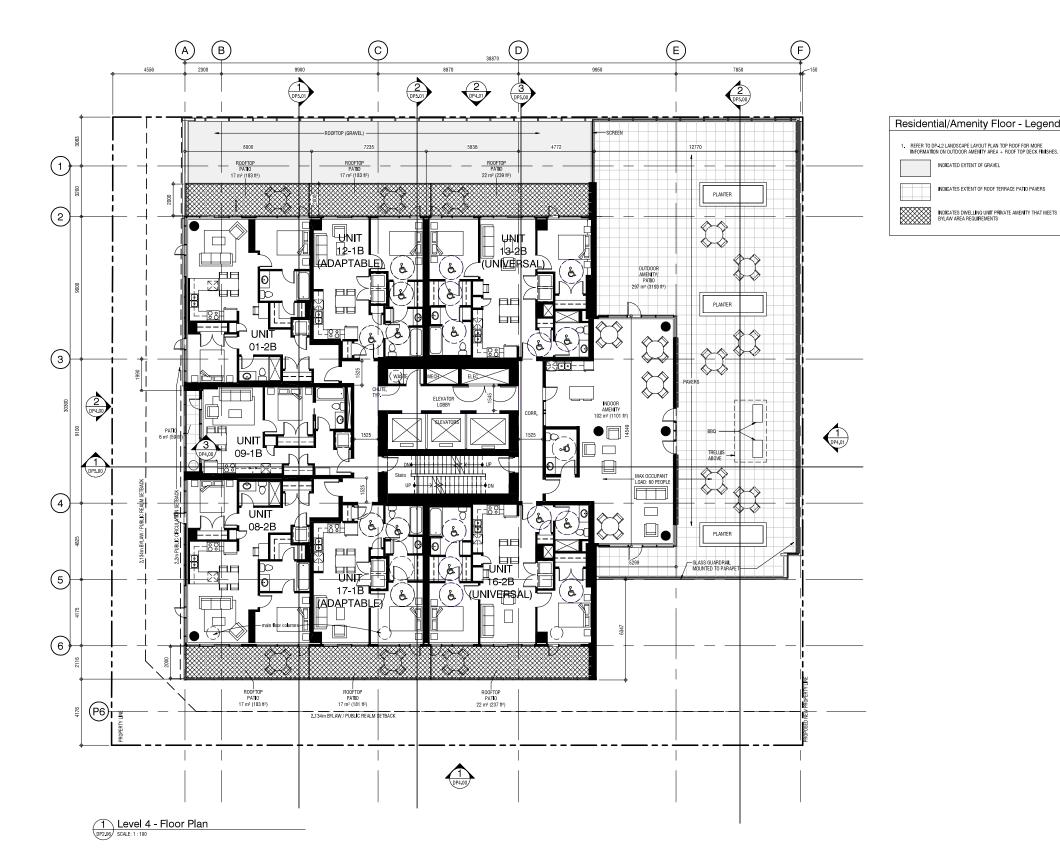

CPC2021-1569 Attachment 1


CPC2021-1414 **ATTACHMENT 4**



gend	

LEVEL 04 PLAN - RESIDENTIAL & AMENITY	4th Avenue Tower #526 4TH AVENUE SW, CALGARY, AB, LOT 33, BLOCK 1, PLAN 0914296 LACAILLE				
	NOT FOR CONSTRUCTION				
This drawing supercises previous source. Do not peake these drawings. Verify all chremistors, elevations and ditums, and report any discorepancies to the Architect prior to construction. Dimensions are laten to fails of elevation prior and elevations. These of study of mainter participant, and elevations of elevations wells, subclass midel otherwise on the drawing. All drawings frame the property of the Architect. These					
All dawings neman the property of the Architet, These trainings an Copyright 200, 34 Architect, These may not be reprodued without the permasulor of the Architect, REVISION DATE					
REMISION DATE DP, SUBMISSION 09,16,2020 DTR 1 01,27,2021 SGALE 1 : 100 DATE 101/2,2021 10 20.02 AM DRAWN BY Author CHECKED BY Checker DRAWNING NO. DP2.006					
SCALE 1:100 DATE 10/12/2021 10/20:02 AM DRAWN BY Author CHECKED BY Checker					
DP2.06					

⁷Page 13 of 31

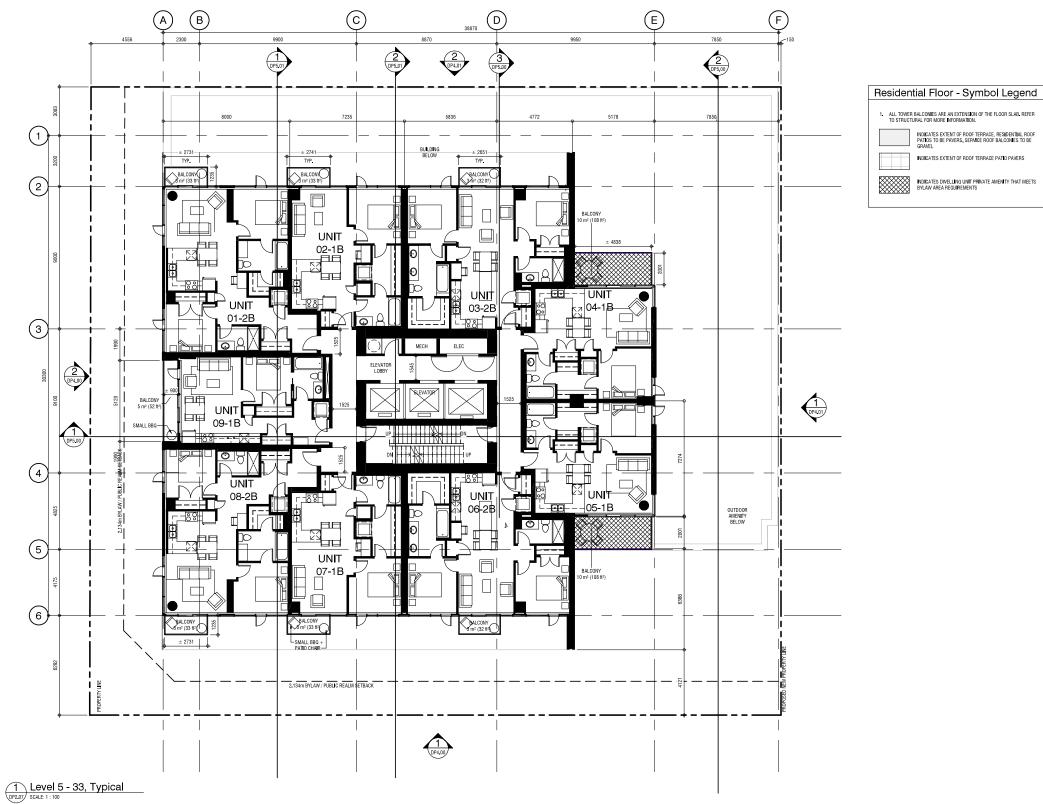

CPC2021-1569 Attachment 1

CPC2021-1414 **ATTACHMENT 4**


Calpany ASBDash Do J2Ro T.4804000, RAME Fc44328001808ture.com



 \bigcirc

LEVEL 05 - 33 - TYPICAL RESID. FLOOR PLATE	4th Avenue Tower	#526 4TH AVENUE SW, CALGARY, AB, LOT 33, BLOCK 1, PLAN 0914296 LACAILLE	219182	
СС	NOT F		N	
drawings. Verify all dime discrepancies are taken to fa face of stud fo walls, unless	supercedes previous à resions, elevations ann to the Architect prior ce of exterior sheathr ce of exterior sheathr ce of exterior sheathr reterior and the property of copyright 2020, S2 A produced without the	d datums, and repo to construction. Dir ing, face of concret ind centreline of der e drawing.	rt any nensions e block, mising	2
REVISION	SUBMISSION		DATE 18.2020	tecture, com n
A DTR		01.	27.2021	2corbo@s2archi
SCALE DATE DRAWN BY CHECKED E	1 : 100 10/12/2021 1 Author IY Checker	0:20:05 AM		32.A.Base_d.ramire
DRAWING		P2.()7	C: Rent Projects 2:19 182-4-8ase_ duminecorbo@r2architecture.com.on
			Р	age 14 of 31

Page 14 of 31

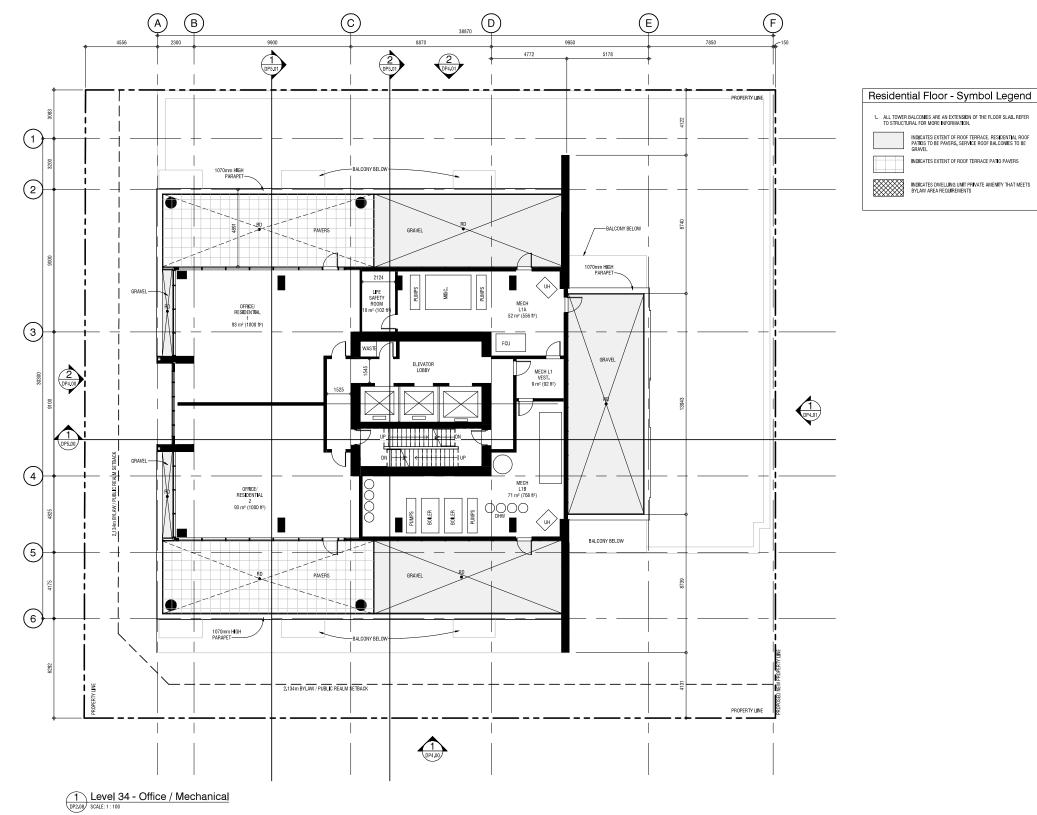


CPC2021-1569 Attachment 1

CPC2021-1414 **ATTACHMENT 4**



LEVEL 34 - OFFICE / MECHANICAL	4th Avenue Tower #526 4TH AVENUE SW, CALGARY, AB, LOT 33, BLOCK 1, PLAN 0914296 LACAILLE	
NOT FOR CONSTRUCTION		
This drawing supercodes previous issues. Do not scale these drawings.		
Verify all dimensions, elevations and datums, and report any deseguates to the Architect grave to costatudent. Dimensions are listen to these of elevators healting, and elevator devices and elevation factor of shuf for interce partners, and centre-line of neurinary walls, utiliss noted doriverse on the device.		
All drawings remain the property of the Architect. These drawings are Copyright 2020, S2 Architecture. These drawings may risk be reproduced without the permission of the Architect.		
REVISION DATE 1 D.P. SUBMISSION 09.18.2020		
2 DTR	1 01.27.2021	orbo@s2archi
SCALE DATE DRAWN BY CHECKED E	C: Rent Projects 2:19:182-4-8aed.um/recorbo@r2.achtheune.com.nt	
DP2.08		
		Page 15 of 31

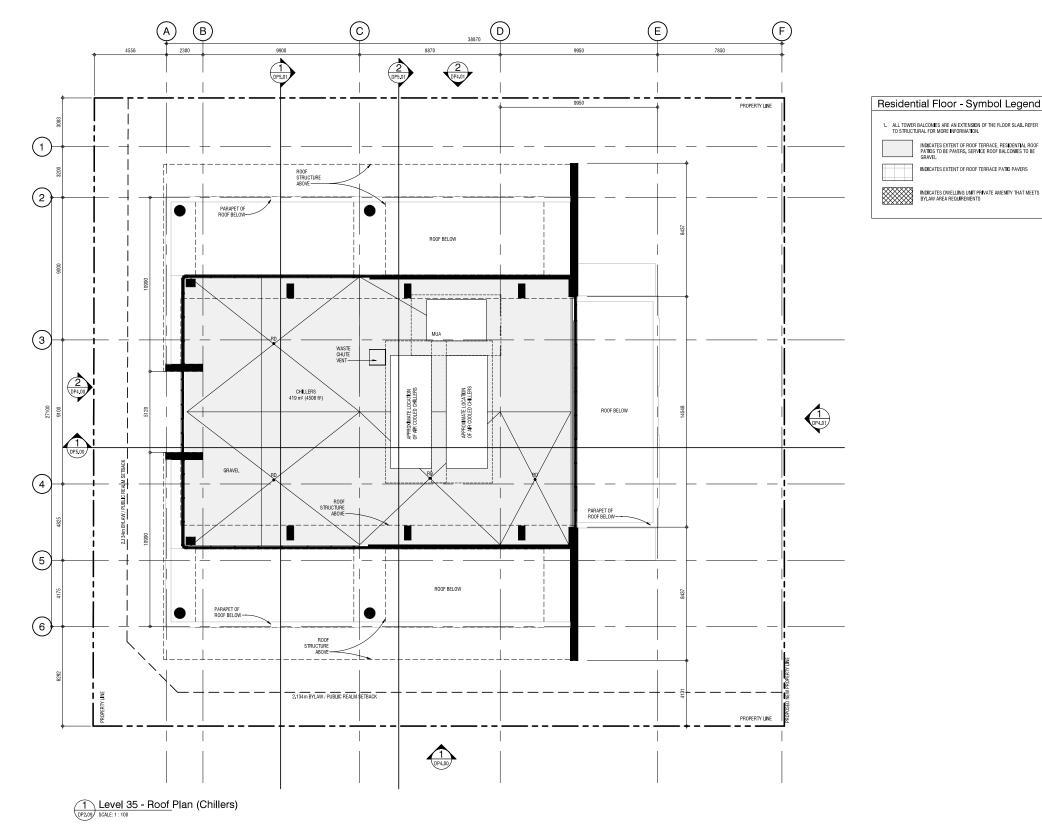

CPC2021-1569 Attachment 1

CPC2021-1414 **ATTACHMENT 4**



4th Avenue Tower


MECHANICAL CHILLERS

LOT 33, BLOCK 1, PLAN 0914296 LACAILLE

_	-		-1	
п	ρ	n	а	
-	-		9	

#526 4TH AVENUE SW, CALGARY, AB,	
NOT FOR CONSTRUCTION	
This drawing supercodes previous issues. On red scale these drawing. Very signal dramations, elevations and datums, and report any decreasances to be activations and and any strain and any the signal strain and the strain and strains. The similar walks, whiles redorting on the drawing the similar and drawings means the property of the Activities. These may not be reproduced without the permission of the Architect.	
REVISION DATE	re. com M
1 D.P. SUBMISSION 09.18,2020 2 DTR 1 01.27,2021	Rent Projects (21918:2-4-8aee_d.um/recordor);2-2ae/hite/une.com vi
SCALE 1 : 100 DATE 10/12/2021 10:20:08 AM DRAWN BY Author CHECKED BY Checker	182-A-Base_drami
DRAWING NO. DP2.09	Revit Projects (219

[•]Page 16 of 31

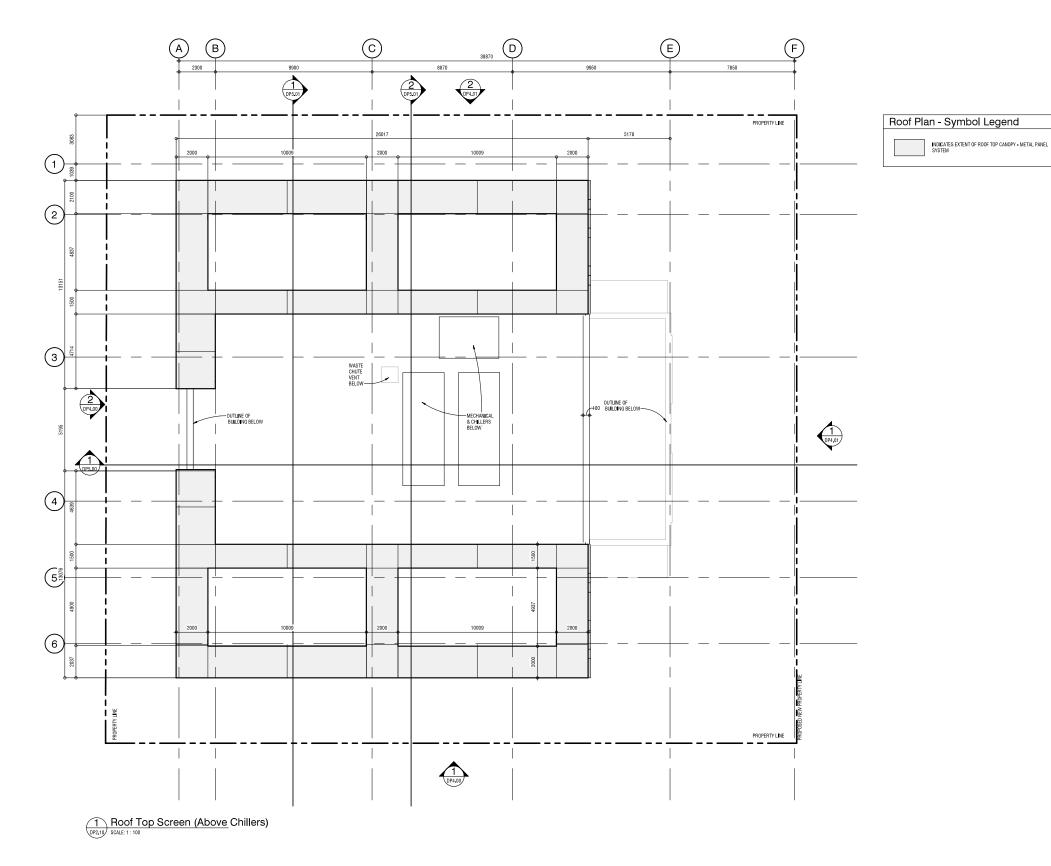

CPC2021-1569 Attachment 1

CPC2021-1414 TTACHMENT 4

ROOF TOP SCREEN	4th Avenue Tower	#526 4TH AVENUE SW, CALGARY, AB, LOT 33, BLOCK 1, PLAN 0914296 LACAILLE

NOT FOR CONSTRUCTION

are taken to fa face of stud fo walls, unless All drawings remain th drawings are Copyrig may not be reproduce

REVISION

DRAWING NO.

1 D.P. SUBMISSION 2 DTR 1

 SCALE
 1 : 100

 DATE
 10/12/2021 10:20:10 AM

 DRAWN BY
 Author

 CHECKED BY
 Checker

DATE


⁷Page 17 of 31

Page 38 of 54

09.18.2020 01.27.2021

DP2.10

EL 211.000	
EL 211 000	╫ <mark>╞╫╪╪╪╪╪╫</mark> ╠╪╪ <u>╫</u> ╪╪╪╪┼
000	
T.O. LEVEL 34 SLAB	
T.0. LEVEL 33 SLAB	
P EL 199.000	
EL 196.000	
FI 100.000	
T.0 LEVEL 29 SLAB	
T.O. LEVEL 28 SLAB	
EL 181.000	
EL 178.000	
FL 175.000	
T.0. LEVEL 24 SLAB	
T.O. LEVEL 23 SLAB	
T.O. LEVEL 22 SLAB	
EL 166.000	
EL 163.000	
FL 160.000	
T.0. LEVEL 19 SLAB	
T.0. LEVEL 18 SLAB	
T.O. LEVEL 17 SLAB	
2 EL 148.000	
EL 145.000	
T.O. LEVEL 13 SLAB	
T.0. LEVEL 12 SLAB	
T.O. LEVEL 11 SLAB	
EL 133.000	
EL 130.000	
EL 127.000	
T.0. LEVEL 08 SLAB	
T.O. LEVEL 07 SLAB	
EL 121.000	
T.O. LEVEL 05 SLAB	
EL 115.000	
EL 115.000	
ie 3	
T.0. LEVEL 03 SLAB	
T.0. LEVEL 02 SLAB	
T.0. LEVEL 01 SLAB	

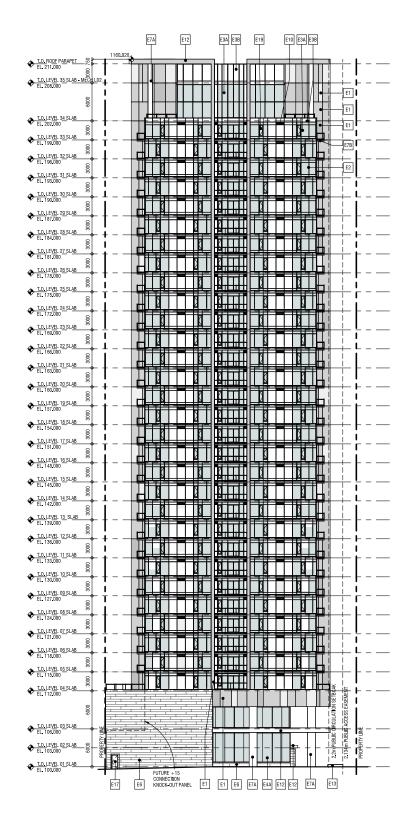

Ele	evation - General Notes
1.	ALL ALUMINUM SOFFT, EAVES & RAINWATER LEADERS 1

2. ALL PRE FINISHED METAL FLASHING TO MATCH ADJACEN

Eleva	tion - Material Legend
E1	COMPOSITE PANELS - COLOUR: THREE TONES OF GR NUMBERS BELOW
E2	PRE-FINISHED ALUMINUM WINDOW SYSTEM - COLOU
E3A	ALUMINUM WINDOW WALL - GLAZING: TINTED
E3B	ALUMINUM WINDOW WALL - SPANDREL: WHITE
E4A	ALUMINUM CURTAIN WALL - GLAZING: CLEAR
E5	PRE-FINISHED ALUMINUM RAILING C/W GLASS INFILI
6	FIBRE-REINFORCED CEMENTITIOUS PANELS - (400M/ COLOUR: MEDIUM GREY
E7A	SACK-RUBBED CONCRETE
E7B	CONCRETE BALCONY
E8	PRE-FINISHED METAL CLADDING
E10	PRE-FINISHED LOUVER - COLOUR; ANODIZED
E12	PRE-FINISHED METAL CANOPY - COLOUR: ANODIZED
E13	BENCH - REFER TO LANDSCAPE


E16 OVERHEAD DOOR - PARKADE E17 DOOR - TYPE 03 - PRE-FINISHED STEEL DOOR E18 DOOR - TYPE 04 - ALUMINUM W. CLEAR GLAZING

E19 PRE-FINISHED LOUVER - COLOUR; ANODIZED E20 PRE FINISHED METAL CANPOY COLOUR: ANODIZE

E22 BENCH - REFER TO LANDSCAPE E23 CHAINLINK FENCE 1800 HIGH REFER TO DETAIL 7/D SIGNAGE. TO BE SUBMITTED AS A SEPARATE DP.

COMPOSITE PANELS - COLOUR PATTERN PATTERN INDICATED IS SUGGESTIVE. FINAL PATTERN TO BE COORDINATED WITH SUPPLIER. P1 P2 P3

E24

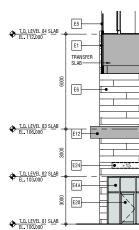

DP4.00 SOUTH Elevation

CPC2021-1414 Attachment 4 ISC: UNRESTRICTED CPC2021-1569 - Attachment 1 **ISC: UNRESTRICTED**



3 + 15 Entrance DP4.00 SCALE: 1 : 100

CPC2021-1569 Attachment 1

CPC2021-1414 **ATTACHMENT 4**

Be grey Frinish		
	1	
		N
REY, SEE PATTERN		BUILDING ELEVATIONS - S & W
ON. ANODIZED		0 1 0
		SNO
L PANEL		/ATI
IM X 3000MM) -		ΓĒ
		Б
		NIQ
		BUIL
)		
)		
P6.01		
		С
		U U
		This draw drawings.
		Verify all discrepan are taken face of str walls, uni
		face of st walls, un
		All drawin drawings may not b
Ek′		REVISIO
		D. D [−]
		0000
		SCALE DATE DRAWN
		CHECKE
		DRAW

3 2 T 6 W	soff so in the set of	
BUILDING ELEVATIONS - S & W	4th Avenue Tower #526 4th avenue SW, Calgary, AB, Lot 33, Block 1, Plan 0914296 Lacaille	
СС	NOT FOR	
drawings. Verify all dime discrepancies are taken to fa face of stud fo walls, unless r	supercodes previous issues. Do not scale these monon, elevations and datums, and report any to the Anthese prior to construction. Demonstruc- tion of elevators heating, loss of controls block, interior particines, and centreline of demining rode of themas is not indicating the datums and the property of the Architect, These dargopping 12020. Scharbecture, These drawing produced without the permission of the Architect.	
	DATE SUBMISSION 09.18.2022 01.27.2021	ecture.o
SCALE DATE DRAWN BY CHECKED E	As indicated 10/12/2021 10:20:25 AM AG Y JC	1182-A-Base_d ramir
DRAWING	DP4.00	C:\Revit Projects/219

2

Page 18 of 31



1 S& W ELEVATIONS - COLOURED


CPC2021-1414 Attachment 4 ISC: UNRESTRICTED CPC2021-1569 - Attachment 1 ISC: UNRESTRICTED


CPC2021-1569 Attachment 1

CPC2021-1414 ATTACHMENT 4

as cc Tr w		
BUILDING ELEVATIONS - COLOURED - S & W	4th Avenue Tower #526 4TH AVENUE SW, CALGARY, AB, LOT 33, BLOCK 1, PLAN 0914296 LACAILLE	
This drawing in drawings. Very all drine disceptiones are baken to fa walls, unless it drawings are in may not be rel REVISION SCALE DATE DRAWN BY	NOT FOR DNSTRUCTION uperceds previous Bases. Do not scale these resides, selvedons and datums, and report any to the Architecture of the Architecture residence without the premission of the Architecture Data of the Architecture previous data of the Architecture Data of t	sRevit Projects 2/19162.M5ase_d.tarritecorbo@s2archtlecture.com.M
CHECKED B		C:\Revit Projects\219182-

Page 19 of 31

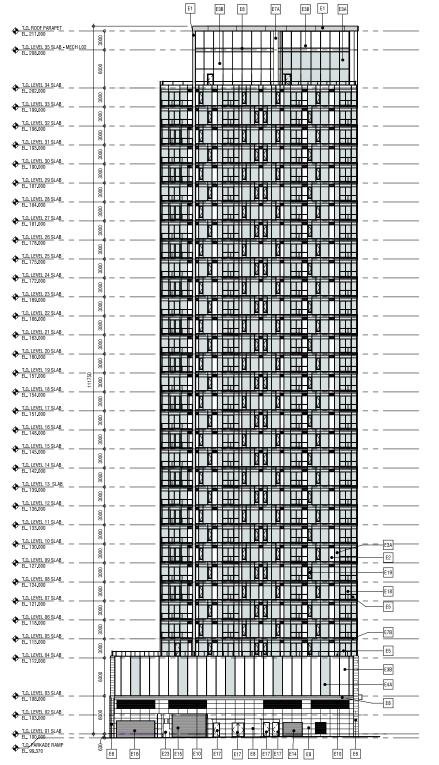

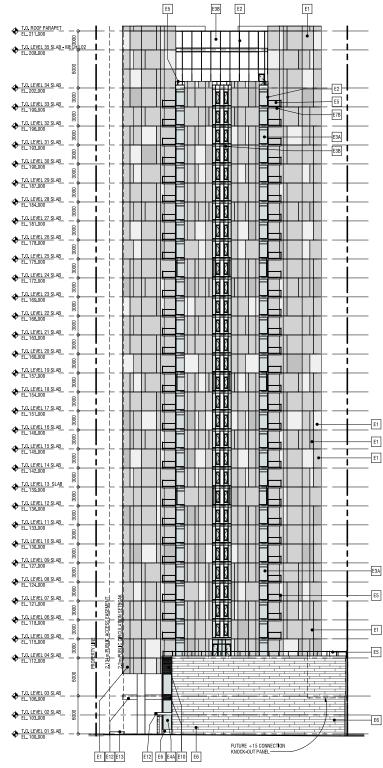

Elevation - General Notes

ALL ALUMINUM SOFFT, EAVES & RAINWATER LEADERS TO BE GREY

2. ALL PRE-FINISHED METAL FLASHING TO MATCH ADJACENT FINISH

Elevation - Material Legend

E1	COMPOSITE PANELS - COLOUR: THREE TONES OF G NUMBERS BELOW.
E2	PRE-FINISHED ALUMINUM WINDOW SYSTEM - COLO
E3A	ALUMINUM WINDOW WALL - GLAZING: TINTED
E3B	ALUMINUM WINDOW WALL - SPANDREL: WHITE
E4A	ALUMINUM CURTAIN WALL - GLAZING: CLEAR
E5	PRE-FINISHED ALUMINUM RAILING C/W GLASS INFI
6	HBRE-REINFORCED CEMENTITIOUS PANELS - (400M COLOUR: MEDIUM GREY
E7A	SACK-RUBBED CONCRETE
E7B	CONCRETE BALCONY
E8	PRE-FINISHED METAL CLADDING
E10	PRE-FINISHED LOUVER - COLOUR; ANODIZED
E12	PRE-FINISHED METAL CANOPY - COLOUR: ANODIZE
E13	BENCH - REFER TO LANDSCAPE
E16	OVERHEAD DOOR - PARKADE
E17	DOOR - TYPE 03 - PRE-FINISHED STEEL DOOR
E18	DOOR - TYPE 04 - ALUMINUM W. CLEAR GLAZING
E19	PRE-FINISHED LOUVER - COLOUR; ANODIZED
E20	PRE-FINISHED METAL CANPOY - COLOUR: ANODIZE
E22	BENCH - REFER TO LANDSCAPE
E23	CHAINLINK FENCE 1800 HIGH REFER TO DETAIL 7/D
E24	SIGNAGE. TO BE SUBMITTED AS A SEPARATE DP.
PATTER	SITE PANELS - COLOUR PATTERN N Noicated is suggestive. Final pattern to be Nated with supplier.
	1

COORDINATED WITH SUPPLIER.	
P1	
P2	
P3	







CPC2021-1569 Attachment 1

CPC2021-1414 ATTACHMENT 4

3 0 1 1 6 0		2 . 1 u. c. teres 500 m	68 244	
BUILDING ELEVATIONS - N & E	4th Avenue Tower	#526 4TH AVENUE SW, CALGARY, AB, LOT 33, BLOCK 1, PLAN 0914296		
	NOT F NSTRU		DN	
drawings. Verify all dime discrepancies are taken to fa face of stud fo walls, unless r	supercedes previous i resions, elevations an to the Architect prior ce of exterior sheathin interior partitions, an roted otherwise on th amain the property of Dopyright 2020, S2 A produced without the	d datums, and n to construction ng, face of cono nd centreline of e drawing.	eport any Dimensions rete block, demising	Ŧ
	UBMISSION		DATE 19.18.2020 11.27.2021	Revit Projects/219182-A-Base_d ramirezcorbo@s2architecture com rvt
SCALE DATE DRAWN BY CHECKED B	Y JC	10:20:50 AM		19182 A Base d ramir
DRAWING N		P4.	01	:\Revit Projects/21

Page 20 of 31

'o be grey Nt finish

GREY. SEE PATTERN


FILL PANEL OMM X 3000MM) -

ΈD

ΈD

DP6.01

E

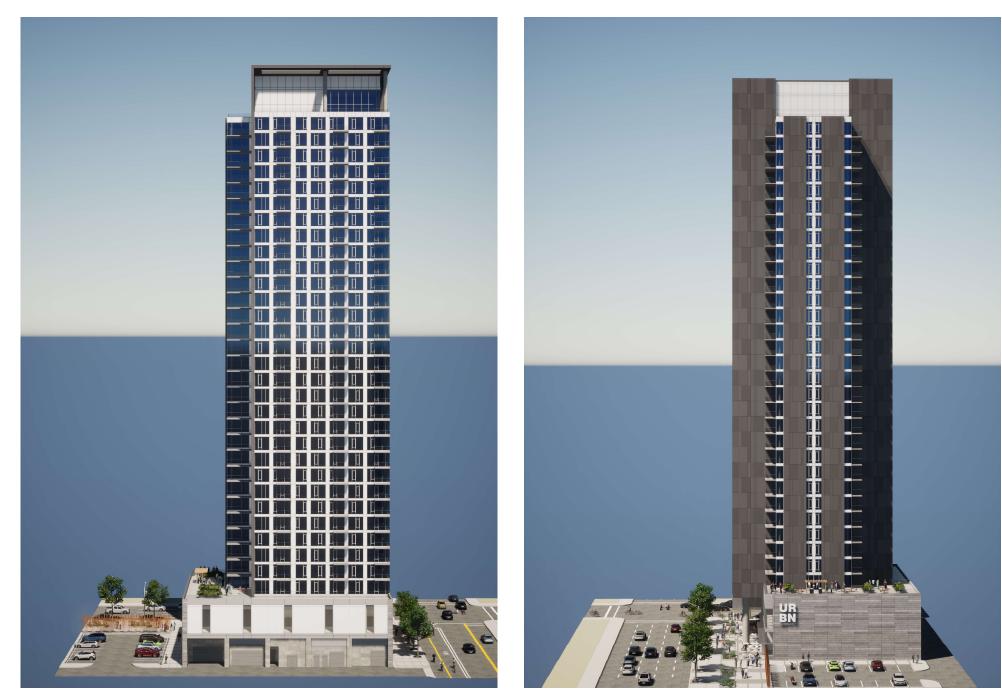

1 N & E ELEVATIONS - COLOURED

CPC2021-1414 Attachment 4 ISC: UNRESTRICTED CPC2021-1569 - Attachment 1 ISC: UNRESTRICTED

CPC2021-1569 Attachment 1

CPC2021-1414 ATTACHMENT 4


Bacco Here Charles Bacco				
BUILDING ELEVATIONS - COLOURED - N & E	4th Avenue Tower	#526 4TH AVENUE SW, CALGARY, AB, LOT 33, BLOCK 1, PLAN 0914296 LACAILLE		
This drawing s drawings. Verify all dime discrepancies are taken to fa face of stud fo walls, unless r	upercedes previous is nsions, elevations and to the Architect prior 1 co of exterior sheathin r interior partitions, an toted otherwise on the	COR JCTION source, Do not scale these i datame, and report any construction. Domensions g, new of construction. Domension g, new of construction. Domension g, new of construction. These constructions of the Architect		
REVISION SCALE DATE DATE DRAWN BY CHECKED B DRAWING M	10.	020.52 AM	Projects/219182-A-Base_d ramirezcorbo@s2architecture.com v4	

Page 21 of 31



CPC2021-1569 - Attachment 1 **ISC: UNRESTRICTED**

CPC2021-1569 Attachment 1

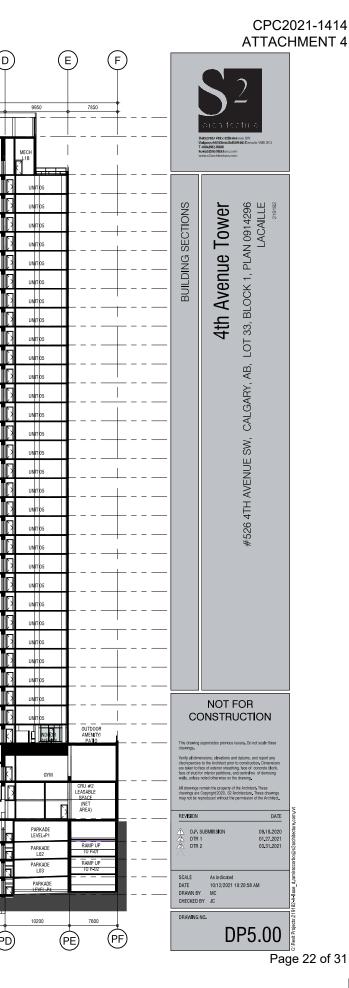

 \bigcirc

38870

8870


CHILLERS


8870

PD

PC

Page 43 of 54

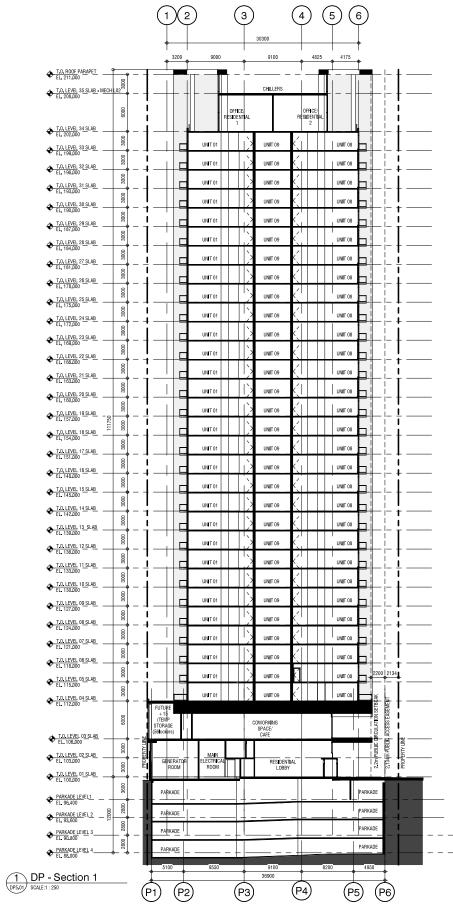

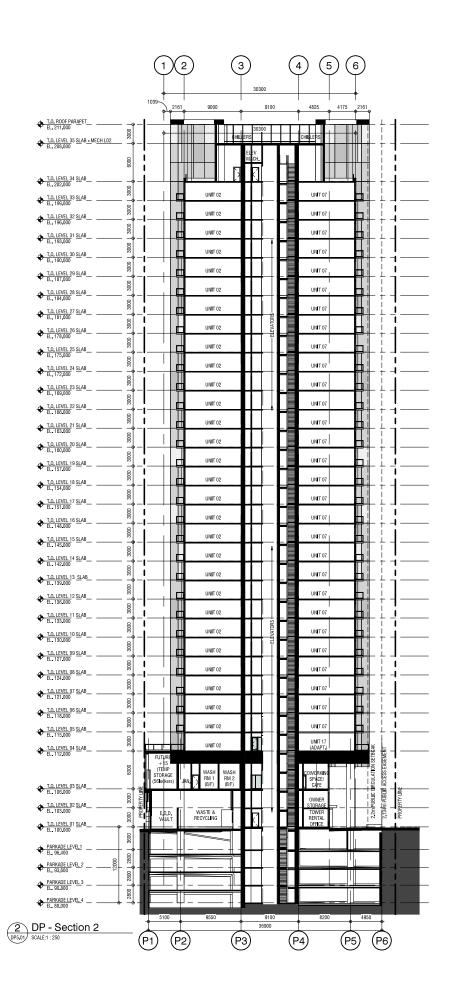


CPC2021-1569 Attachment 1

CPC2021-1414 ATTACHMENT 4

Date of the second seco		
BUILDING SECTIONS	4111 AVEIIUE 10WEI #526 4TH AVENUE SW, CALGARY, AB, LOT 33, BLOCK 1, PLAN 0914296 LACAILLE	
	DT FOR TRUCTION	
drawings. Venty all dimensions, eleva discrepancies to the Anchi are taken to face of exterior face of stud for interior pan walls, unless noted otherw All drawings remain the pro- drawings are Copyright 207 may not be reproduced with	previous issues. Do not scale these atom provide the second second second second raineating, face of contents block more, and centifiery of demissing are on the drawing. 20, 52 Architecture, These 20, 52 Architecture, These 20, 52 Architecture, These and the permission of the Architect	¥
REVISION 1 D.P. SUBMISSIO 2 DTR 1	01.27.2021	C: Neut Projects 2/19182-4-8ae _ draminescerbiogradaenhieture.com.or
DRAWN BY AG CHECKED BY JC	0 v2021 10:21:05 AM	19182-A-Base_d.a
DRAWING NO.	DP5.01	C:)Revit Projects (21

Page 44 of 54

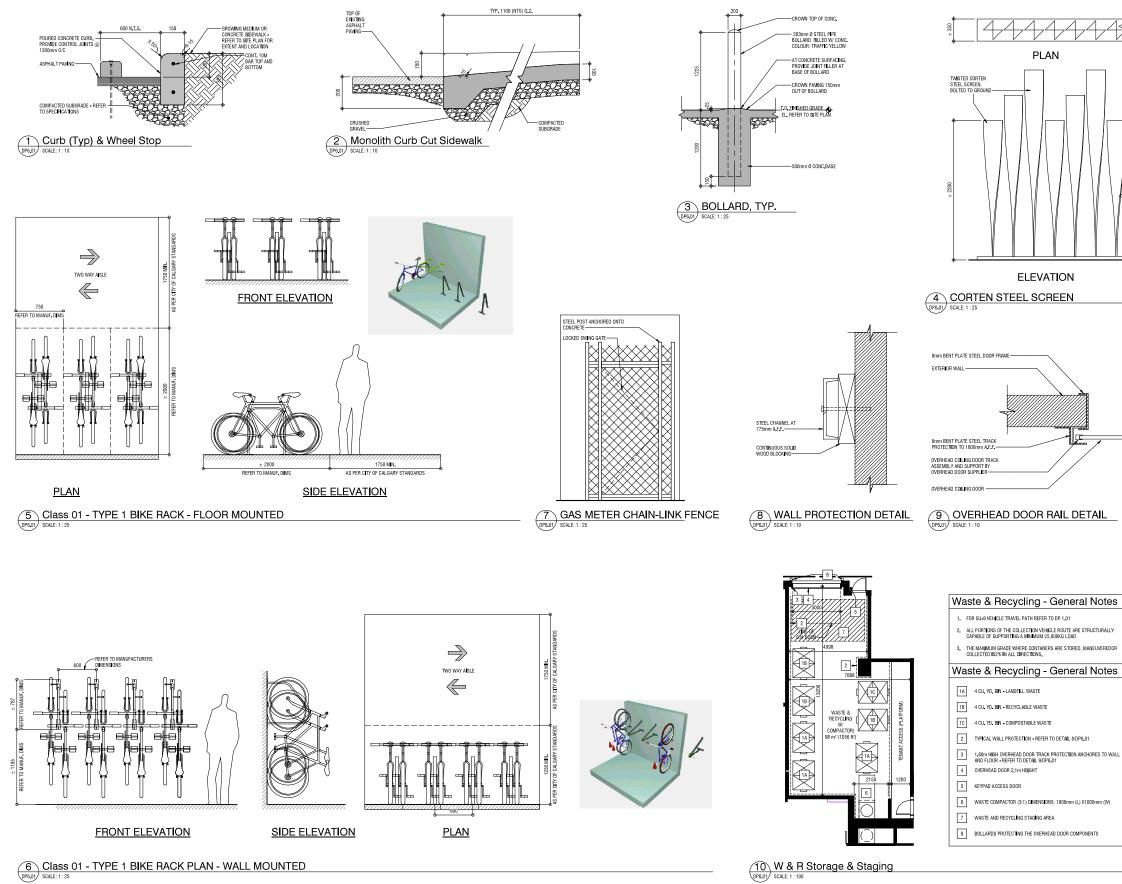

6 Class 01 - TYPE 1 BIKE RACK PLAN - WALL MOUNTED


CPC2021-1414 Attachment 4 ISC: UNRESTRICTED CPC2021-1569 - Attachment 1 **ISC: UNRESTRICTED**

Page 45 of 54



DATE

09.18.2020 01.27.2021 03.31.2021

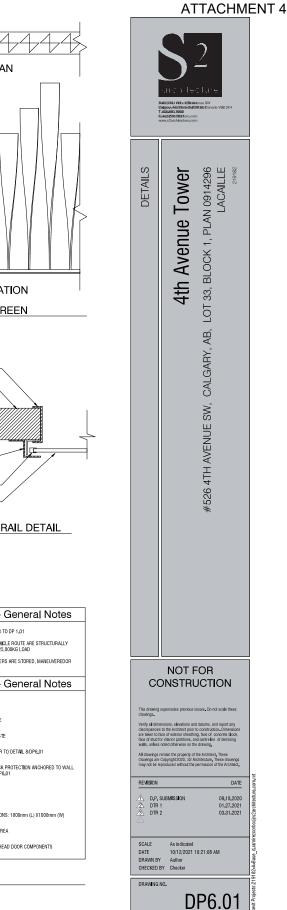

CPC2021-1569 Attachment 1 CPC2021-1414

OUTLINE NOTES AREA WHERE MECHANICAL EQUIPMENT MAY BE RELAXED WITHIN A PARKING STALL

PARKING STALL PLAN VIEW

OUTLINE NOTES AREA WHERE MECHANICAL EQUIPMENT MAY I Relaxed within a parking st

PARKING STALL CROSS SECTION

T.0. LEVEL 02 SLAB EL. 103.000

T.0. LEVEL 01 SLAB EL. 100.000

PARKADE LEVEL1 -

PLAZA SECTION SCALE: 1 : 100

PARKADE WALL

1 ENCROACHMENT DETAIL DP6.02 SCALE: 1 : 100

SERVICE LINE SUCH AS SANITARY AND/OR STORM LINE ALONG PARKADE WALL

0.15m/ MA

MXX

DRIVE AISLE

0,3m/ 1-0- MIN - SERVICE LINE SUCH AS SANTARY AND/OR STORM LINE ALONG PARKADE WALL

-0.3m/ 1'-0" MAX

UNIT HEATER OR OTHER MECHANICAL Equipment

Min. Stall depth as per the Land Use Bylaw

4150

-BENCH 8 BEYOND €

MIN. STALL

4950

P5

540

1560

P6

(6)

(P6)

2143

PL TO GRID F 2134

± 2961 To BOC

5 1219

2.6m MI 8-8" MP DETAILS OUTLINE THE ALLOWANCE FOR MECHANICAL SERVICES WITHIN PARKING STALLS FOR MULTF-ANILY REBIENTIAL PARKADE'S ONLY, DOES NOT APPLY TO COMMERCIAL OR MIXED USE PARKADE'S. THIS MECHANICAL CONTRACTOR COORDINATE WITH THE GENERAL CONTRACTOR AND ARCHITECT TO ENSURE AL MECHANICAL SYSTEMS ARE INSTALLED TO CONFLY WIT

()

4175

PARKADE LEVEL-P1

PARKADE LEVEL-P2 DRIVE AISLE

(5)

CPC2021-1569 Attachment 1 CPC2021-1414 ATTACHMENT 4

BOARD CONTRACTOR					
SITE DETAILS	4th Avenue Tower	#526 4TH AVENUE SW, CALGARY, AB, LOT 33, BLOCK 1, PLAN 0914296 LACAILLE			
СС	NOT F NSTRU	FOR JCTION			
This drawing supercedes previous issues. Do not scale these characteristics and the second s					
🖄 DTR 1	REVISION DATE A. D.P., SUBMISSION 09, 18,2001 A. DTR 1 01,27,2021 A. DTR 2 03,31,2021				
SCALE DATE DRAWN BY CHECKED B	As indicated 10/12/2021 ⁻ Author Y Checker	10:21:08 AM	Benit Projects: 210182-6.83se of raminaryorkhor@e2architecture com ref		
DRAWING		P6.02	C./Ravit Projecte/21		

_____12'-6" _____

REMO

- HOT WATER FAUCET CONNECTION

(P1)

SLOPE TO LANE CENTRE

2%

P1

WALL BUMPERS

SIDE VIEW

3'-0 1/2" -

- - - -

2'-6 1/2

- 3'-2 1/2" -

WASTEQUIP: C-33X-APT APARTMENT COMPACTOR

3 COMPACTOR DP6.02 SCALE:NTS

+ T.O. LEVEL 02 SLAB

+ T.O. LEVEL 01 SLAB

DRIVE AISLE

(2)

0

D00

-INTERLOCK SWITC

2 CY COM

(1)

SLOPE 8%

- 600 CLEAR TO O.H. DOOR

99.220

P2

900

SLOPE 2%


TRENCH DRAIN-

5 PARKADE TRENCH DRAIN 2

4 PARKADE TRENCH DRAIN 1 DR602 SCALE: 1:50

DRA

PLAN VIEW

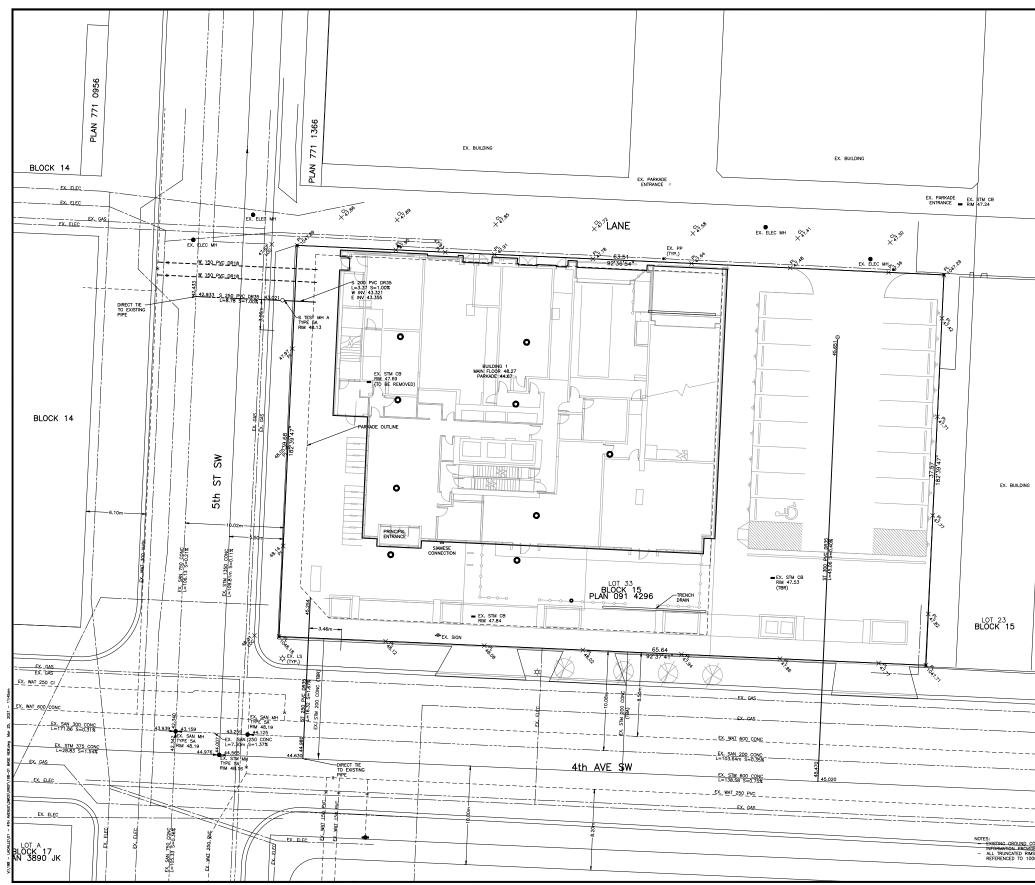


CPC2021-1569 Attachment 1

CPC2021-1414 ATTACHMENT 4

				NG UTILI S S <th>ANITARY SEWER TORM SEWER ATER LINE ENCE ENCE MPE 5A MANHOLE ATCH BASIN YDRANT ATER VALVE /G ELECTRICAL AS INTES NUTARY SEWER TORM SEWER</th> <th>: : : : : : : : : : : : : : : : : : :</th> <th></th>	ANITARY SEWER TORM SEWER ATER LINE ENCE ENCE MPE 5A MANHOLE ATCH BASIN YDRANT ATER VALVE /G ELECTRICAL AS INTES NUTARY SEWER TORM SEWER	: : : : : : : : : : : : : : : : : : :	
			REVISIO N0. yyhtmiday 1 21/03/81 2 - 3 - 4 -		CRIPTION DTR #2 - - - -	BY TVS - -	APPD TVS
	EX. PUIS 15 WALKWAY		1 FOR D	DESCRIF P PPROVAL			TE 1911(53)
BLOCK 15			PROJEC JOB DESCRIP LOT: 33 DP#: ADDRESS:	етіон LA вік: 1 -	CAILLE	091 4296 - IRY	
			LEGAL DESCR TITLE PRE		ERVICINO		7
			SCALE: DWN: DES: DATE: CHK: P, ENG: PERMIT:	1:150 TC TVS AUG 7-20 TVS TVS	STAMP:		
INTOURS BASED ON SURVEY ED BY TRONNES DATED 1000. 5. INVERTS AND ELEVATION 0.00m IN ELEVATION		EX WAT 200 PVC	PROJECT No. 198-0 DRAWING NAM 198-	1	Strieger 1 Destricor All Pedia All Pedia	of 2 75 R	1

Page 26 of 31

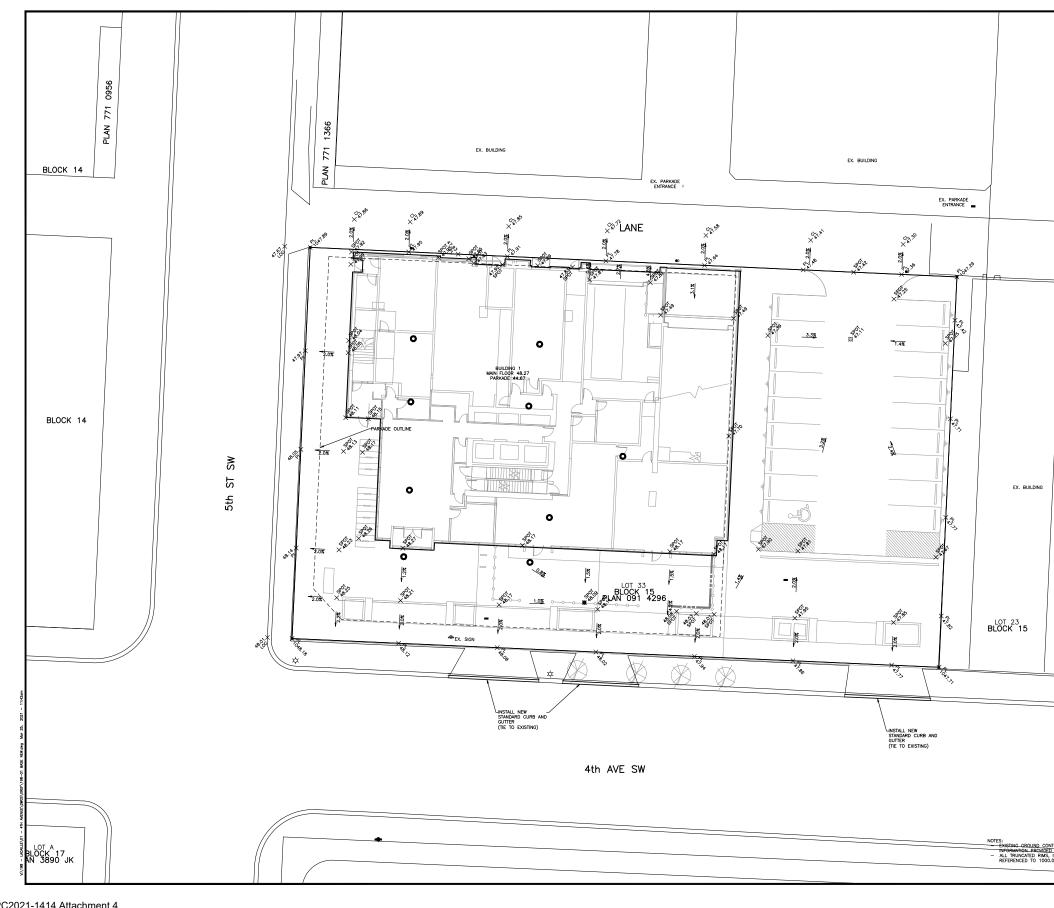


I

CPC2021-1414 ATTACHMENT 4

			IG FEATURES → PR0POSED CO PR0POSED CA PR0POSED CA PR0POSED AS PR0POSED CA PR0POSED AS PR0POSED CA → PR0POSED CA <	NCRETE SWALE TCH BASIN NHOLE //MAHOLE PHALT PAVING NCRETE TANING WALL ASS SWALE AANLINK FENCE IST & CABLE REEN FENCE ISHED GRADE	NCE
	EX. PLUS 15 WALKNAWY	REVISIO NGL yutmutay 1 2103391 2 3 4 - 5 - VBUMISa - 1 FOR DP 2 FOR AP 3 FOR AP 2 FOR AP 3 FOR AP 2 FOR AP 3 FOR AP	DESCRIPTION I SIONS DESCRIPTION PROVAL CHIVE	ВҮ ТVS - - - - - - - - - - - - - - - - - - -	APPD TVS
BLOCK 15		JOB DESCRIP LOT: 33 DP#: ADDRESS: LEGAL DESCRI TITLE PRI	LACAILL BLK: 15 PLAN: - DSSP: 4 AVE SW CA	091 4296 - ILGARY 	
		SCALE: DWN: DES: DATE: A CHK: P. ENG: PERMIT:	1:150 STAMP TC UG 7-20 TVS TVS		
ONTOURS BASED ON SURVEY ED BY TRONNES DATED 1000 S, INVERTS AND ELEVATIONS O 0.00m IN ELEVATION	.00 SEODETIC	PROJECT No. 198-01 drawing name 198-		OF 2 STROY LPRINTS LOR TO R	1

Page 48 of 54

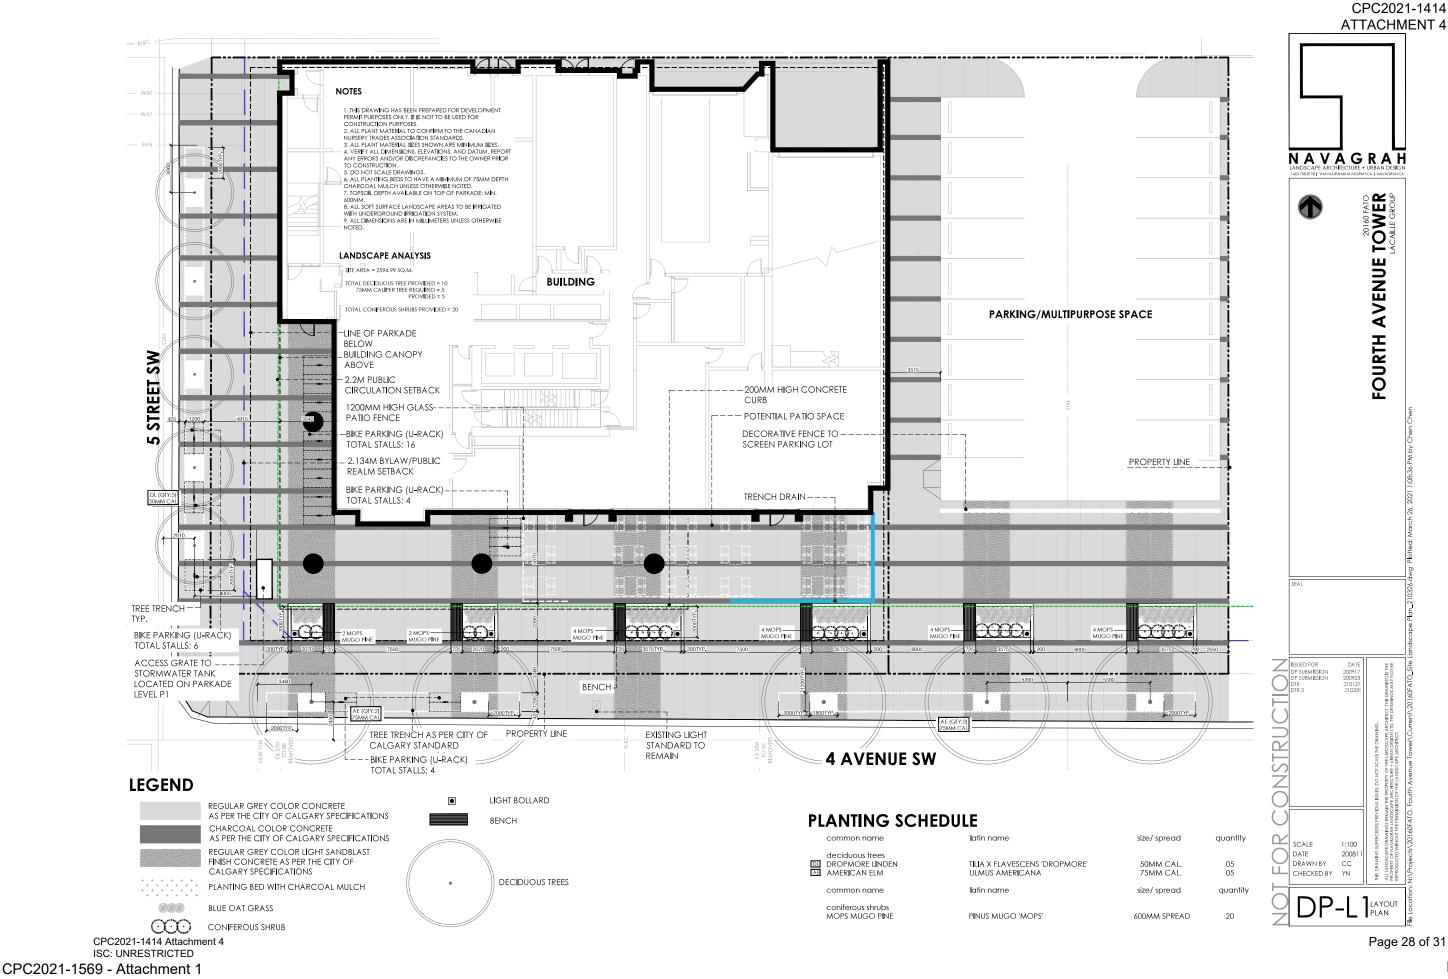



ISC: UNRESTRICTED

CPC2021-1569 Attachment 1




(ALONG 4TH AVENUE SW AND 5TH STREET SW BACK OF CURB)

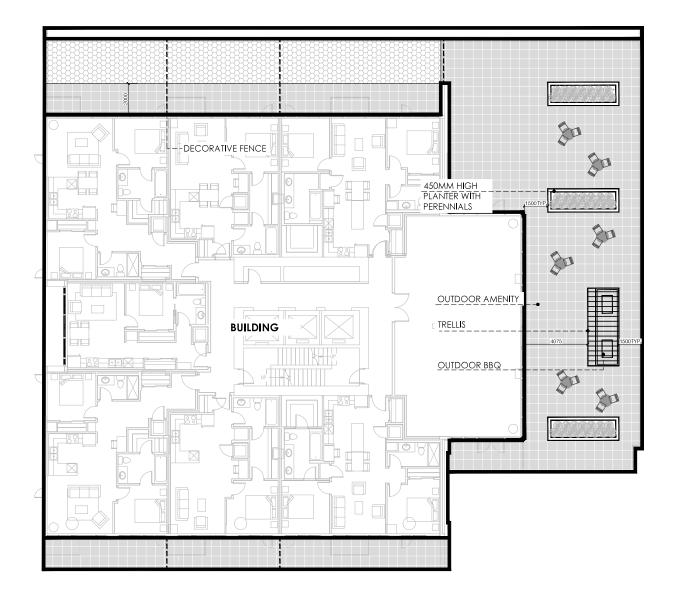

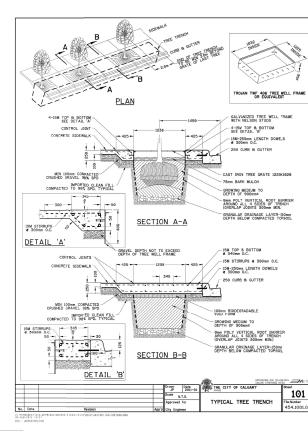

BIKE RACK

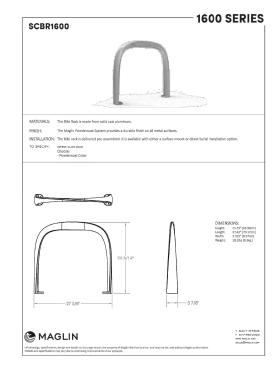

LEGEND



PERENNIALS



NOTES

 1. THE DRAWING HAS BEEN PREPARED FOR DEVELOPMENT PERMIT PURPOSES ONLY. IT IS NOT TO BE USED FOR CONSTRUCTION PREPOSES.
 2. ALL PLANT MATERIAL TO CONFIRM TO THE CANADIAN NURSEY TRADES ASSOCIATION STANDARDS.
 3. ALL PLANT MATERIAL ISES SHOWN ARE MINIMUM SIZES.
 4. VERPY ALL DIMENSIONS, ELEVATIONS, AND DATUM. REPORT TAYLY ERRORS AND/OR DISCHERANCES TO THE OWNER PRIOR TO CONSTRUCTION.
 6. ALL PLANTING BEDS TO HAVE A MINIMUM OF 75MM DEPTH CHARCOAL MUCH UNLESS OTHERWISE NOTED.
 7. TOPSOIL DEPTH AVALABLE ON TOP OF PARKADE: MIN. 800MM.
 8. ALL SOFT SURFACE LANDSCARE AREAS TO BE IRRIGATED WITH UNDERGOUND IRROATION STEM.
 9. ALL DIMENSIONS ARE IN MILLIMETERS UNLESS OTHERWISE NOTED.

CPC2021-1414 Attachment 4 ISC: UNRESTRICTED CPC2021-1569 - Attachment 1 ISC: UNRESTRICTED


Page	50	of	54

Page 29 of 31

CPC2021-1569 Attachment 1

CPC2021-1414

SEAL SEAL DP SUBMISSION 200917 DP SUBMISSION 200923 DIR 2 210231 DIR 2 210331	
	THE DRAWING SUPECEDES PRENDUS RULES. DO NOT SCALE THE DRAWING. NULLARDSCAFE DRAWINGS RELARDS FORTER OF THE LANDSCAFE ARCHITECT THE DRAWING IN THE ALL LARDSCAFE DRAWINGS RELARDS FOR THE LANDSCAFE ARCHITECT IN THE DRAWINGS INAT NOT RE REPROJUCED WITHOUT THE PREVIEWS FOR THE LANDSCAFE ARCHITECT IN.

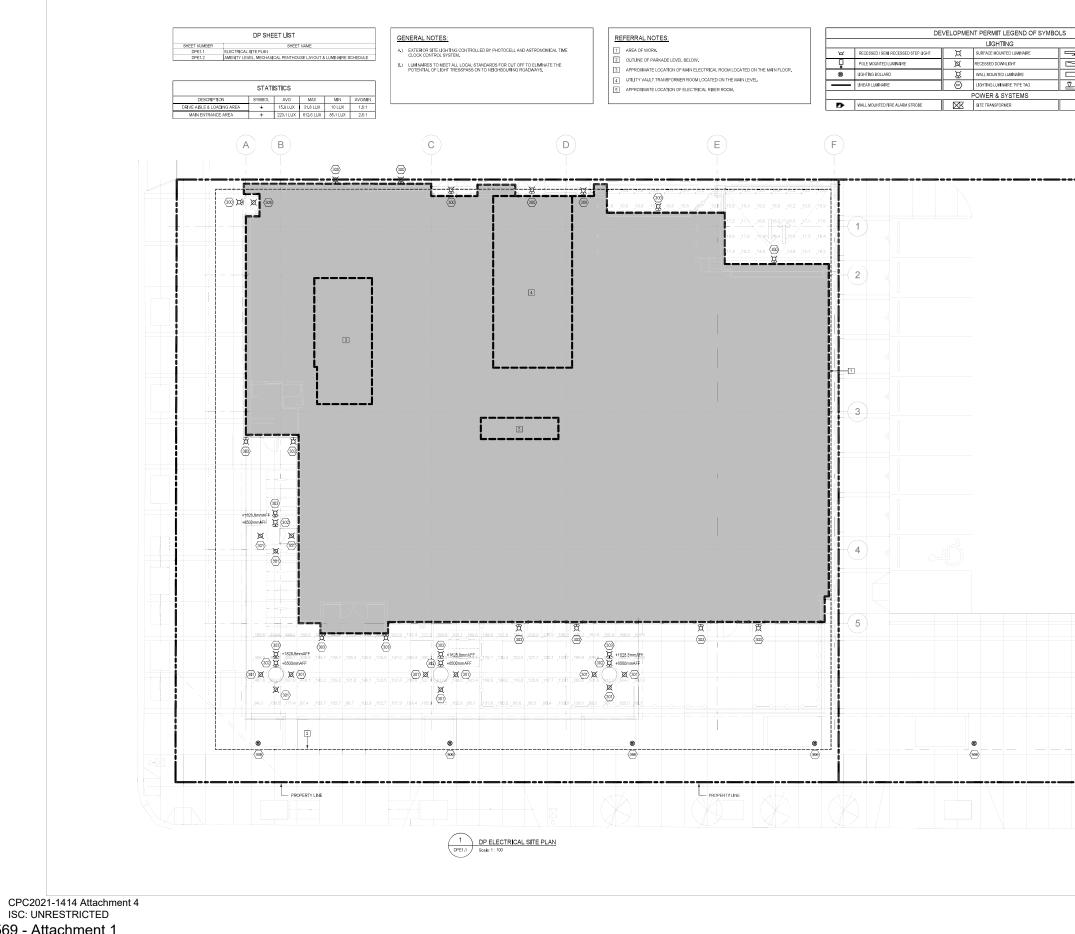


CPC2021-1569 - Attachment 1 ISC: UNRESTRICTED CPC2021-1569 Attachment 1

CPC2021-1414 ATTACHMENT 4

VV2 W4LL WOUHTED LINEAR LUMINARE RECESSED LINEAR LUMINARE SURFACE WOUNTED LINEAR LUMINARE FRACK LIGHTING HEAKLS AS SHOWN	Side of the Alexandron		
	ELECTRICAL SITE PLAN HTH AVENUE TOWER Sth STREET & 4th AEVENUE SW, LACAILLE 2008		
	NOT FOR CONSTRUCTION Market State And Annual State An		

Page 30 of 31

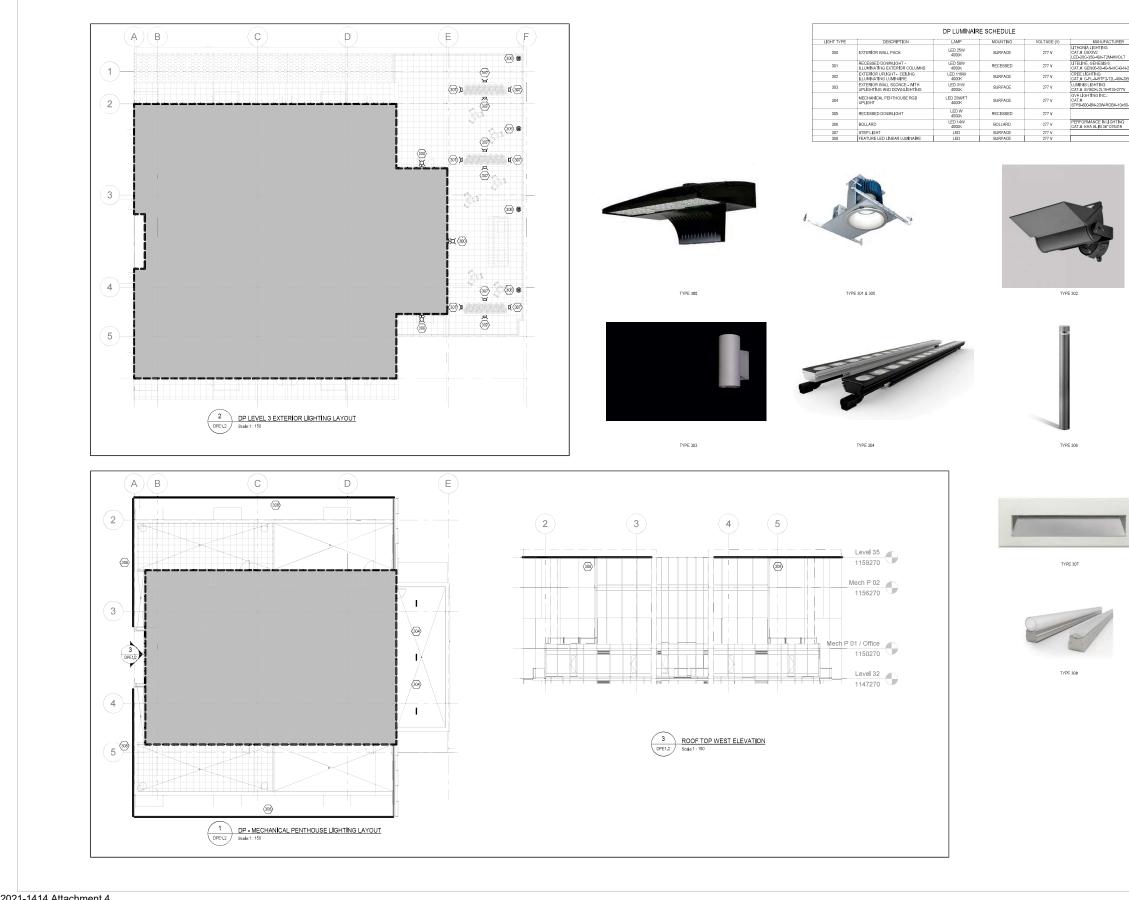

CPC2021-1569 Attachment 1

CPC2021-1414 **ATTACHMENT 4**

277 V 277 V 277 V 277 V 277 V 277 V 277 V 277 V	CAT #1 65/02 IEE.202-38-04-1784AV/01.1 IEE.202-38-04-1784AV/01.7 IEE.202-38-04-1784AV/01.7 IEE.202-38-04-178-02 CAT # 100-21.3 IEE.202-38-04-29-178 CAT # 100-21.3 IEE.202-38-04-29-178 IEE.202-38-04-29-178-02 IEE.202-38-04-29-178-02 IEE.202-38-04-29-18-02 IEE.202-38-04-29-18-02 IEE.202-38-04-20-18-02 IEE.202-38-04-29-18-02 IEE.202-38-04-29-18-02 IEE.202-38-04-29-04-29-04-29-04-29-04-29-04-29-04-29-04-29-04-29-04-29-04-29-04-29-04-29-04-29-04-29-04-29-04-29-04-29-04-29-04-29-04-29-04-29-04-29-04-29-04-29-04-29-04-29-04-29-04-29-04-29-04-29-04-29-04-29-04-29-04-29-04-29-04-29-04-29-04-29-04-29-04-29-04-29-04-29-04-29-04-29-04-29-04-29-04-29-04-29-04-29-04-29-04-29-04-29-04-29-04-29-04-29-04-29-04-29-04-29-04-29-04-29-04-29-04-2		crst rc ide 900, 110-12%. Vidgay, AB, Canada 403,670,7000
TY	F 302 F 302 F 302 F 303	AMENITY LEVEL, MECHANICAL PENTHOUSE LAYOUT & LUMINAIRE SCHEDULE	4th Avenue Tower
	74 JOA	This drawing drawings, Verity all dime discrepancies are taken to fa face of stud fo walls, unless	NOT DNSTR supercedes previous is to the Architect price to the Architect price is of edefinition partitions, noted offenvives on exemain the property of Capyright SS 2
		REVISION S	ED FOR DP
		SCALE DATE DRAWN BY CHECKED E	

7 5th STREET & 4th AEVENUE SW, LACAILLE FOR RUCTION of the Architect. These Architecture, These drawings re permission of the Architect DATE 2020-09-17 2021-01-27 2021-03-31 CHECKED BY NM DRAWING NO. **DPE1.2**

Page 31 of 31

CPC2021-1569 Attachment 1

Applicant Submission

September 16, 2020

The City of Calgary 3rd Floor, Municipal Building, 800 Macleod Tr. S.E. Calgary, AB Canada T2P 2M5

Re: 4th Ave Tower – S2 Project #219182 Planning Analysis

To whom it may concern:

The La Caille Group is proposing the development of a single phase, mixed-used building located at the junction of 4th Avenue SW and 5th Street SW. This 32-storey mixed-use project, 4th Ave Tower, incorporates a two-storey podium containing the residential lobby and retail at grade, along with future connectivity to the plus fifteen network. Large indoor amenity space for residents is provided at second floor level and indoor-outdoor access for residents is provided at the third podium level. This project will provide a high-density Transit Oriented Development supported by existing infrastructure, public transportation, while meeting all the primary objectives of the City Centre Plan, and the policies and guidelines set out in the Municipal Development Plan.

4th Ave Tower is zoned as Commercial Residential District (CR20-C20/R20) with a site area of 0.46 acres and exists in a transit-oriented development area with access to the CTrain Free Fare Zone and a multitude of bus routes. The project is seeking incentive density (3 FAR + an additional 12 FAR) by providing public amenity items including public circulation space at grade in the form of a south-facing plaza, and allocated area for future +15 Skywalk System. The project's cumulative gross floor area is approximately 25,455 sm, using approximately 14.84 of the 15 FAR.

The project is located at the interface between the commercial bustle of downtown and the residential nature of Eau Claire to the north. A generous plaza space with trees, seating and canopies is located on the building's southside along 4th Ave SW. The landscape design creates a pronounced street edge along 4th Ave and enhances the pedestrian connection to the LRT station to the west and city to the east. In keeping with the adjacent streetscape, the proposed urban realm contains a mix of hard and softscape elements, along with benches and lighting that support the retail frontage while additionally promoting pedestrian traffic.

The architectural massing takes advantage of the zoning's no-height restriction, without casting shadow in the nearby sun protection areas and opts for a smaller, efficient tower plate which is considerably smaller than the zoning's allowable max floor plate area. The tower itself overhangs the podium which creates a covered plaza and defines the two-storey residential lobby. This entrance is located on the south west corner of the site, activating the public realm and the intersection.

The tower has a total of 268 residential rental units which will significantly increase the community's density. The living spaces include a range of studio, one bedroom, and two bedrooms units ranging in size from 55sm to 95sm. A portion of the residential units will meet the requirements for accessible and adaptable units. Four levels of below grade parking are provided along with the specified amount of bicycle parking required. The entire building will be accessible and is designed to CPTED standards. In addition, all private areas will contain electronically-controlled access with additional security and concierge service at the ground level for the residences.

The architecture of the proposed development is deliberately simple. Curtain-wall glazing along the podium's southwest provides a strong visual connection from interior to exterior. Self-coloured fibre-reinforced cementitious panels will make up the remainder of the podium's cladding. Highly-articulated metal panels are proposed on the

PRINCIPALS

Robert Spaetgens Architect, AAA ABC. SAA, MRAIC David Symons Architect, AAA, ABC, SAA, OAA, MRAIC, Licensed Architect Californie Linus Murphy Architect, AAA, ABC, SAA, OAA, FRAIC, LEED* AP Brian Corkum Architect, AAA, ABC, OAA, LEED* AP Genevieve Giguere Architect, AAA, MRAIC Peter Streith Architect, AAA, MBC, OAA, NWTAA, FRAIC Robert Lange Architect, ABC, MRAIC, LEED* AP

S2 ARCHITECTURE

CPC2021-1414 Attachment 5 ISC: UNRESTRICTED ASSOCIATE PRINCIPALS

Ken Shaman Intern Architeor, AAA Jason Curtis Architeor, AAA, MRAIC, LEED² AP Charles Gushaty Madeleine Schmidts Interior Designer, NCIDO

Jason Dolha Jane Kratochvil Stephen Jabs Steven Mott Jason Bright Architect, AAA, MA, MRAC Michelle Rowles Architect, AAA, MRAC Shaad Oosman CPA, CMA Natalie Weiss Interior Designer, NCIDO, LEED' AP Pierre Ferronato

ASSOCIATES

CALGARY | EDMONTON | VANCOUVER

Page 1 of 2



CPC2021-1414

Attachment 5

900, 110 - 12 Avenue SW Calgary, AB, T2R 0G7 T, 403,670,7000 s2architecture.com

CPC2021-1569 - Attachment 1 ISC: UNRESTRICTED

CPC2021-1414 Attachment 5

feature east walls to frame the tower and wrap the transfer slab at the third level and will provide a rich patina that will change with suns path each day. Lastly, the tower itself is expressed through considered placement of mullions, glazing panels, operable windows, composite metal panels and balconies.

This mixed-use Transit Oriented Development will maintain and respect the neighbouring context while promoting future design innovation. The retail spaces provide flexibility to variety of potential commercial uses and the increase in density will bring a broad range of uses and users to the Downtown community. Overall, the massing, orientation, durable and long-lasting materials will create a safe and comfortable public corridor along 4th Avenue SW.

Should you have any questions or concerns, please do not hesitate to call me directly at 403-670-7050 ext. 1092.

Yours truly, S2 Architecture

Melissa Christenson Intern Architect

S2 ARCHITECTURE 900, 110 – 12 Avenue SW Calgary, AB T2R 0G7 T: 403-670-7000 CPC2021-1414 Attachment 5 ISC: UNRESTRICTED 4th Ave Tower S2 Project # 219182 | Page 2 of 2

Page 2 of 2