


# VARSITY MULTI-SERMICE REDEVELOPMENT | ISSUED FOR DP | AUGUST 13, 2020

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L-02	DETAILS
	DETAILS
L-02	DETAILS
L-02	DETAILS  DP SITE PLAN
L-02  LECTRICAL  DP-E-1.01	DETAILS  DP SITE PLAN
L-02 LECTRICAL DP-E-1.01 DP-E-1.01a	DETAILS  DP SITE PLAN DP SITE NOTES AND DETAILS PHOTOIVETRIC LIGHTING & CALCULATION PLAN
L-02 LECTRICAL DP-E-1.01 DP-E-1.01a DP-E-1.02	DETAILS  DP SITE PLAN  DP SITE PLAN  DP SITE NOTES AND DETAILS  PHOTOMETRIC LIGHTING & CALCULATION PLAN LUMINAIRE SCHEDULE
L-02 LECTRICAL DP-E-1.01 DP-E-1.02 DP-E-1.03	DETAILS  DP SITE PLAN  DP SITE PLAN  DP SITE NOTES AND DETAILS  PHOTOMETRIC LIGHTING & CALCULATION PLAN LUMINAIRE SCHEDULE
L-02 LECTRICAL DP-E-1.01 DP-E-1.02 DP-E-1.03 DP-E-1.04	DETAILS  DP SITE PLAN  DP SITE PLAN  DP SITE NOTES AND DETAILS  PHOTOWETRIC LIGHTING & CALCULATION PLAN LUMINAIRE SCHEDULE  CUTSHEETS 1 OF 6
L-02  DP-E-1.01  DP-E-1.02  DP-E-1.02  DP-E-1.03  DP-E-1.04  DP-E-1.05	DETAILS  DP SITE PLAN  DP SITE NOTES AND DETAILS  PHOTOMETRIC LIGHTING & CALCULATION PLAN LUMINAIRE SCHEDULE  CUTSHEETS 1 OF 6  CUTSHEETS 2 OF 6
L-02  DP-E-1.01  DP-E-1.02  DP-E-1.03  DP-E-1.04  DP-E-1.05  DP-E-1.05	DETAILS  DP SITE PLAN  DP SITE NOTES AND DETAILS  PHOTOWETRIC LIGHTING & CALCULATION PLAN LUMINAIRE SCHEDULE  CUTSHEETS 1 OF 6  CUTSHEETS 2 OF 6  CUTSHEETS 3 OF 6
L-02  DP-E-1.01  DP-E-1.02  DP-E-1.03  DP-E-1.04  DP-E-1.05  DP-E-1.06  DP-E-1.07	DETAILS  DP SITE PLAN  DP SITE NOTES AND DETAILS  PHOTOWETRIC LIGHTING & CALCULATION PLAN LUMINAIRE SCHEDULE  CUTSHEETS 1 OF 6  CUTSHEETS 2 OF 6  CUTSHEETS 3 OF 6  CUTSHEETS 4 OF 6

# TRANSPORTATION T-101 VEHICLE SWEPT PATHS FIRE TRUCK CIRCULATION T-102 VEHICLE SWEPT PATHS WASTE COLLECTION T-103 VEHICLE SWEPT PATHS WOLOK WASTE COLLECTION T-104 VEHICLE SWEPT PATHS CLEANING SERVICE VEHICLE T-105 VEHICLE SWEPT PATHS AVBULANCE WANELWERING T-106 VEHICLE SWEPT PATHS FIRE TRUCK & AVBULANCE WANELWERING



# LOT 1 - PROPOSED VARSITY MULTI-SERVICE REDEVELOPMENT

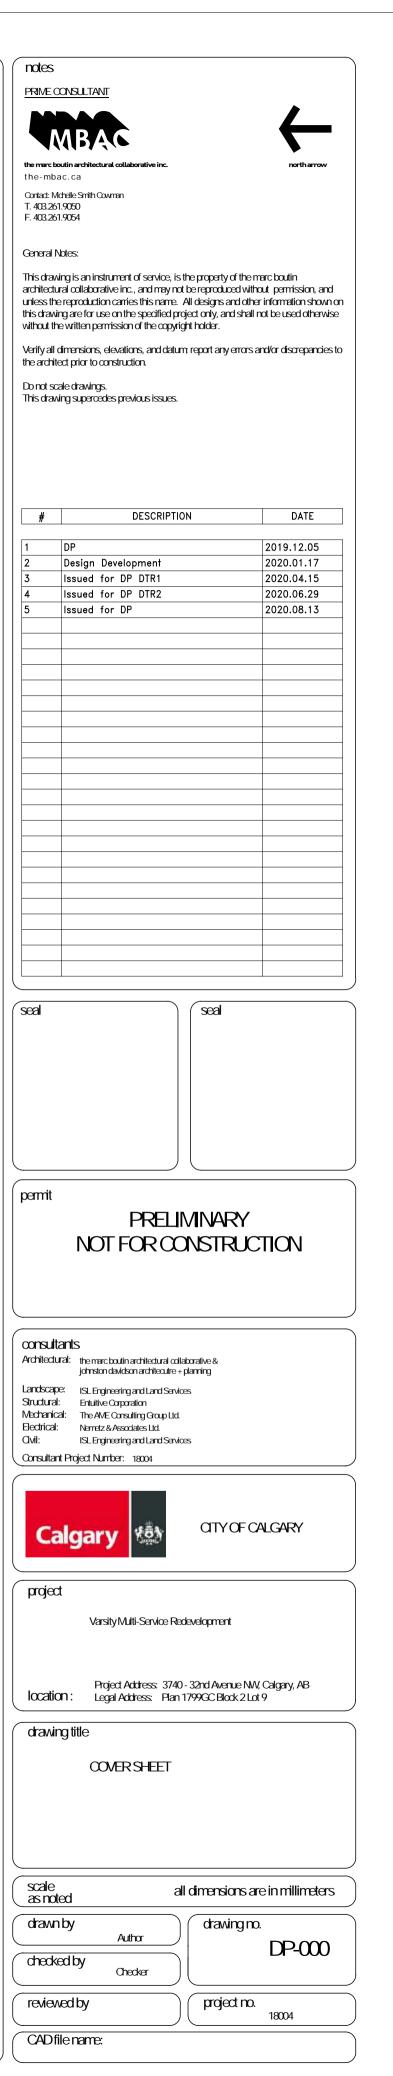1232 m<sup>2</sup>

7444 m<sup>2</sup>

AREA COVERAC	Œ:	DENSITY:		
PROPOSED LOT 1 PARCEL SIZE: BUILDING COVERAGE: HOUSEHOLD HAZARDROUS WAS	8874m² 1412m² STE: 22m²	PROPOSED UNITS (RES PROPOSED UNITS PER I		48 54
COVERED BICYCLE STORAGE: TOTAL LOT 1 PARCEL COVERAG	57m² E: 1,491m²	UPH = Units divided by	Parcel Area	
GROSS FLOOR	AREAS:			
PROPOSED GFA: FLOOR AREA RATIO (FAR):	7444m² 0.839			
FAR = GFA Divided by Parcel Are	a			
LEVEL 1.0 - T.O. MAIN FLOOR	MULTI RESIDENTIA	AL	82 m <sup>2</sup>	
LEVEL 1.0 - T.O. MAIN FLOOR	SHARED		139 m <sup>2</sup>	
LEVEL 1.0 - T.O. MAIN FLOOR	OFFICE		171 m <sup>2</sup>	
LEVEL 1.0 - T.O. MAIN FLOOR	CHILD CARE		19 m <sup>2</sup>	
LEVEL 1.0 - T.O. MAIN FLOOR	MULTI RESIDENTIA	AL	22 m <sup>2</sup>	
LEVEL 1.0 - T.O. MAIN FLOOR	PROTECTIVE AND	EMERGENCY SERVICES	929 m <sup>2</sup>	
LEVEL 1.0 - T.O. MAIN FLOOR	SERVICES		94 m <sup>2</sup>	
			1456 m <sup>2</sup>	
LEVEL 2.0 - T.O. 2nd FLOOR	CHILD CARE		481 m <sup>2</sup>	
LEVEL 2.0 - T.O. 2nd FLOOR	SHARED		51 m <sup>2</sup>	
LEVEL 2.0 - T.O. 2nd FLOOR	PROTECTIVE AND	EMERGENCY SERVICES	514 m <sup>2</sup>	
LEVEL 2.0 - T.O. 2nd FLOOR	MULTI RESIDENTIA	AL	14 m²	
			1060 m <sup>2</sup>	
LEVEL 3.0 - T.O. 3rd FLOOR	MULTI RESIDENTIA	AL	1232 m <sup>2</sup>	
	<u>'</u>		1232 m²	
LEVEL 4.0 - T.O. 4th FLOOR	MULTI RESIDENTIA	AL	1232 m²	
			1232 m <sup>2</sup>	
LEVEL 5.0 - T.O. 5th FLOOR	MULTI RESIDENTIA	AL	1232 m <sup>2</sup>	
			1232 m <sup>2</sup>	
LEVEL 6.0 - T.O. 6th FLOOR	MULTI RESIDENTIA	AL	1232 m <sup>2</sup>	

Grand total

# MOTOR VEHICLE PARKING STALLS:

STAKEHOLDER/USE	REQUIRED	PROVIDED	DIFFERENCE	STALL SHARING	BYLAW/PROGRAM REQUIREMENT
Child Care - Drop Off	6	6	0	-	Requires min. of 1.0 pick-up/drop-off per 10 children; 55 children $=$ 6 drop-off stalls.
Child Care - Staff	8	8	0	Evening Visitor Shared Stalls.	Requires min. of 1.0 parking stalls per 2 employees at any given time, or 1.0 stalls per 10 children; 16 staff $= 8$ stalls.
Office - Staff (Corporate Accomodation)	4	4	0	City of Calgary Shared Staff Stalls.	Requires min. of 2.0 parking stalls per 100.0 square mof gross usable floor area; 168 $\text{rr}^2 = 4.0 \text{ stalls}$ .
Office - Loading (Corporate Accomodation)	0	0	0	-	0.0 loading stalls where the cumulative gross floor area of all buildings on a parcel is less than or equal to 930.0 square metres.
Multi-Residential - Tenant (Calgary Housing)	60	48	-12	NA - Designated Tenant Parking.	Requires 1.25 stalls when unit has gross floor area greater than 60.0 sq. $m$ , Requires 1.0 stalls when unit has gross floor area equal to or less than 60.0 sq. $m$ , Total stalls proposed per Calgary Housing programming requirements = 48.
Multi-Residential - Visitor (Calgary Housing)	8	0	-8	Evening Visitor Shared Stalls.	Requires 0.15 visitor parking stalls per unit; $48$ units $= 8$ stalls.
Protective and Emergency Services - Staff (Calgary Fire Department and Alberta Health Services)	_*	18	18	City of Calgary Shared Staff Stalls.	Bylaw does not require motor vehicle parking.  Program requires: 16 CFD staff parking for a 16 person shift; 2 AHS staff parking for 2 person shift = 18 stalls.
Protective and Emergency Services - Visitor (Calgary Fire Department and Alberta Health Services)	<u>-</u> *	2	2	City of Calgary Shared Staff Stalls.	Bylaw does not require motor vehicle parking. Program requires: 2 visitor stalls. Proposed sharing with CA staff parking.
Protective and Emergency Services - Loading (Calgary Fire Department and Alberta Health Services)	_*	0	-	-	Bylaw does not require motor vehicle parking. Program requires: 0 loading stalls.
Waste Disposal & Treatment Facility - Drop Off (Household Hazardous Waste)	_*	3	3	NA- Designated H+WD Stalls.	Bylaw does not require motor vehicle parking. Program requires 3 drop-off stalls due to assessed existing customer usage: the existing site services 75-100 customers per day during spring/summer/fall and 25-50 customers per day during winter; drop-off stalls will be signed as loading stalls.
Loading Stalls - (Multi-Residential Development)	1	1	0		Where a building contains 20 or more units with shared entrance facilities, a minimum of 1.0 loading stalls is required. Temporary loading stall is proposed. Refer to DF-100.
Loading Stalls – CFD & AHS (Protective and Emergency Response Service)	_*	0			Bylaw does not require motor vehicle parking. Program requires: 0 loading stalls
Loading Stalls - Office & CRU	0	0			0.0 loading stalls where the cumulative gross floor area of all buildings on a parcel is less than or equal to 930.0 square metres.
Total	87	90	3	24 City of Calgary Staff Stalls. 8 Shared Child Care Staff and Visitor Stalls. 36% of proposed stalls are shared.	
*Bylaw does not require parking				00/00 proposou sians are sina ou.	

# AVENTY SPACE SCHEDULE:

<b>REQUIRED AMENITY SPACE</b> 48 Units x 5.0 m <sup>2</sup> per unit	<b>TOTAL ARE</b> / 240.0 m <sup>2</sup>
PROVIDED AMENITY SPACE	TOTAL AREA
Provided Private Amenity Space (Balcony) (4 m²/ Unit)	192 m²
Provided Total Common Amenity Space - Outdoors Resource Room Deck	42.7 m²
Provided Total Common Amenity Space - Indoors Resource Room (L3): 48 m² Social Spaces (L4 - L6): 36 x 3 = 108 m²	<u>156.0 m²</u> 48 m² 108 m²
Total Provided Amenity Space	<b>390</b> .7 m <sup>2</sup>
Provided Total Amenity Area / Unit	8.14 m²

# LANDSCAPED AREA SCHEDULE:

Total Landscape Area:

Refer to Planting Plan L-01 for further information.

Total Percentage

REQUIRED LANDSCAPING	TOTAL AREA	
Required landscape area (40% of Lot)	3,550 m²	
Required landscape area per low irrigation (37% of Lot)	3,284 m²	
At least 80% of the required landscaping area to be at grade	<b>2,627</b> m²	
Required max hard surfaced area (40% of required c/w reductions applied):	1,314 m²	
PROPOSED LANDSCAPING	TOTAL AREA	
At Grade Landscaping		
Hard Surfaced Area (plaza, sidewalks, CFD patio, sloped landscape stairs)	1,120 m²	
Soft Surfaced Area	1, <b>69</b> 6 m²	
Sub-Total	2,816 m²	
Above Grade Landscaping		
Hard Surfaced Area (CRU stairs & terraces, Resource Room deck)	233 m²	
Soft Surfaced Area (CRU planter)	7 m²	
Sub-Total	<b>240</b> m²	
Total Hard Surfaced Area	1,353 m²	

34.4%

# REQUIRED LANDSCAPING

2020.04.15 2020.04.15 2020.06.24 2020.06.29 2020.06.29 2020.08.13
2020.06.24 2020.06.29 2020.06.29
2020.06.29 2020.06.29
2020.06.29
2020.08.13

PRIME CONSULTANT

Contact: Mchelle Smith Cowman T. 403.261.9050 F. 403.261.9054

Do not scale drawings. This drawing supercedes previous issues.

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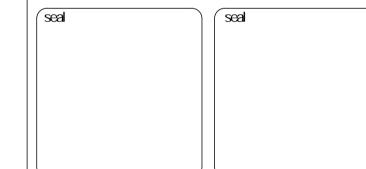
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Verify all dimensions, elevations, and datum report any errors and/or discrepancies to the architect prior to construction.

DESCRIPTION

DATE

2019.12.05 2019.12.05



## permit PRELIMINARY NOT FOR CONSTRUCTION

Architectural: the marc boutin architectural collaborative & johnston davidson architecture + planning Landscape: ISL Engineering and Land Services
Structural: Entuitive Corporation
Mechanical: The AVE Consulting Group Ltd. Electrical: Nemetz & Associates Ltd.

Ovil: ISL Engineering and Land Services Consultant Project Number: 18004



CITY OF CALGARY

Varsity Multi-Service Redevelopment Project Address: 3740 - 32nd Avenue NW, Calgary, AB location: Legal Address: Plan 1799GC Block 2 Lot 9


drawing title PERMIT SCHEDULES

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drawnby	Author		drawing no.	DP-001
checked by	Checker		~	<u> </u>
reviewed by			project no.	18004
CADfile name:				

# BICYCLE PARKING STALLS:

STAKEHOLDER/USE	NUIVBER	BYLAW/PROCRAM REQUIREVENT
Protective and Emergency Services - Class 1 - Class 2	2 2	Requires a minimum of 1.0 bicycle parking stalls – class 1 per 1000.0 square metres of gross usable floor area. Requires a minimum of 1.0 bicycle parking stalls – class 2 per 1000.0 square metres gross usable floor area for Offices greater than 1000.0 square metres.
Multi-Residential - Class 1 - Class 2	24 5	As per the bylaw, 0.5 stalls – class 1 per unit, where the total number of units is equal to or exceeds 20. As per the bylaw, 0.1 stalls – class 2 per unit, with a minimum of 2.0 stalls.
Office - Class 1 - Class 2	1 1	Requires a minimum of 1.0 bicycle parking stalls – class 1 per 1000.0 square metres of gross usable floor area. Requires a minimum of 1.0 bicycle parking stalls – class 2 per 1000.0 square metres gross usable floor area for Offices greater than 1000.0 square metres.
Waste Disposal & Treatment Facility - Class 1 - Class 2	0 0	None required by bylaw or program. None required by bylaw or program.
Child Care - Class 1 - Class 2	1 1	Requires a minimum of 1.0 bicycle parking stalls – class 1 per 1000.0 square metres of gross usable floor area. Requires a minimum of 1.0 bicycle parking stalls – class 2 per 1000.0 square metres gross usable floor area for Offices greater than 1000.0 square metres.
SUE-TOTAL Class 1 Class 2	28 9	56 Provided. 10 Provided.

CPC2020-0927 - Attach 1 ISC: UNRESTRICTED

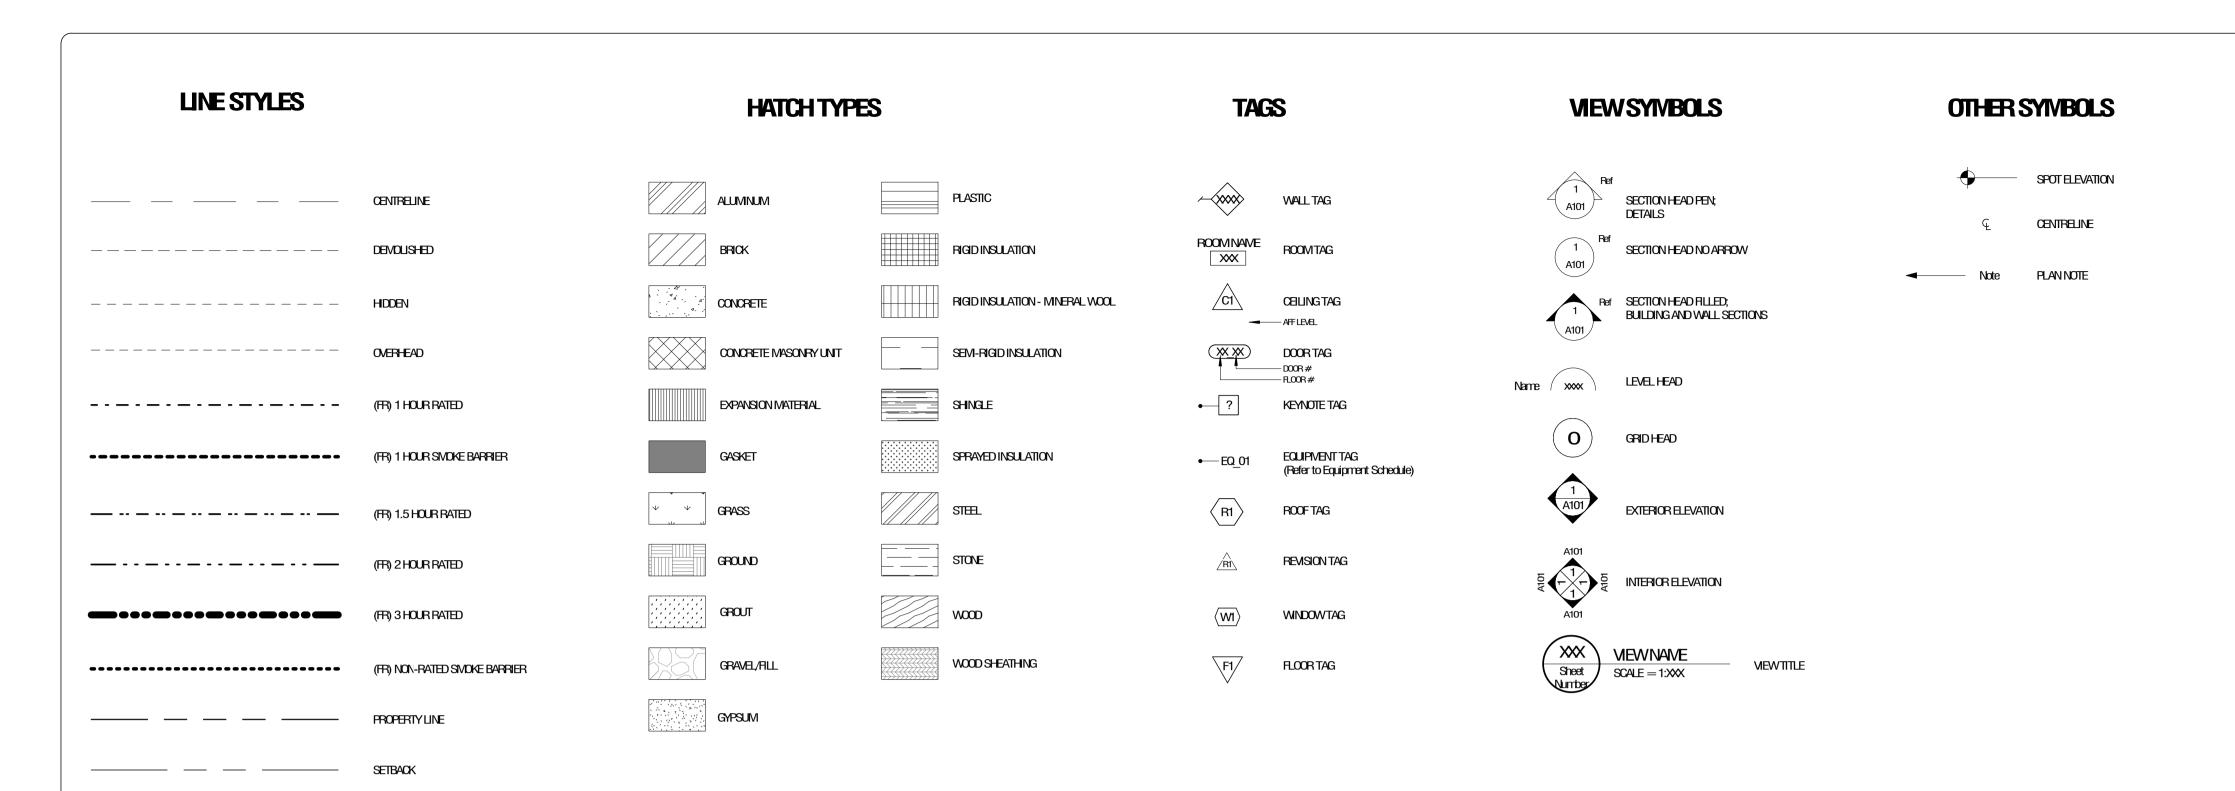

# **ABBREVIATIONS**

GENERAL:	
AFF	ABOVE FINISHED FLOOR
EQ.	EQUAL
FRR	FIRE RESISTANCE RATING
MAX	MAXIMUM
MIN	MNMM
MIRR	MRROR
RCP	REPLECTED CEILING PLAN
SIM	SIMILAR
TYP.	TYPICAL
T.O.	TOP OF
u/s	UNDERSIDE
uno	UNLESS NOTED OTHERWISE
VOS	VERIFY ON SITE


MATERIAL: ACOUSTICAL DOOR ACOUSTIC CEILING TILE alumnum FIBERGLASS FIBRE REINFORCED LAMINATE FIBREGLASS REINFORCED PLASTIC GLAZED DOOR GYPSUM WALL BOARD HOLLOWCORE HCW HOLLOW CORE WOOD DOOR INSULATED CORE MDF MDF - FORMALDEHYDE FREE OAK PFA PR PSF PERFORATED ALUMNUM PAIR OF DOORS PRESSED STEEL FRAME SOLID CORE SOLID CORE WOOD DOOR SLIDING DOUBLE DOOR STG ST TFG W STRUCTURAL GLASS

TEMPERED PROSTED GLASS

STEEL


FINISHES: ANODIZED ALUMINUM ARCHITECTURALLY EXPOSED CONCRETE CARPETTILE EPOXY COATING FLOOR TILE FOOT GRILL LUXURTY FLOOR TILE/PLANK MELAMINE MIRROR MM MILLWORK MMB MILLWORK WOOD BASE PC POWDER COATED POLISHED & SEALED CONCRETE PT PANT
PF PREFINIS PF PREHINSHED
PT-CP CELLING PLENUM PAINT RUBBER BASE COVE RESILIENT FLOORING SCHT SCHLUTERTRIM SOLID SURFACE STAINLESS STEEL TACK BOARD TILE BASE COVE VINYL GRAPHIC VINML SIGNAGE WHITEBOARD PAINT WALL PROTECTION

WALLTILE

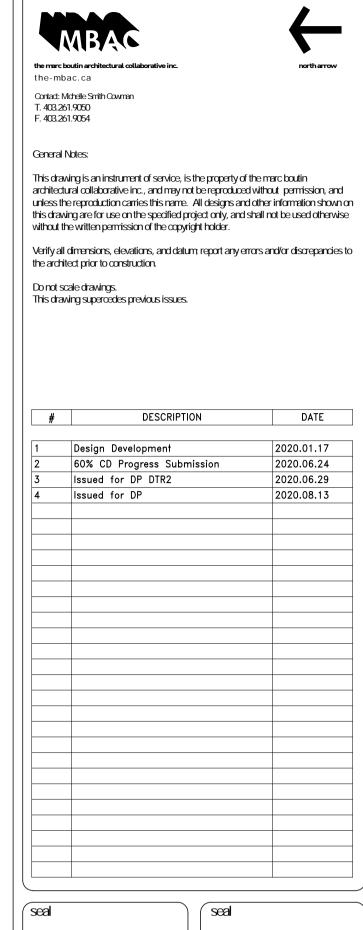


notes

PRIME CONSULTANT

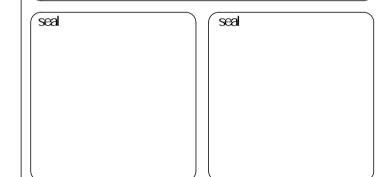

permit PRELIMINARY NOT FOR CONSTRUCTION

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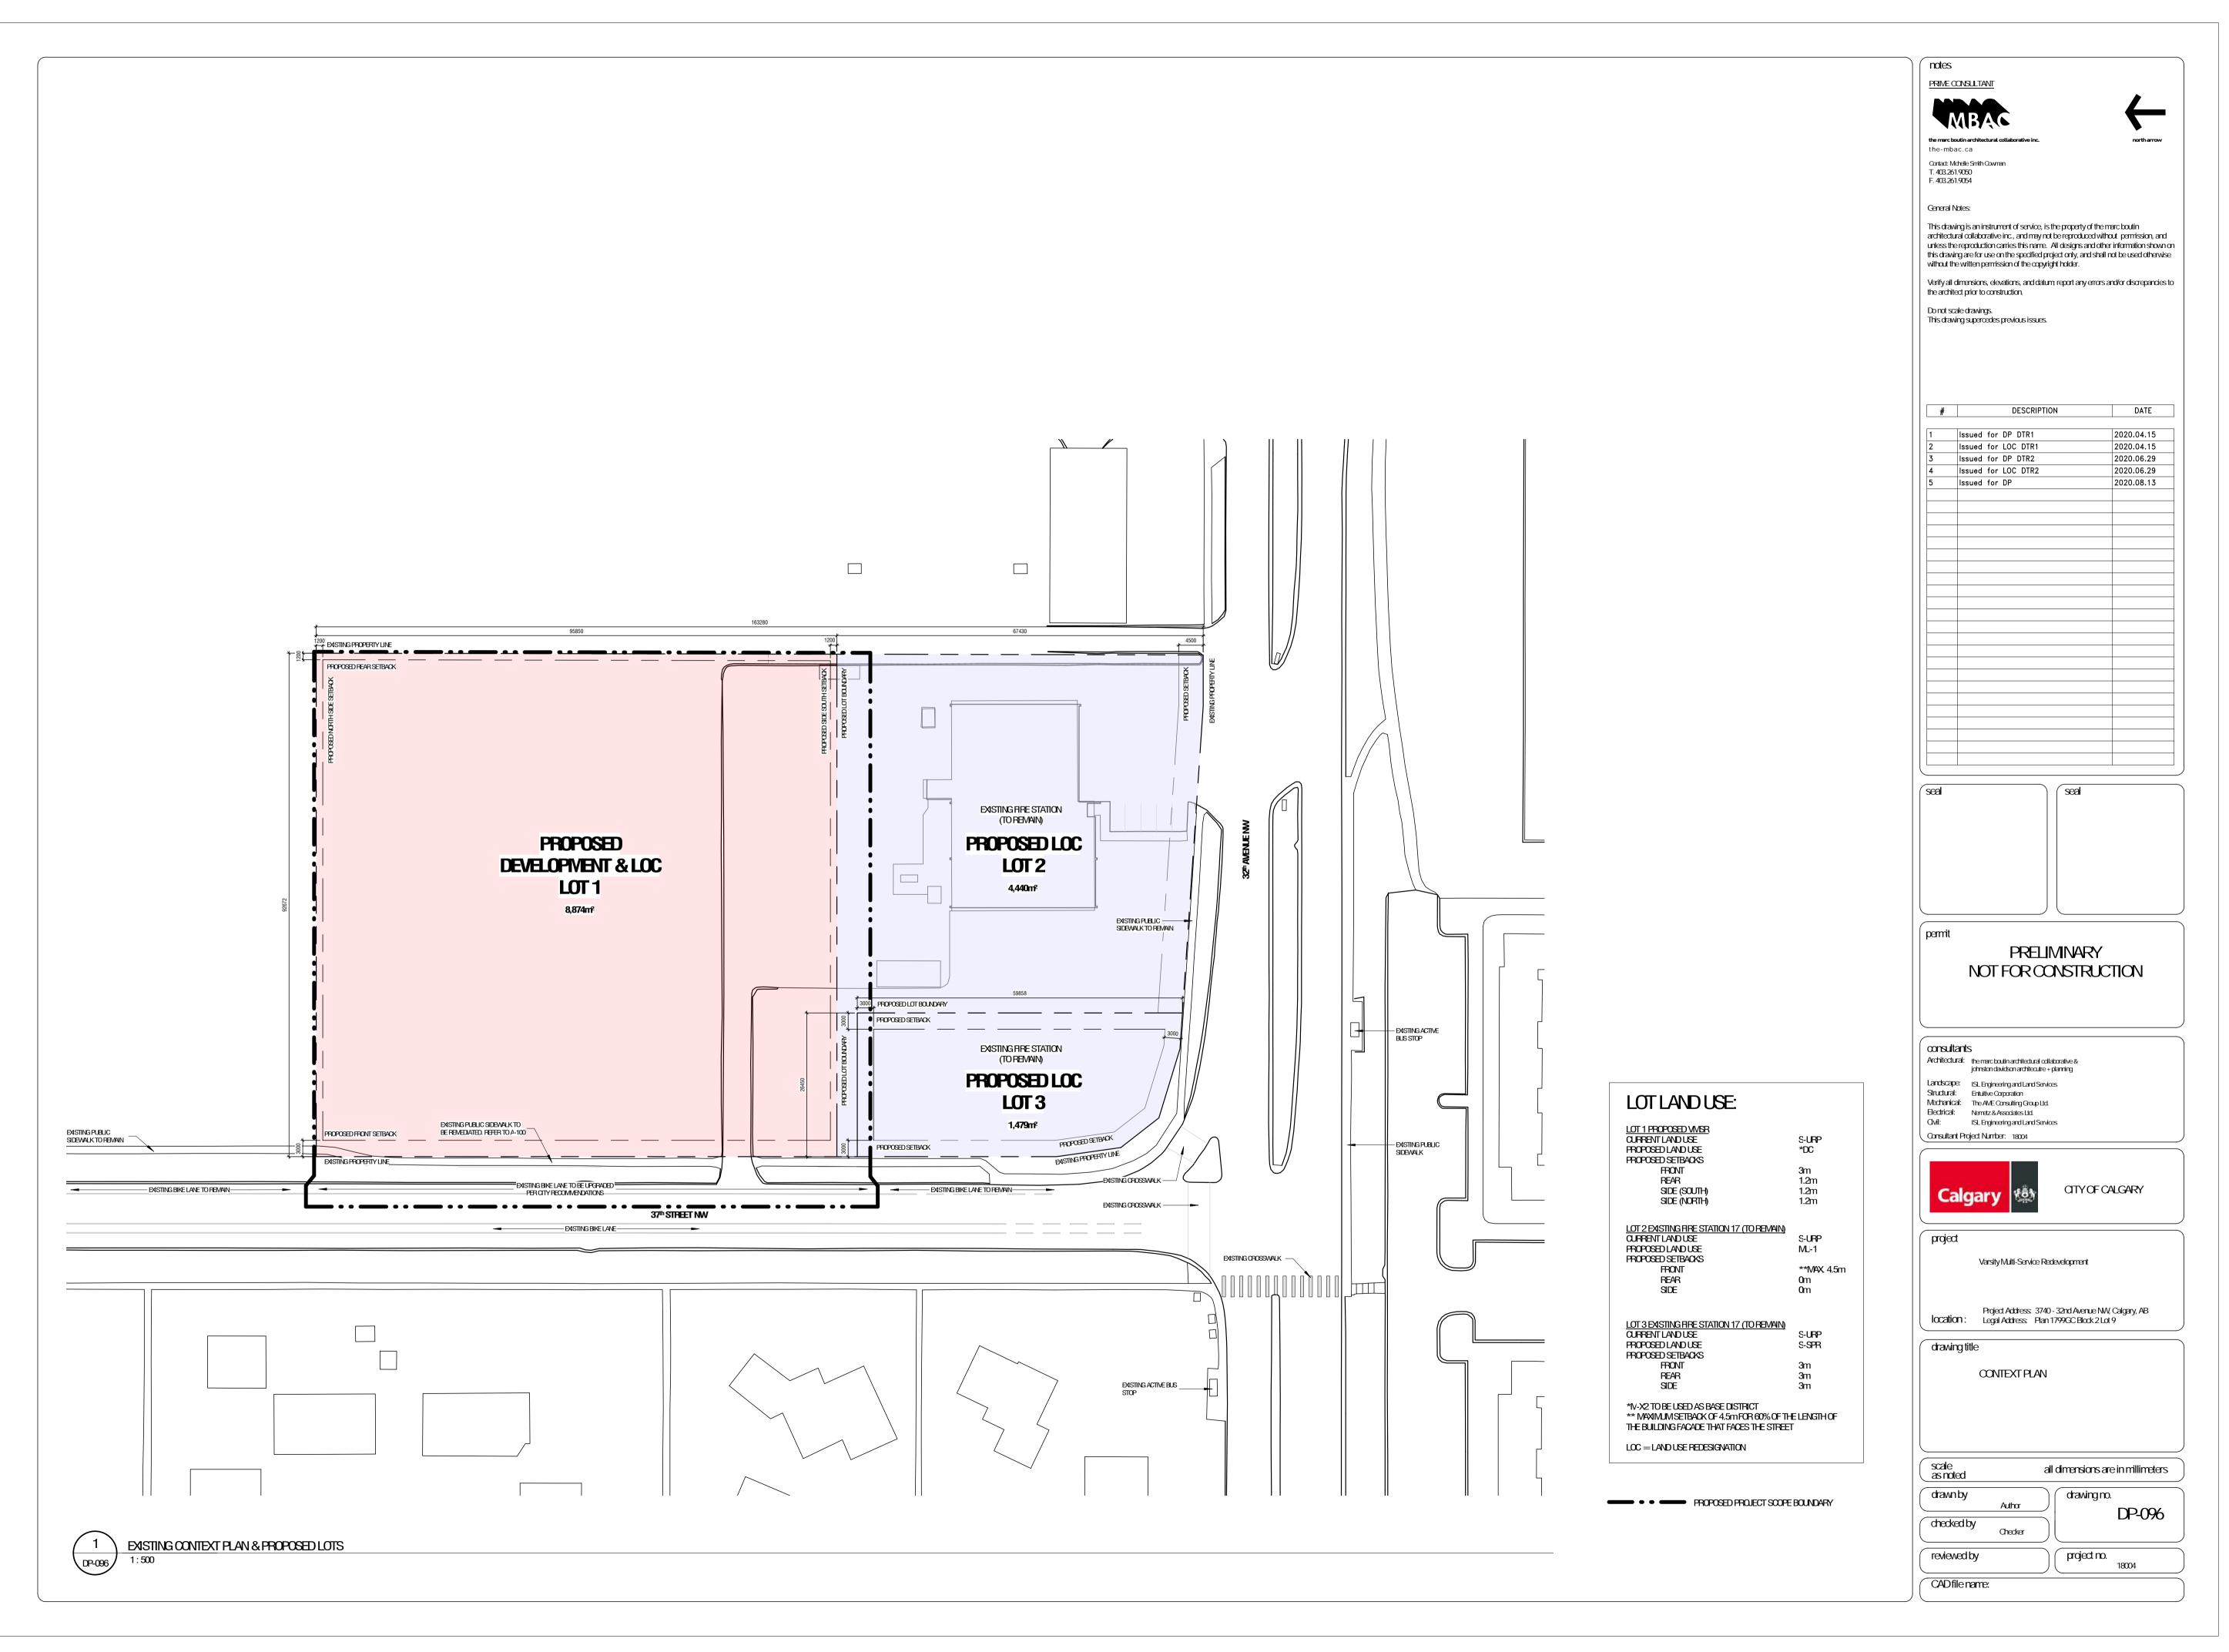


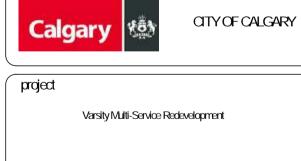
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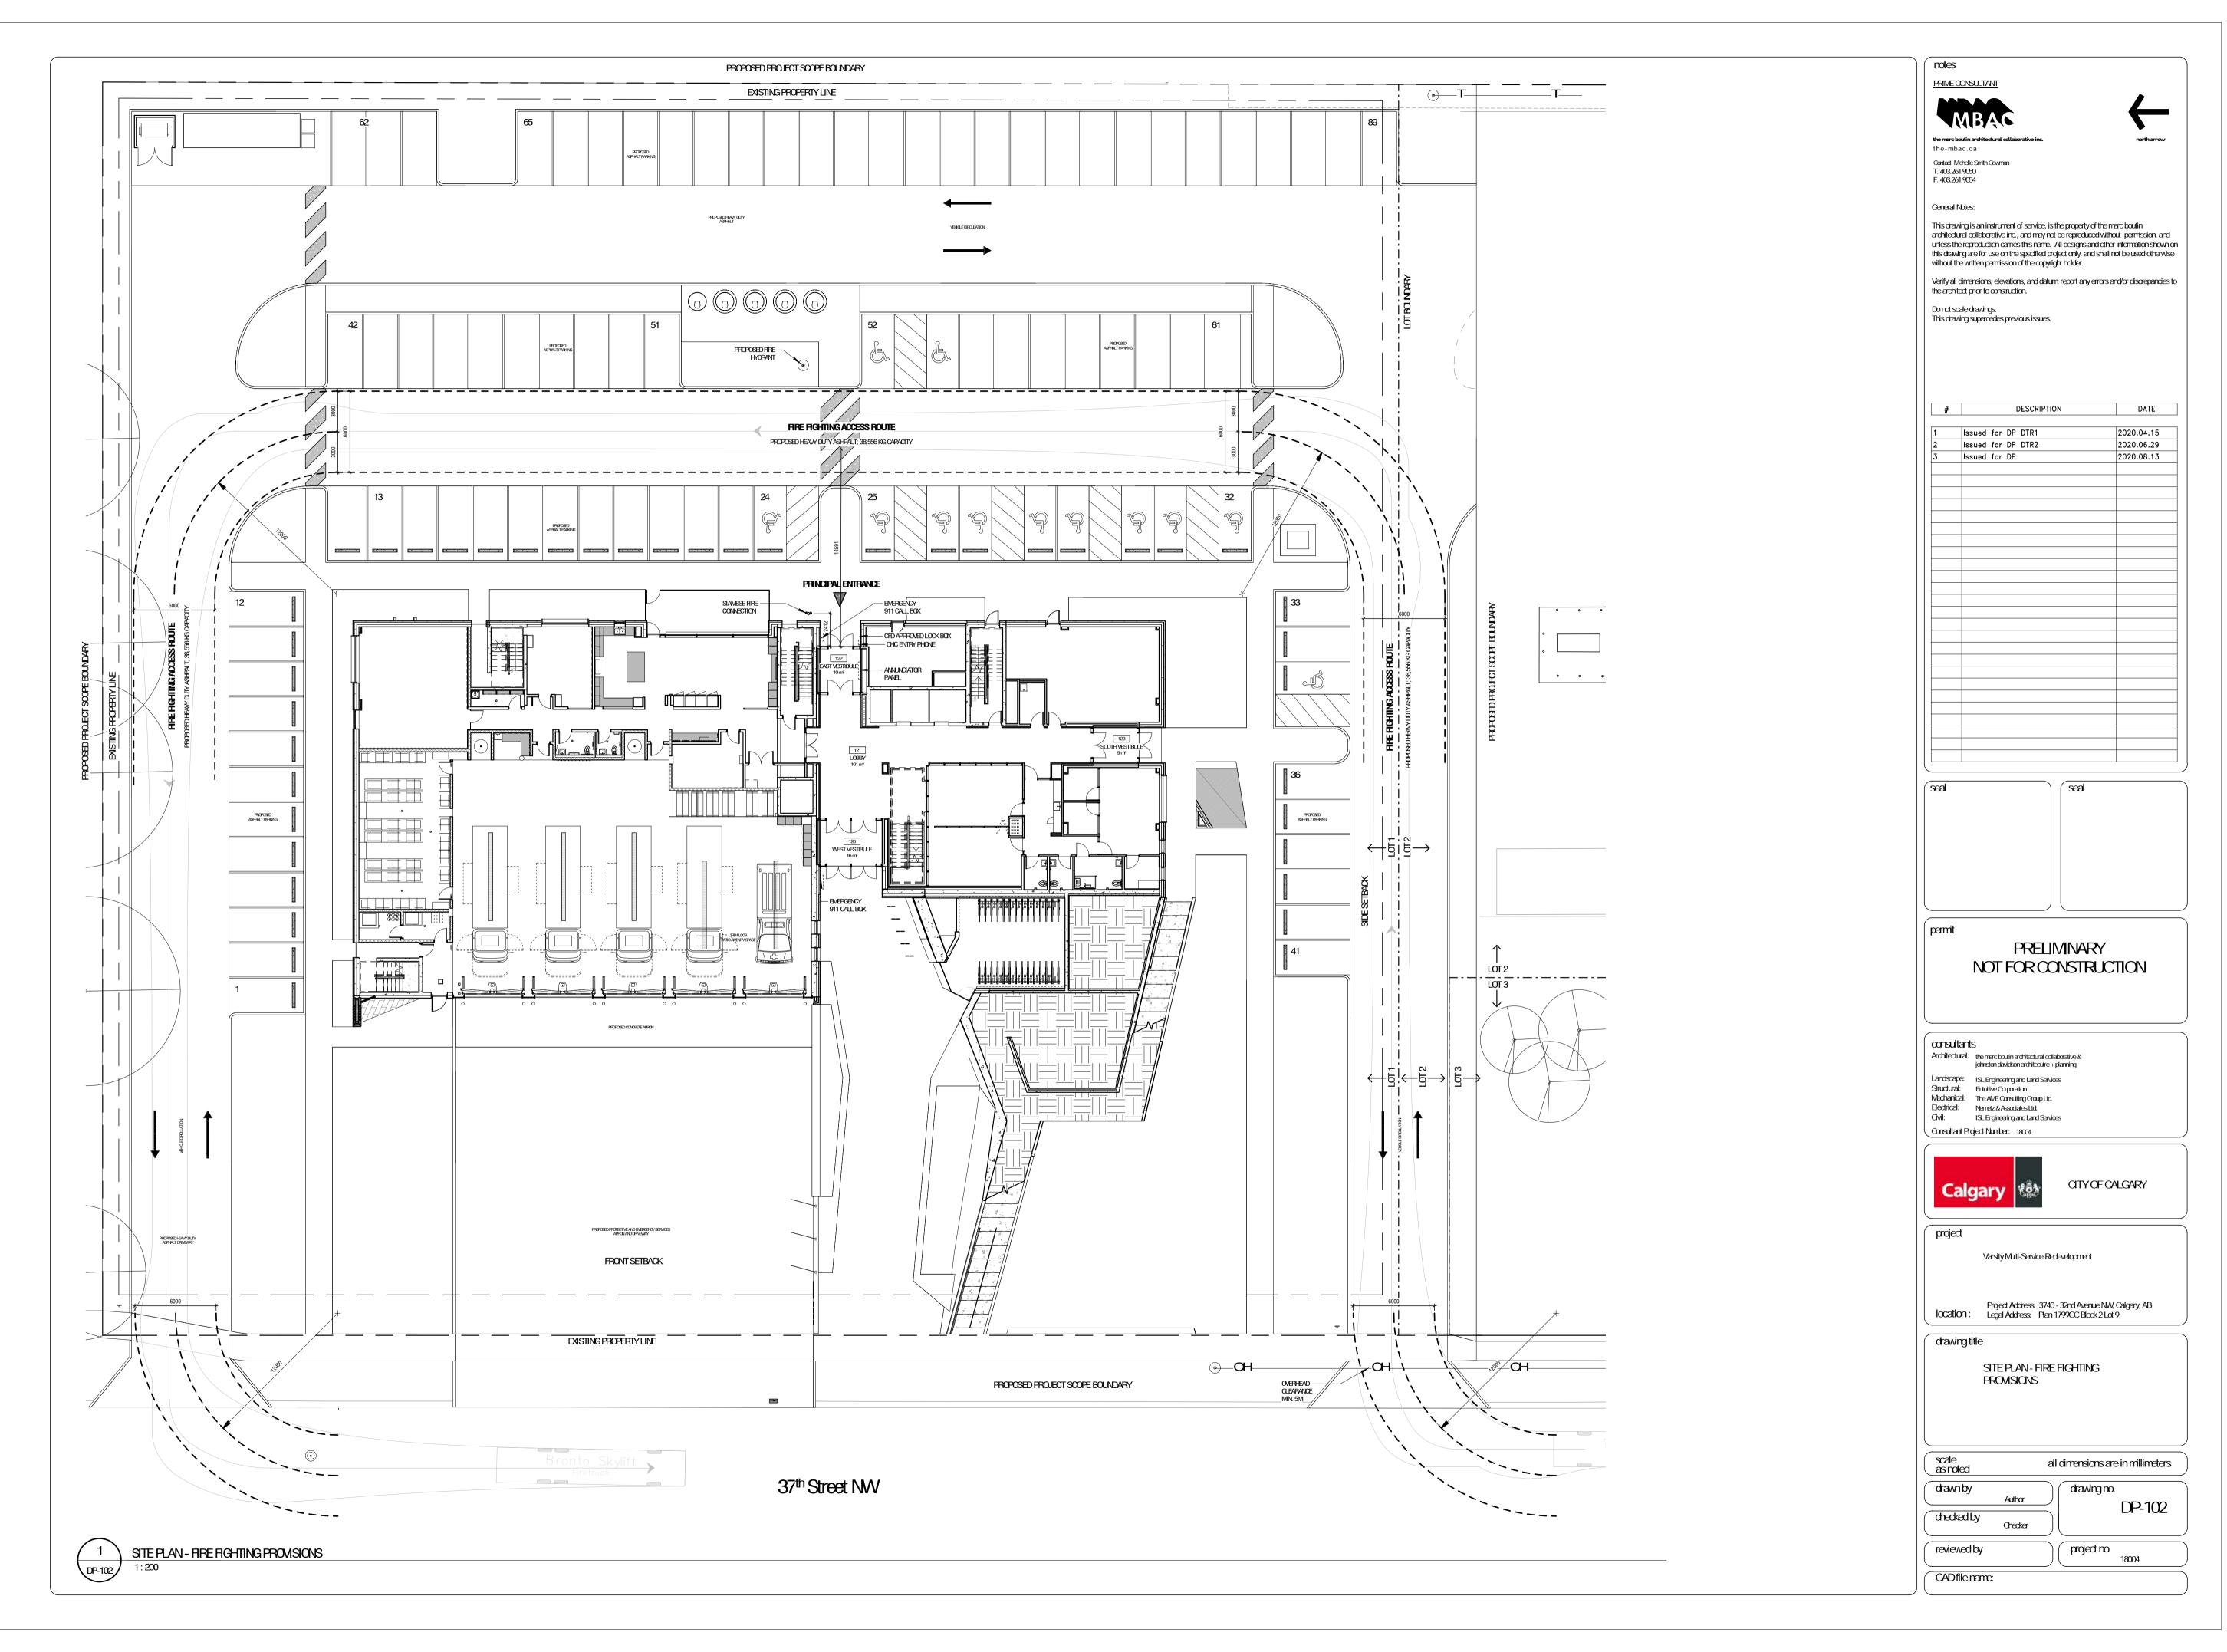
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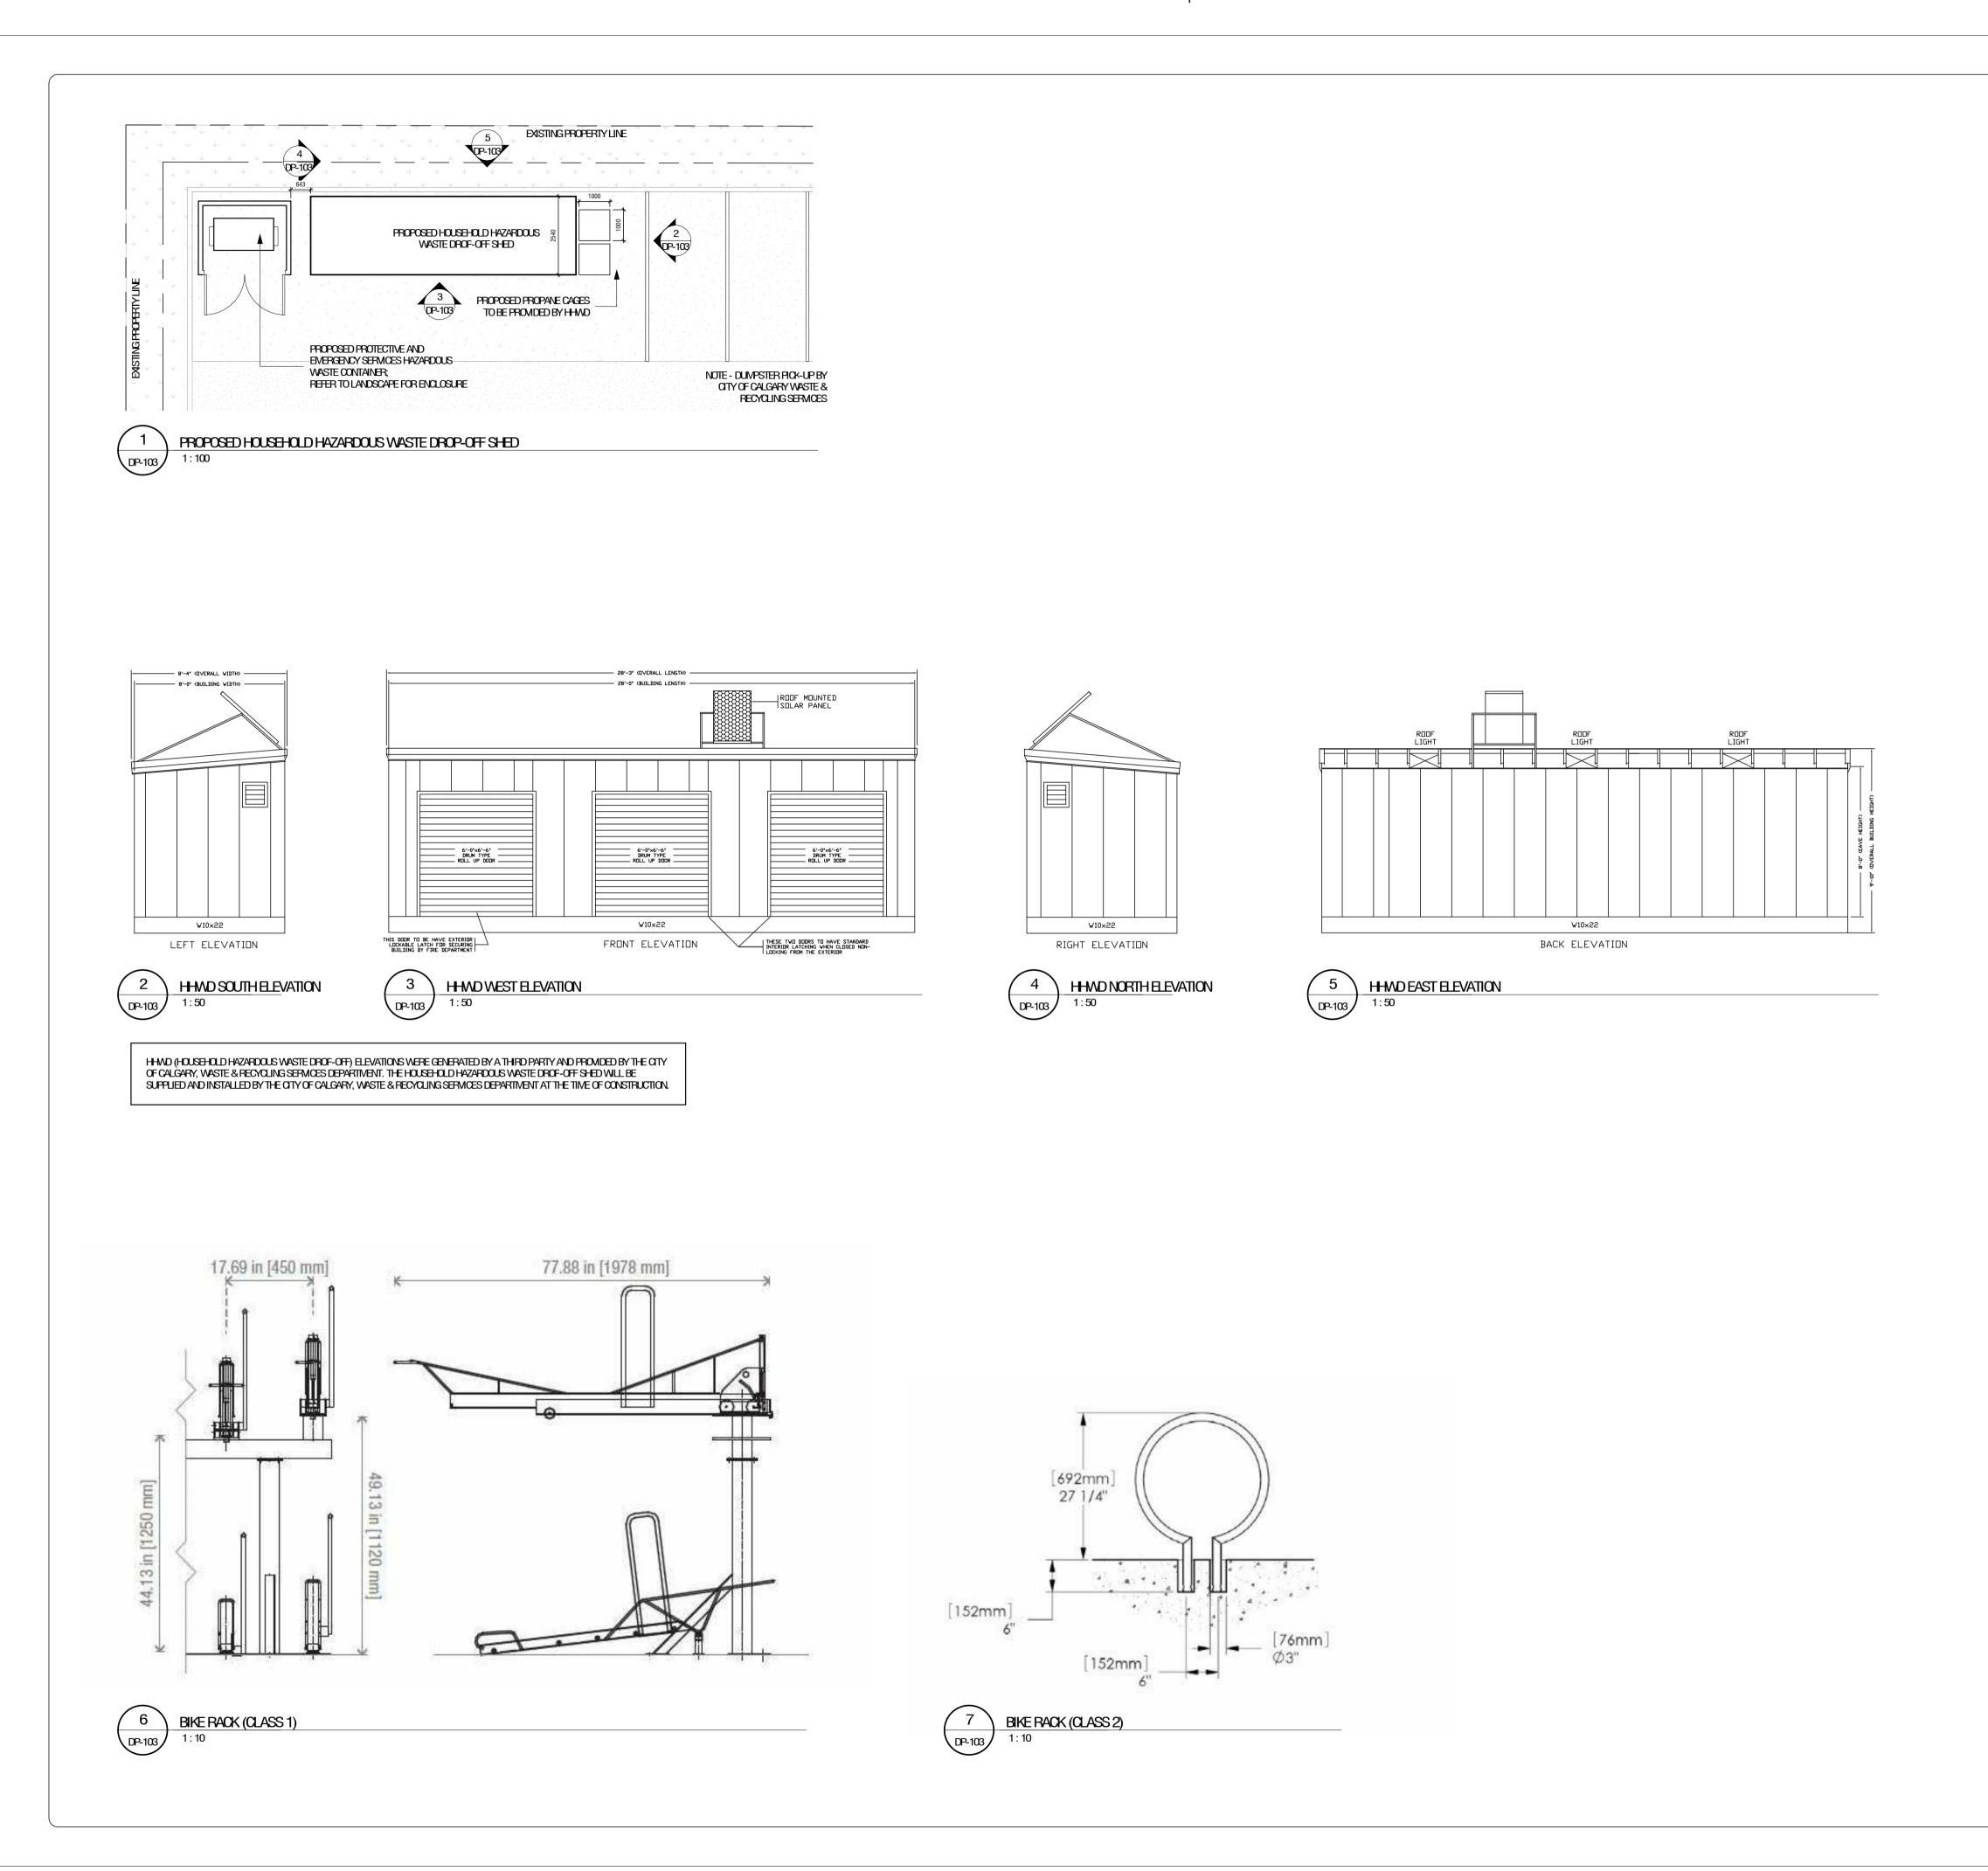
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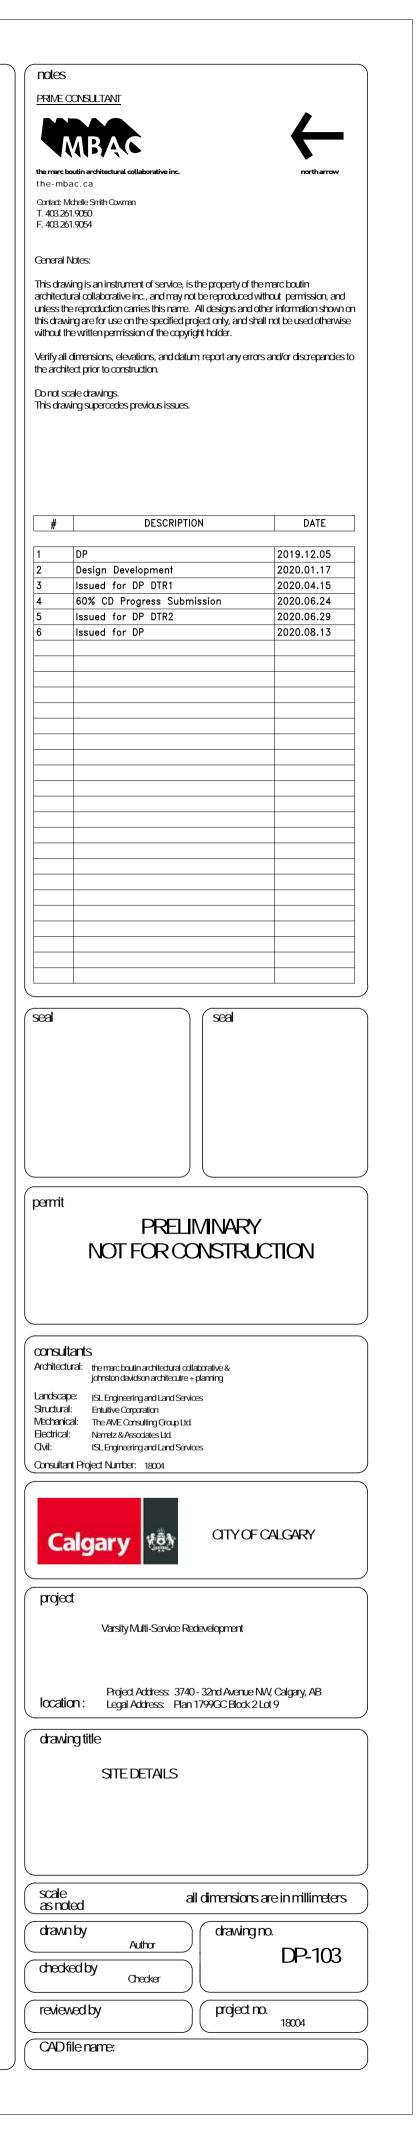
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reviewed by		project no.	18004
CADfile name:			













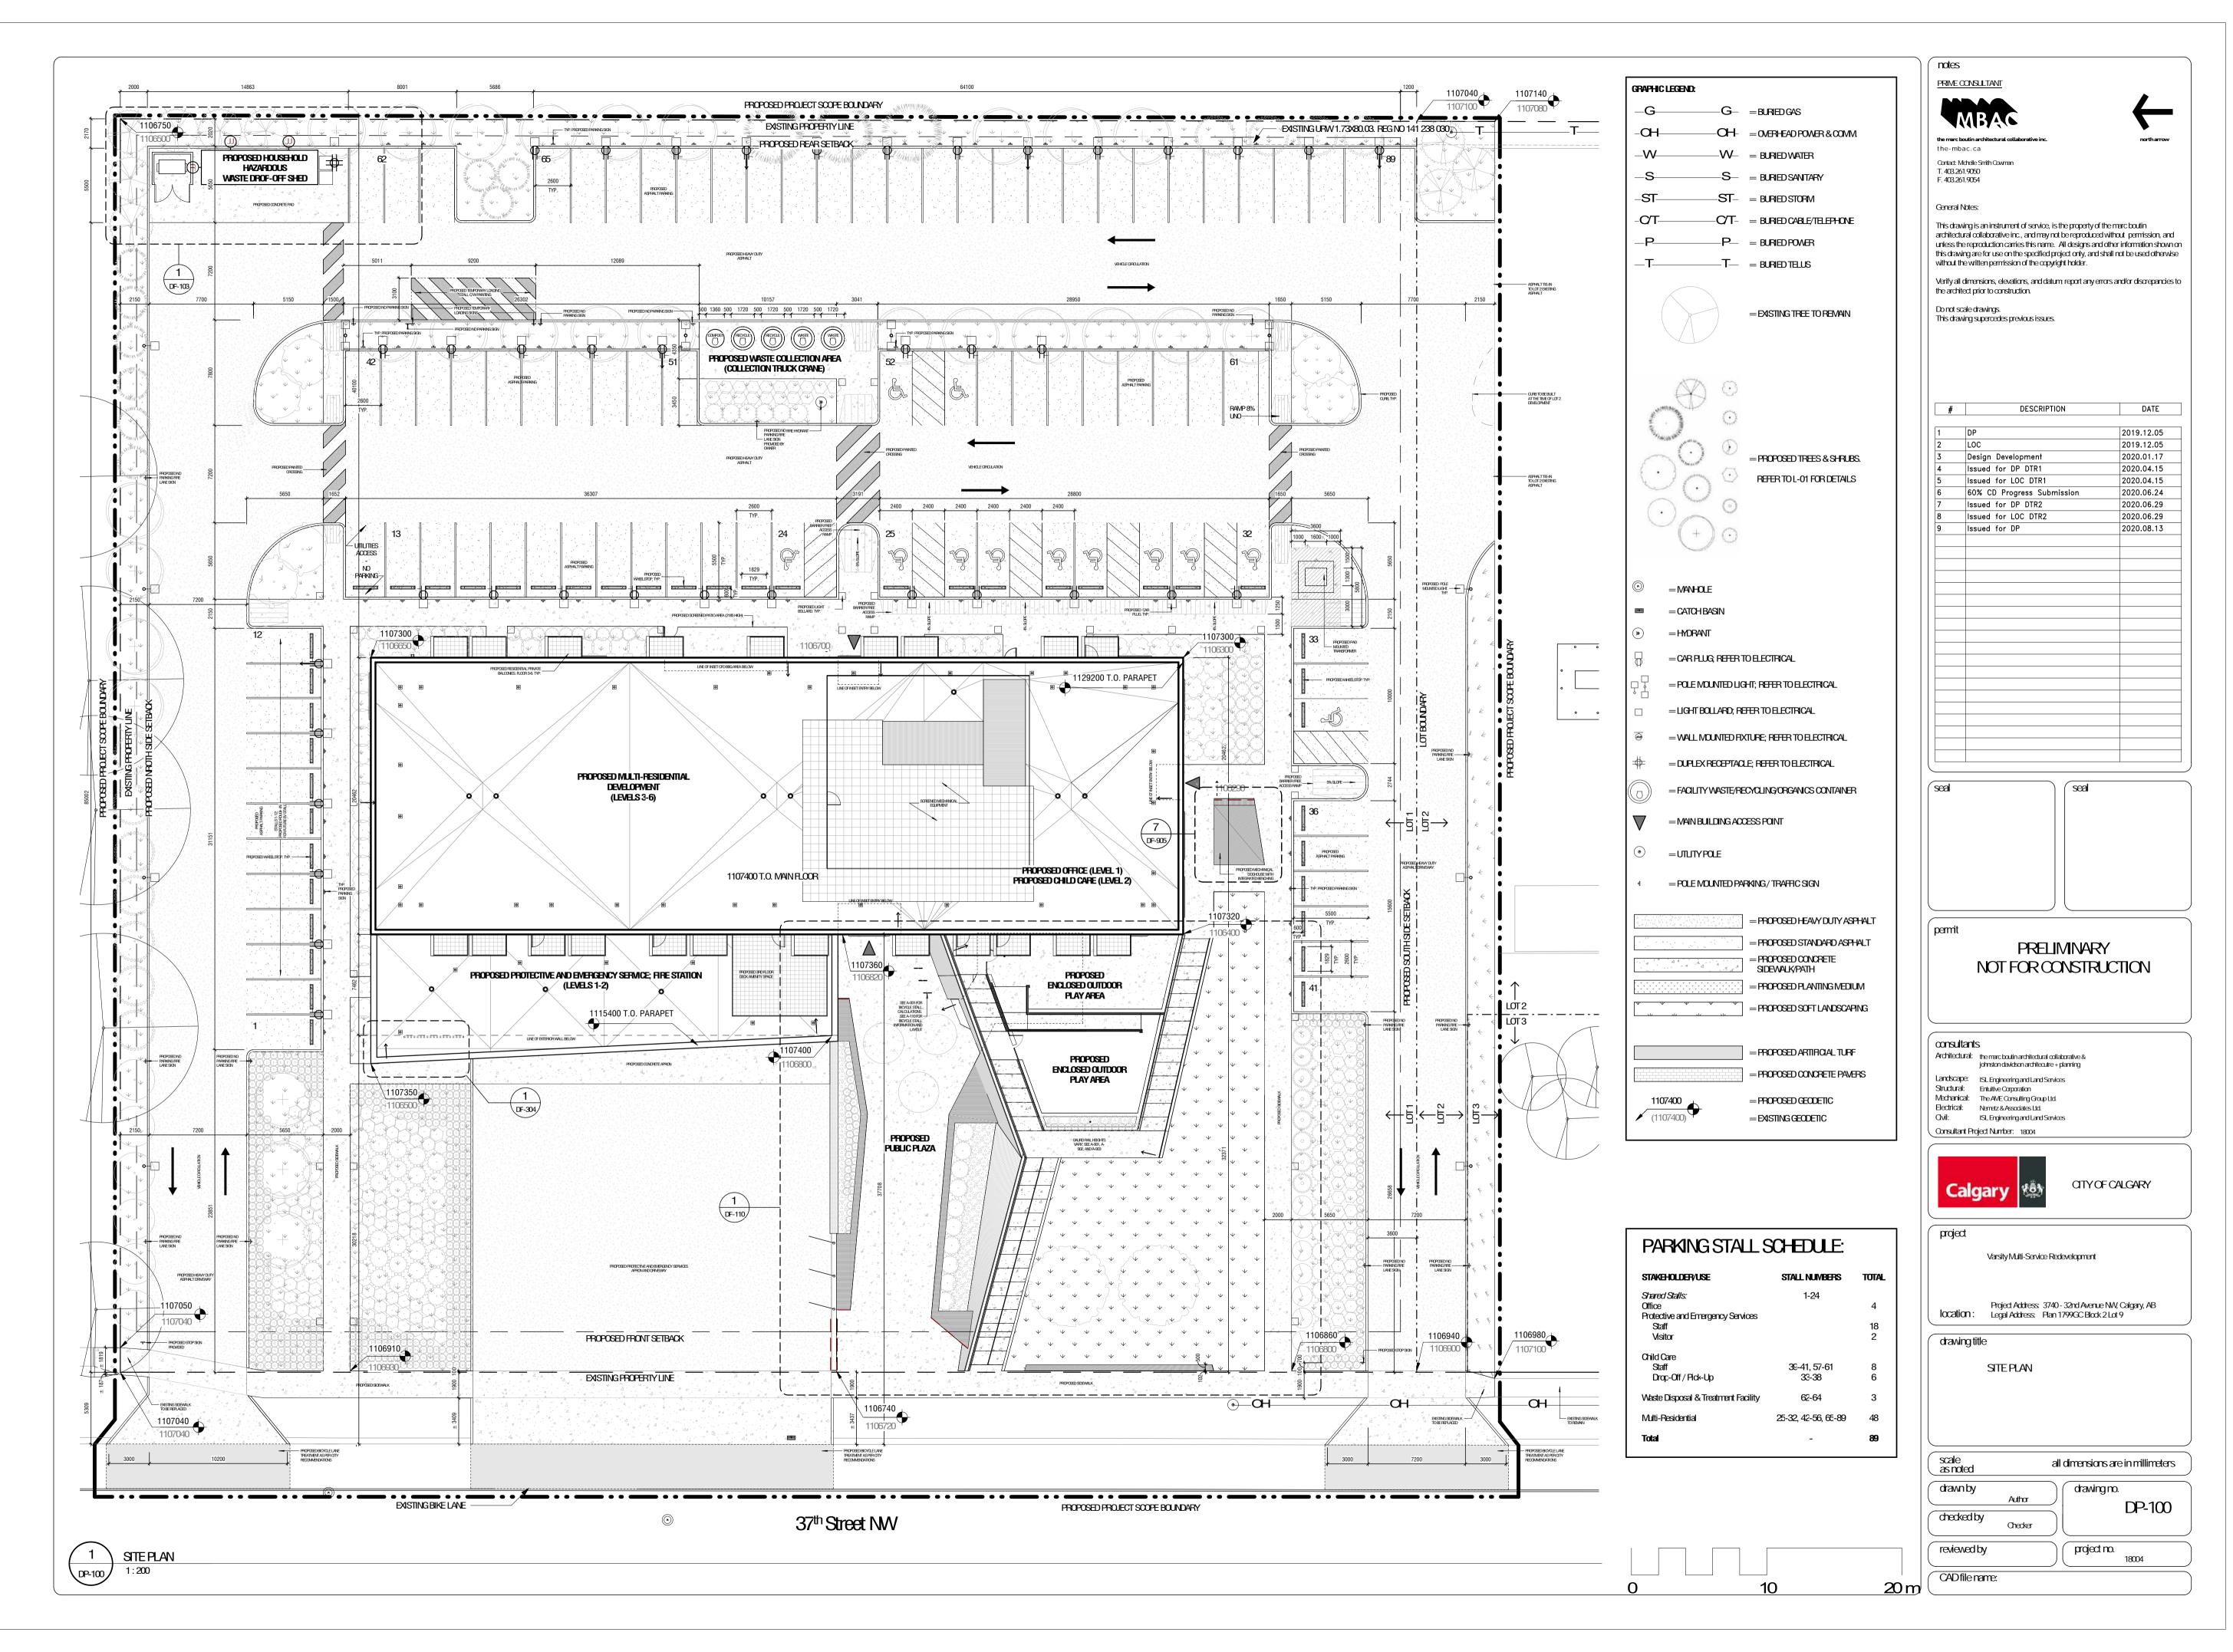


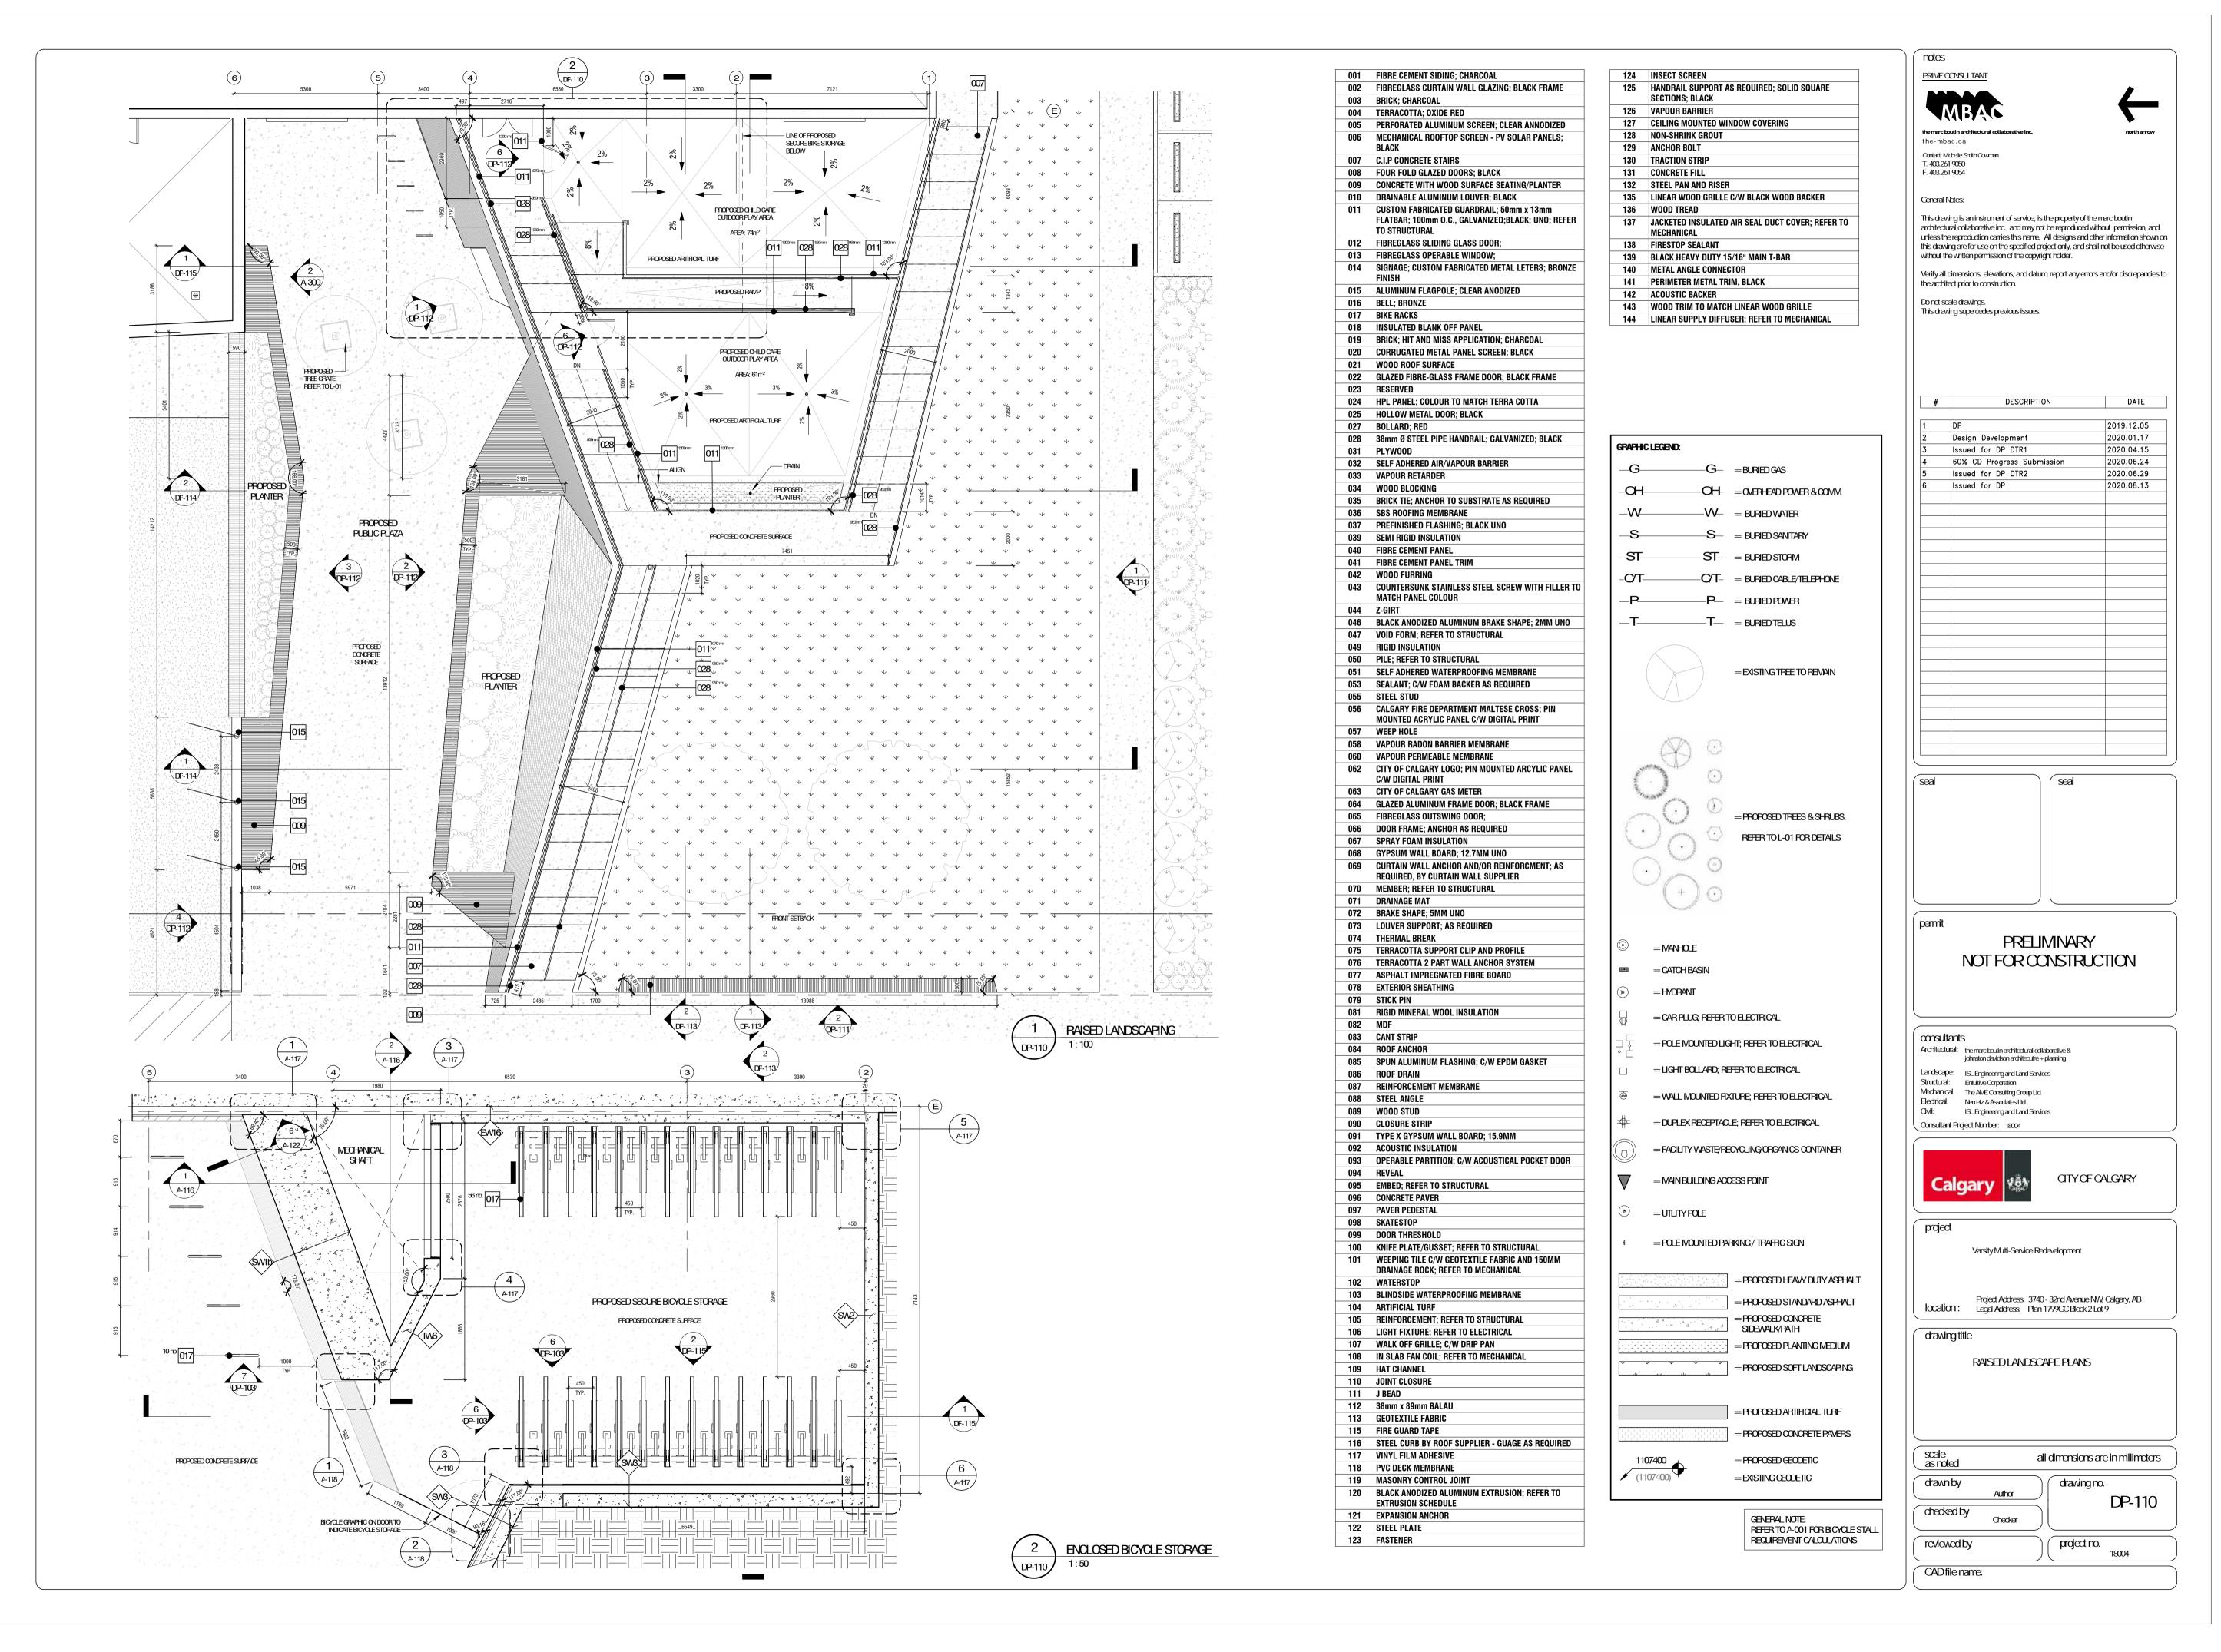


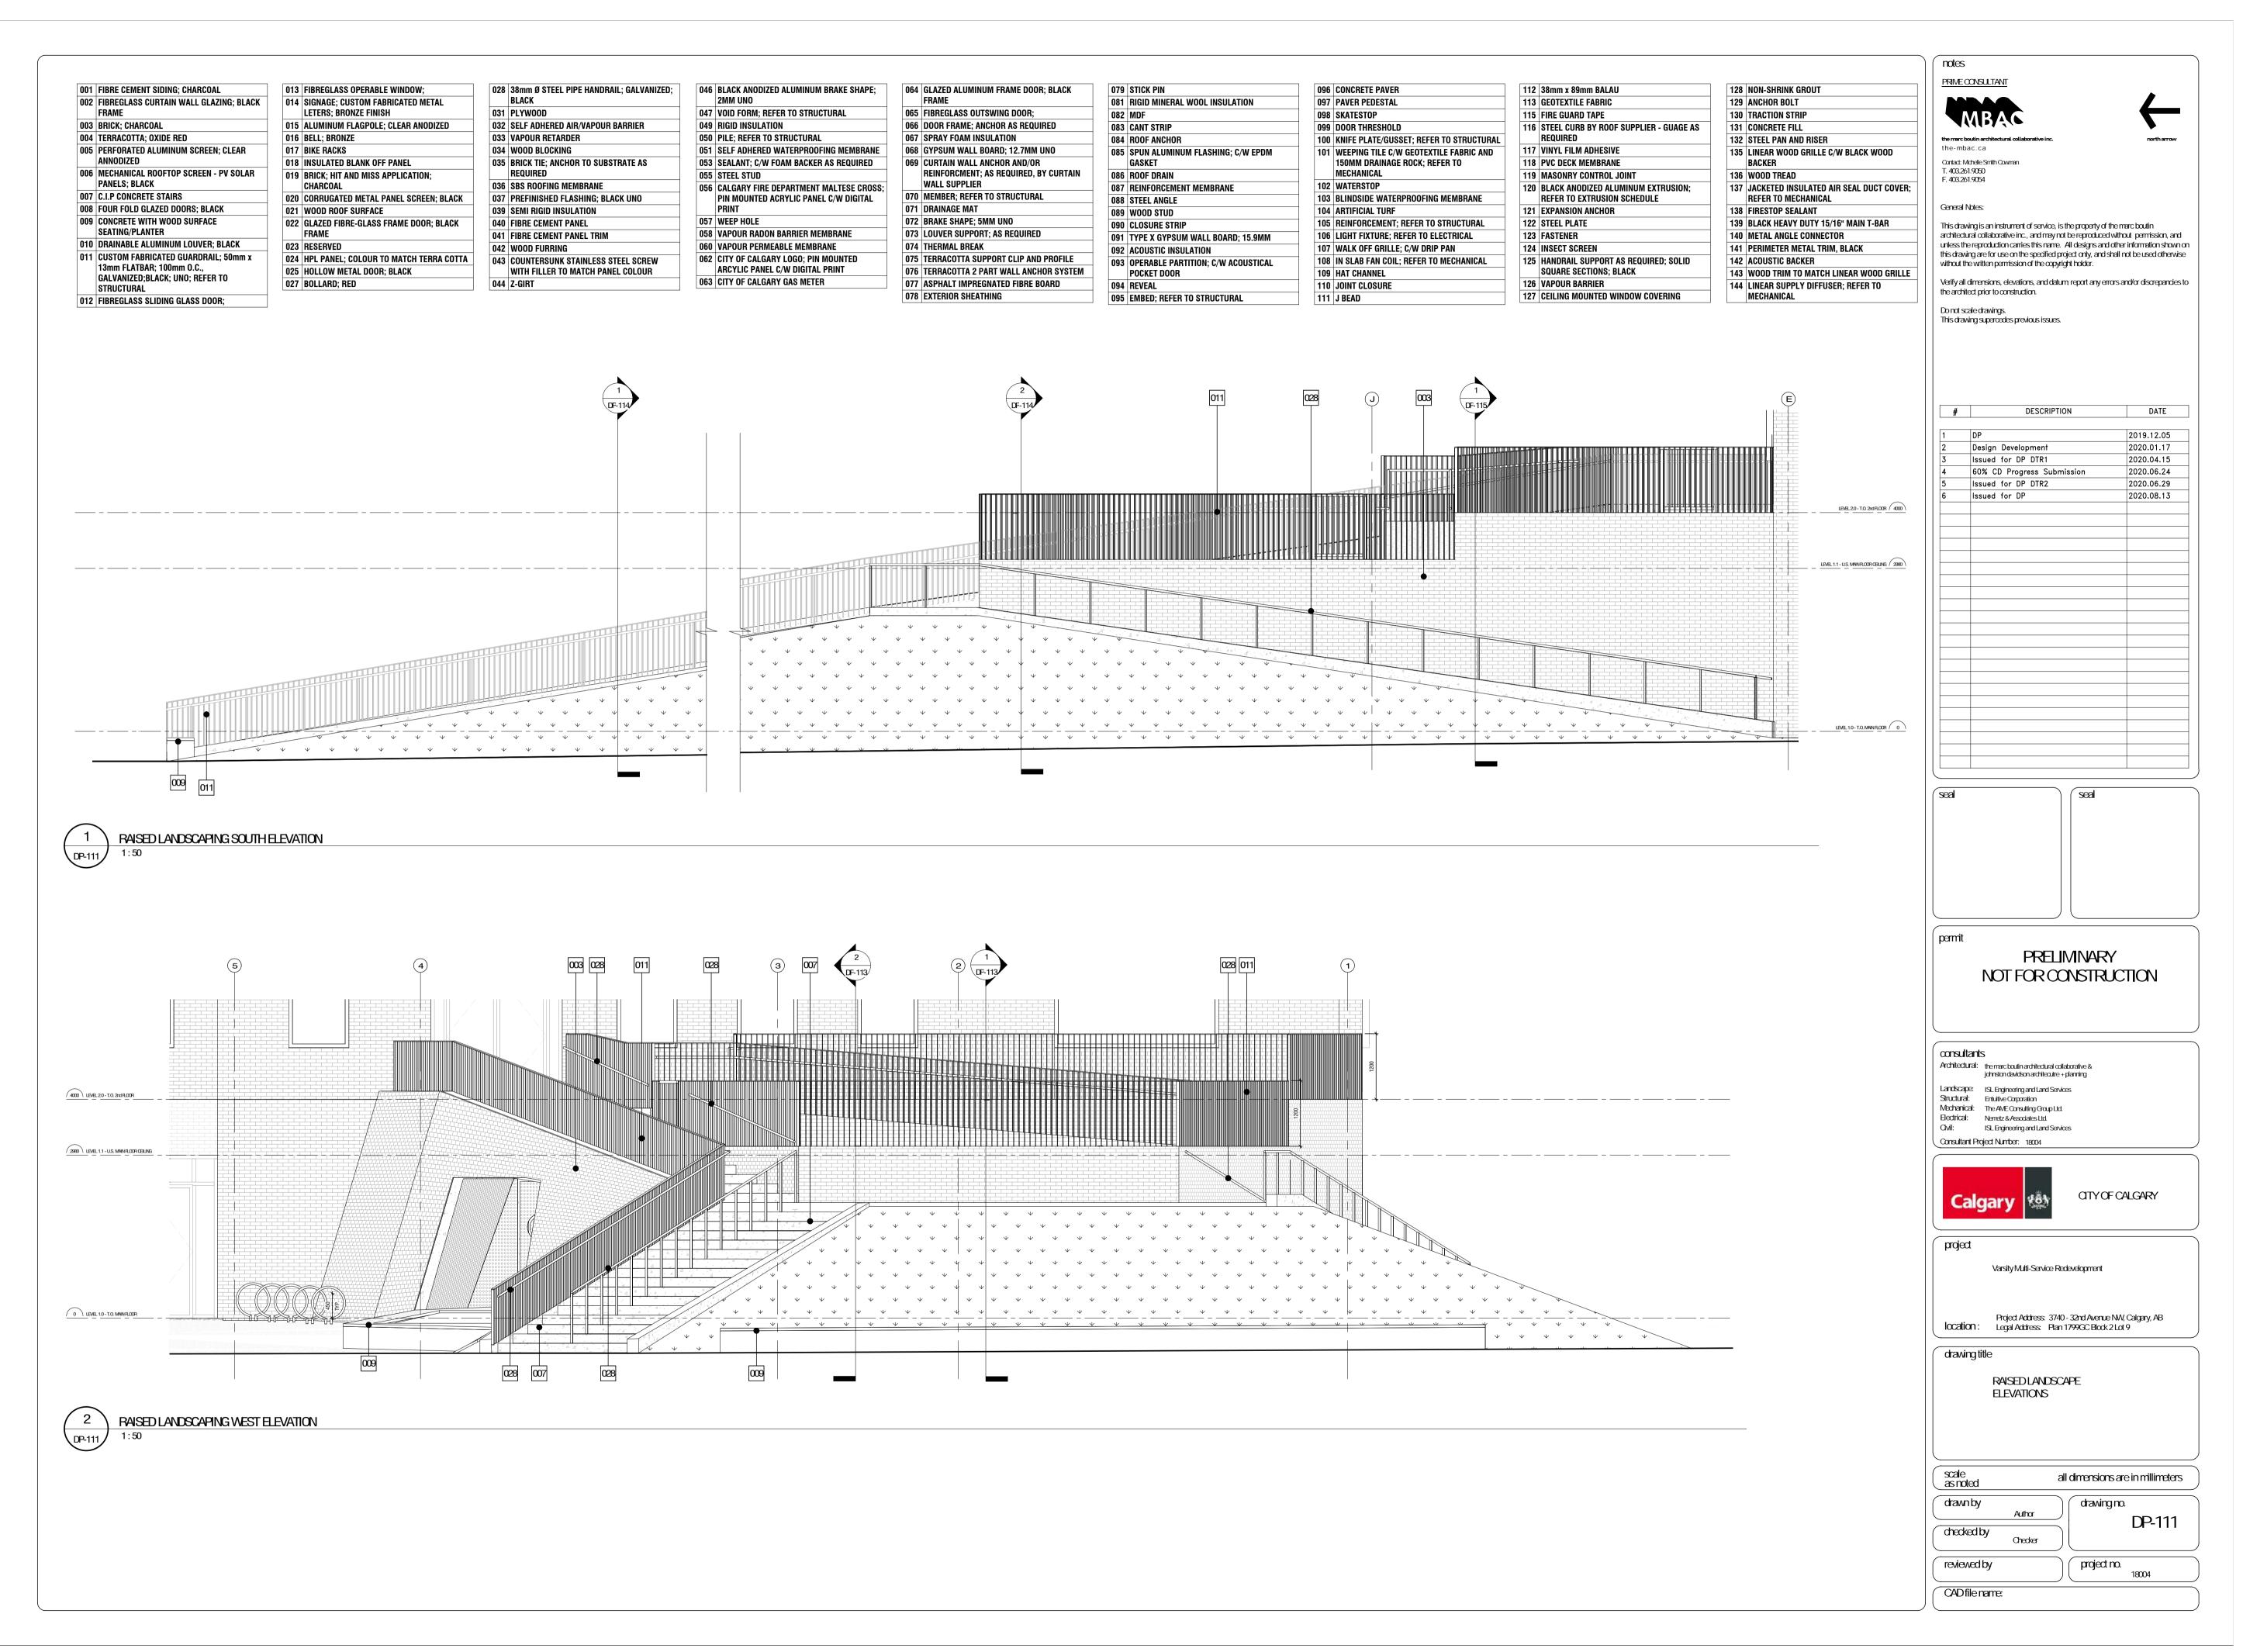


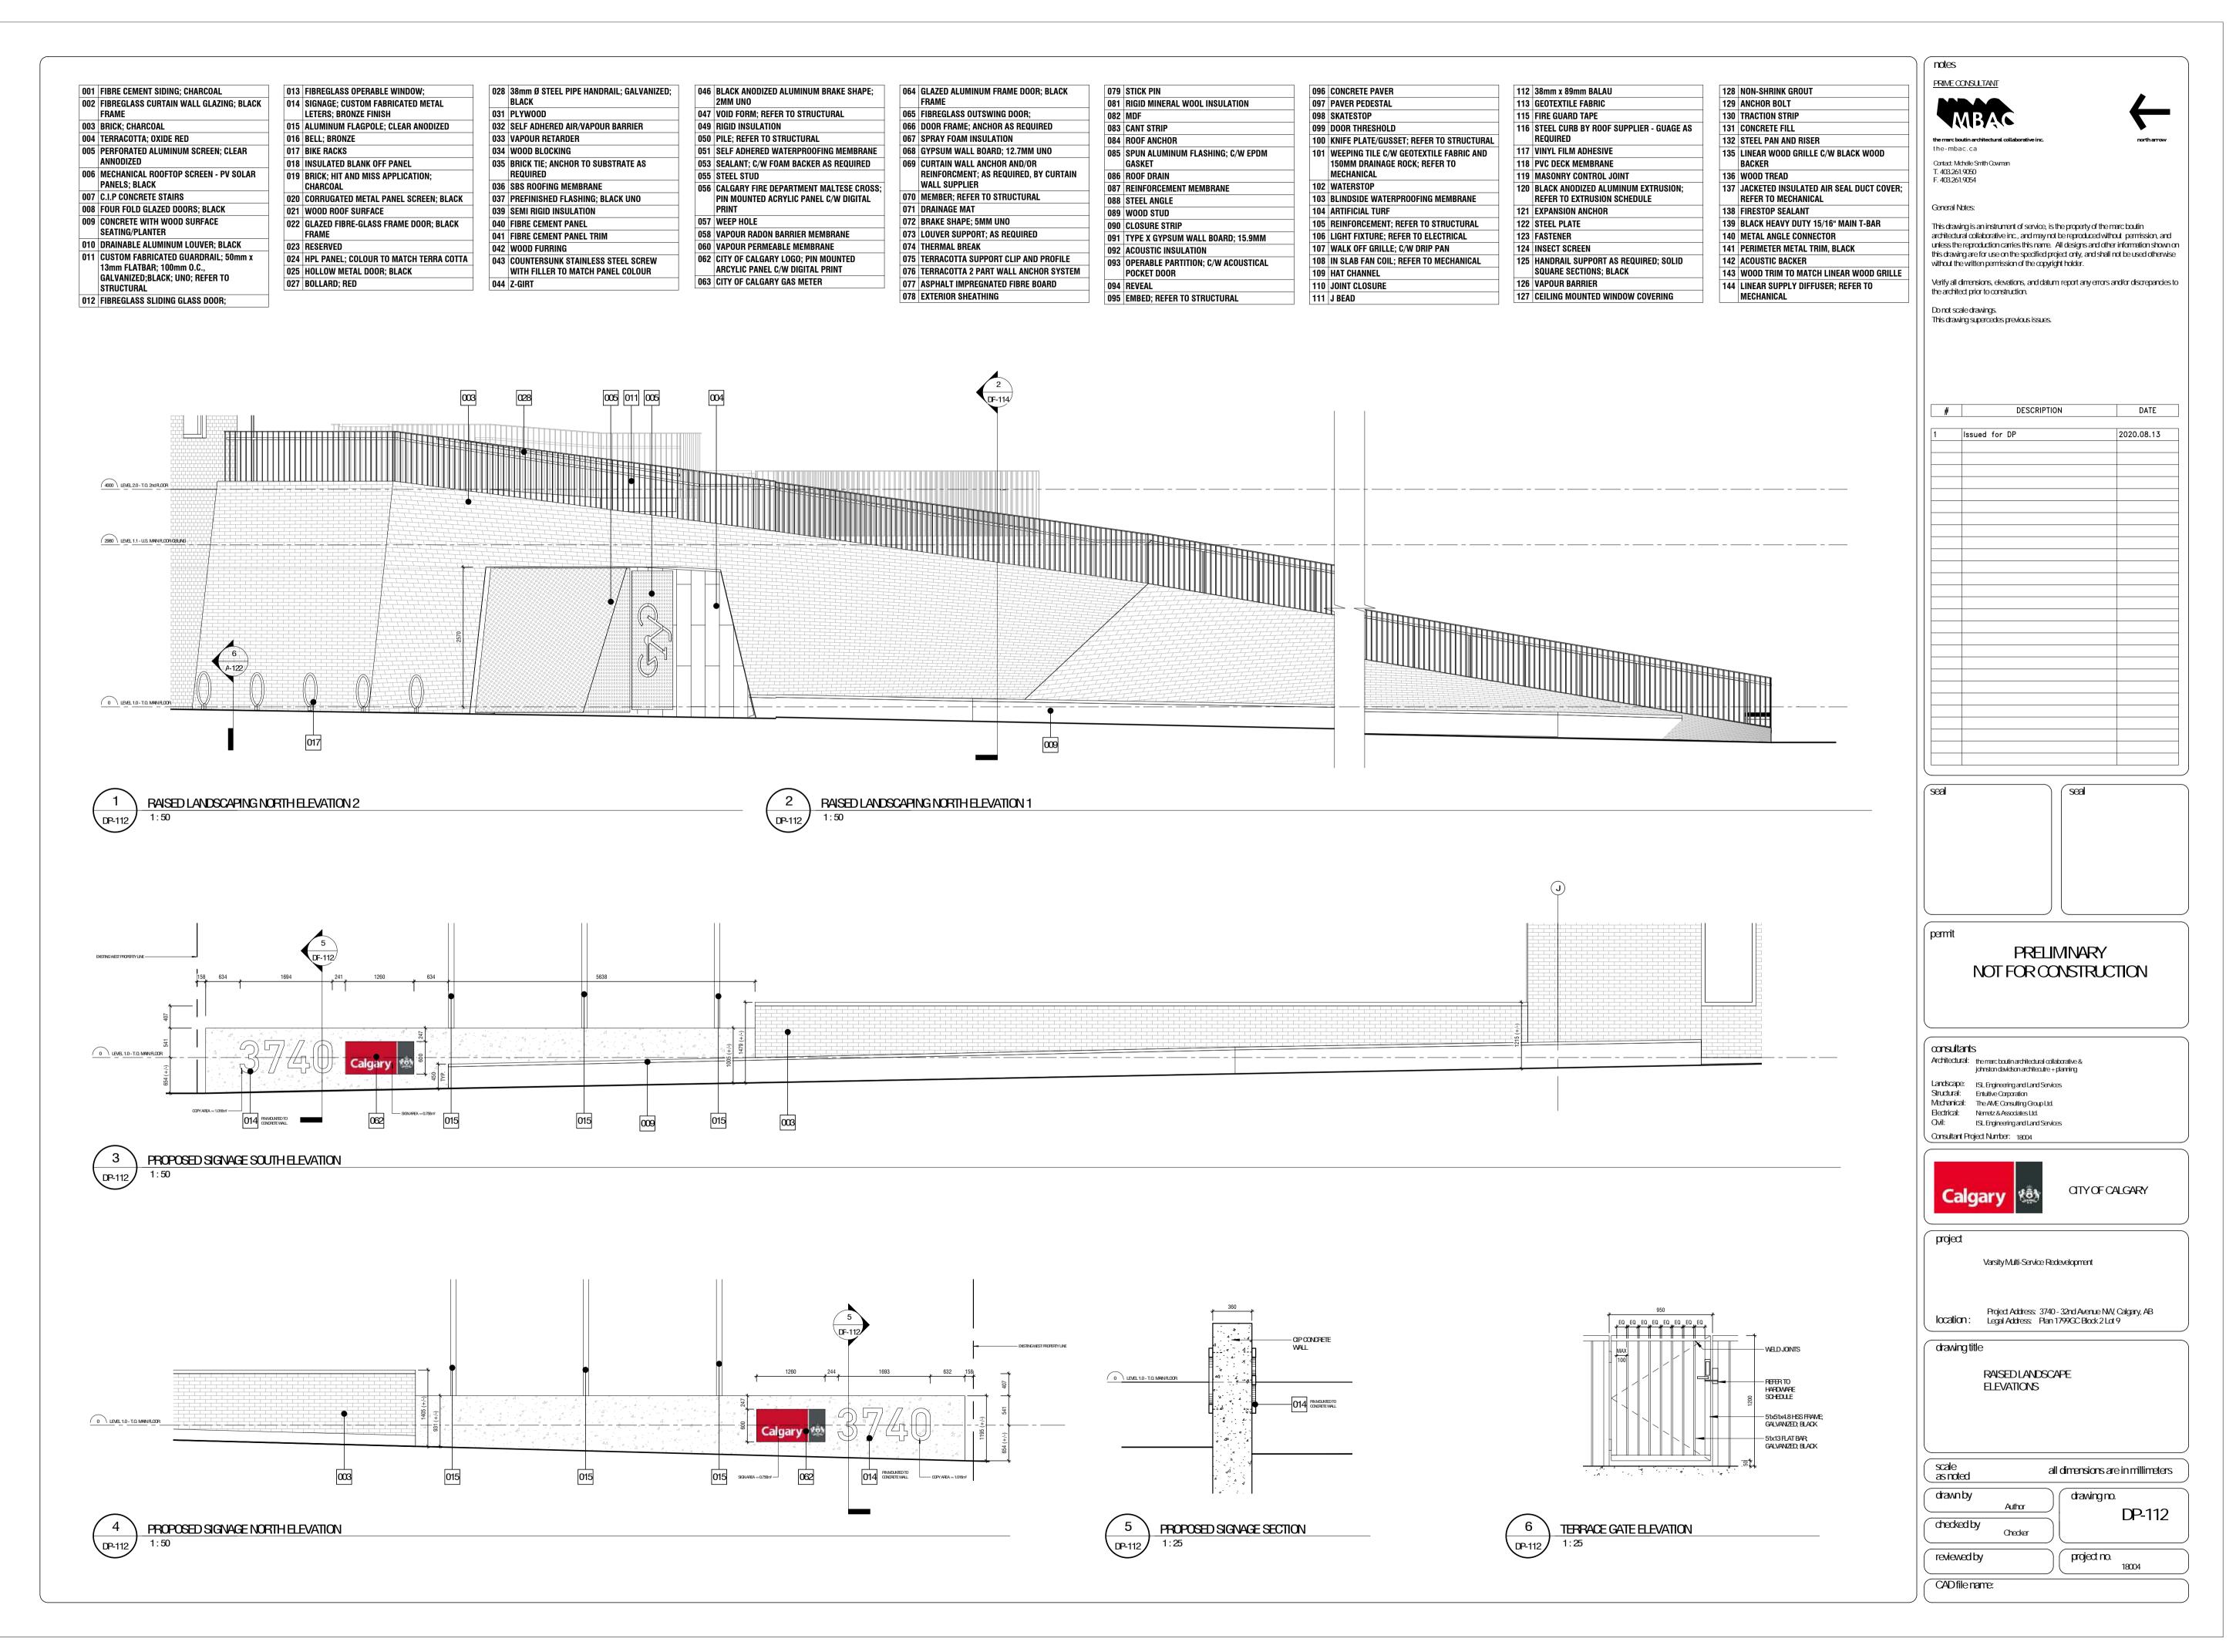


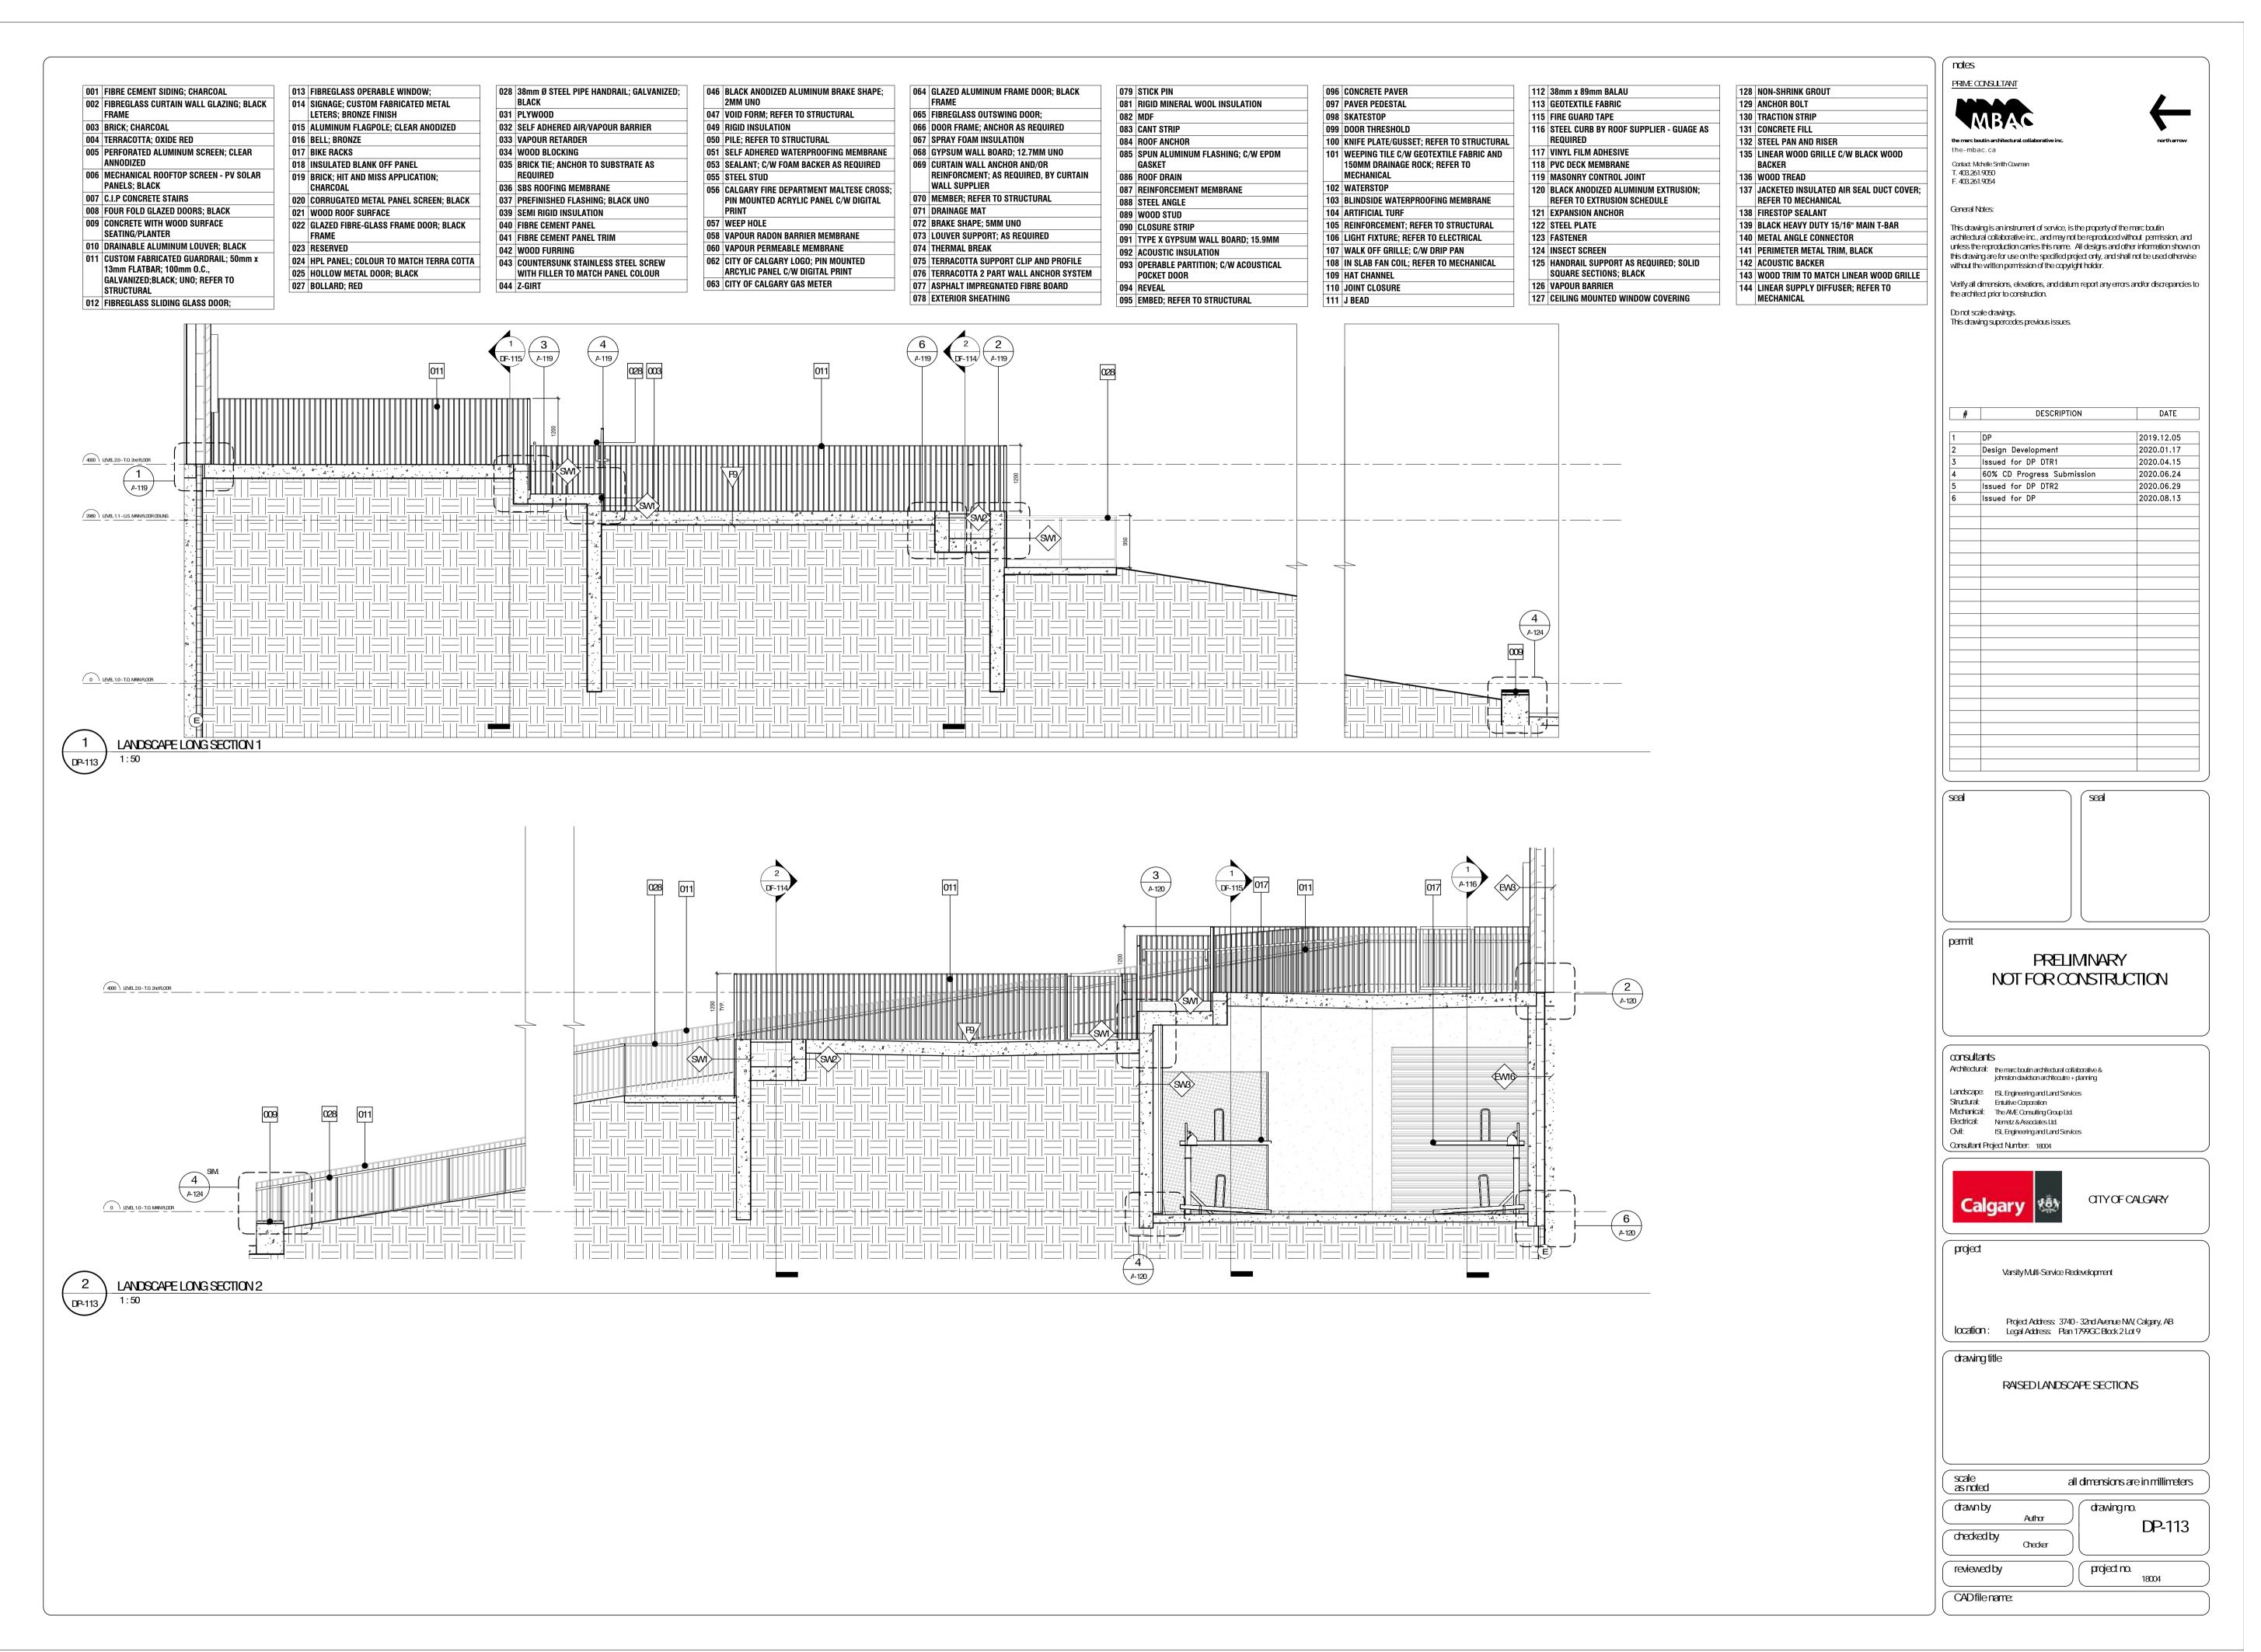


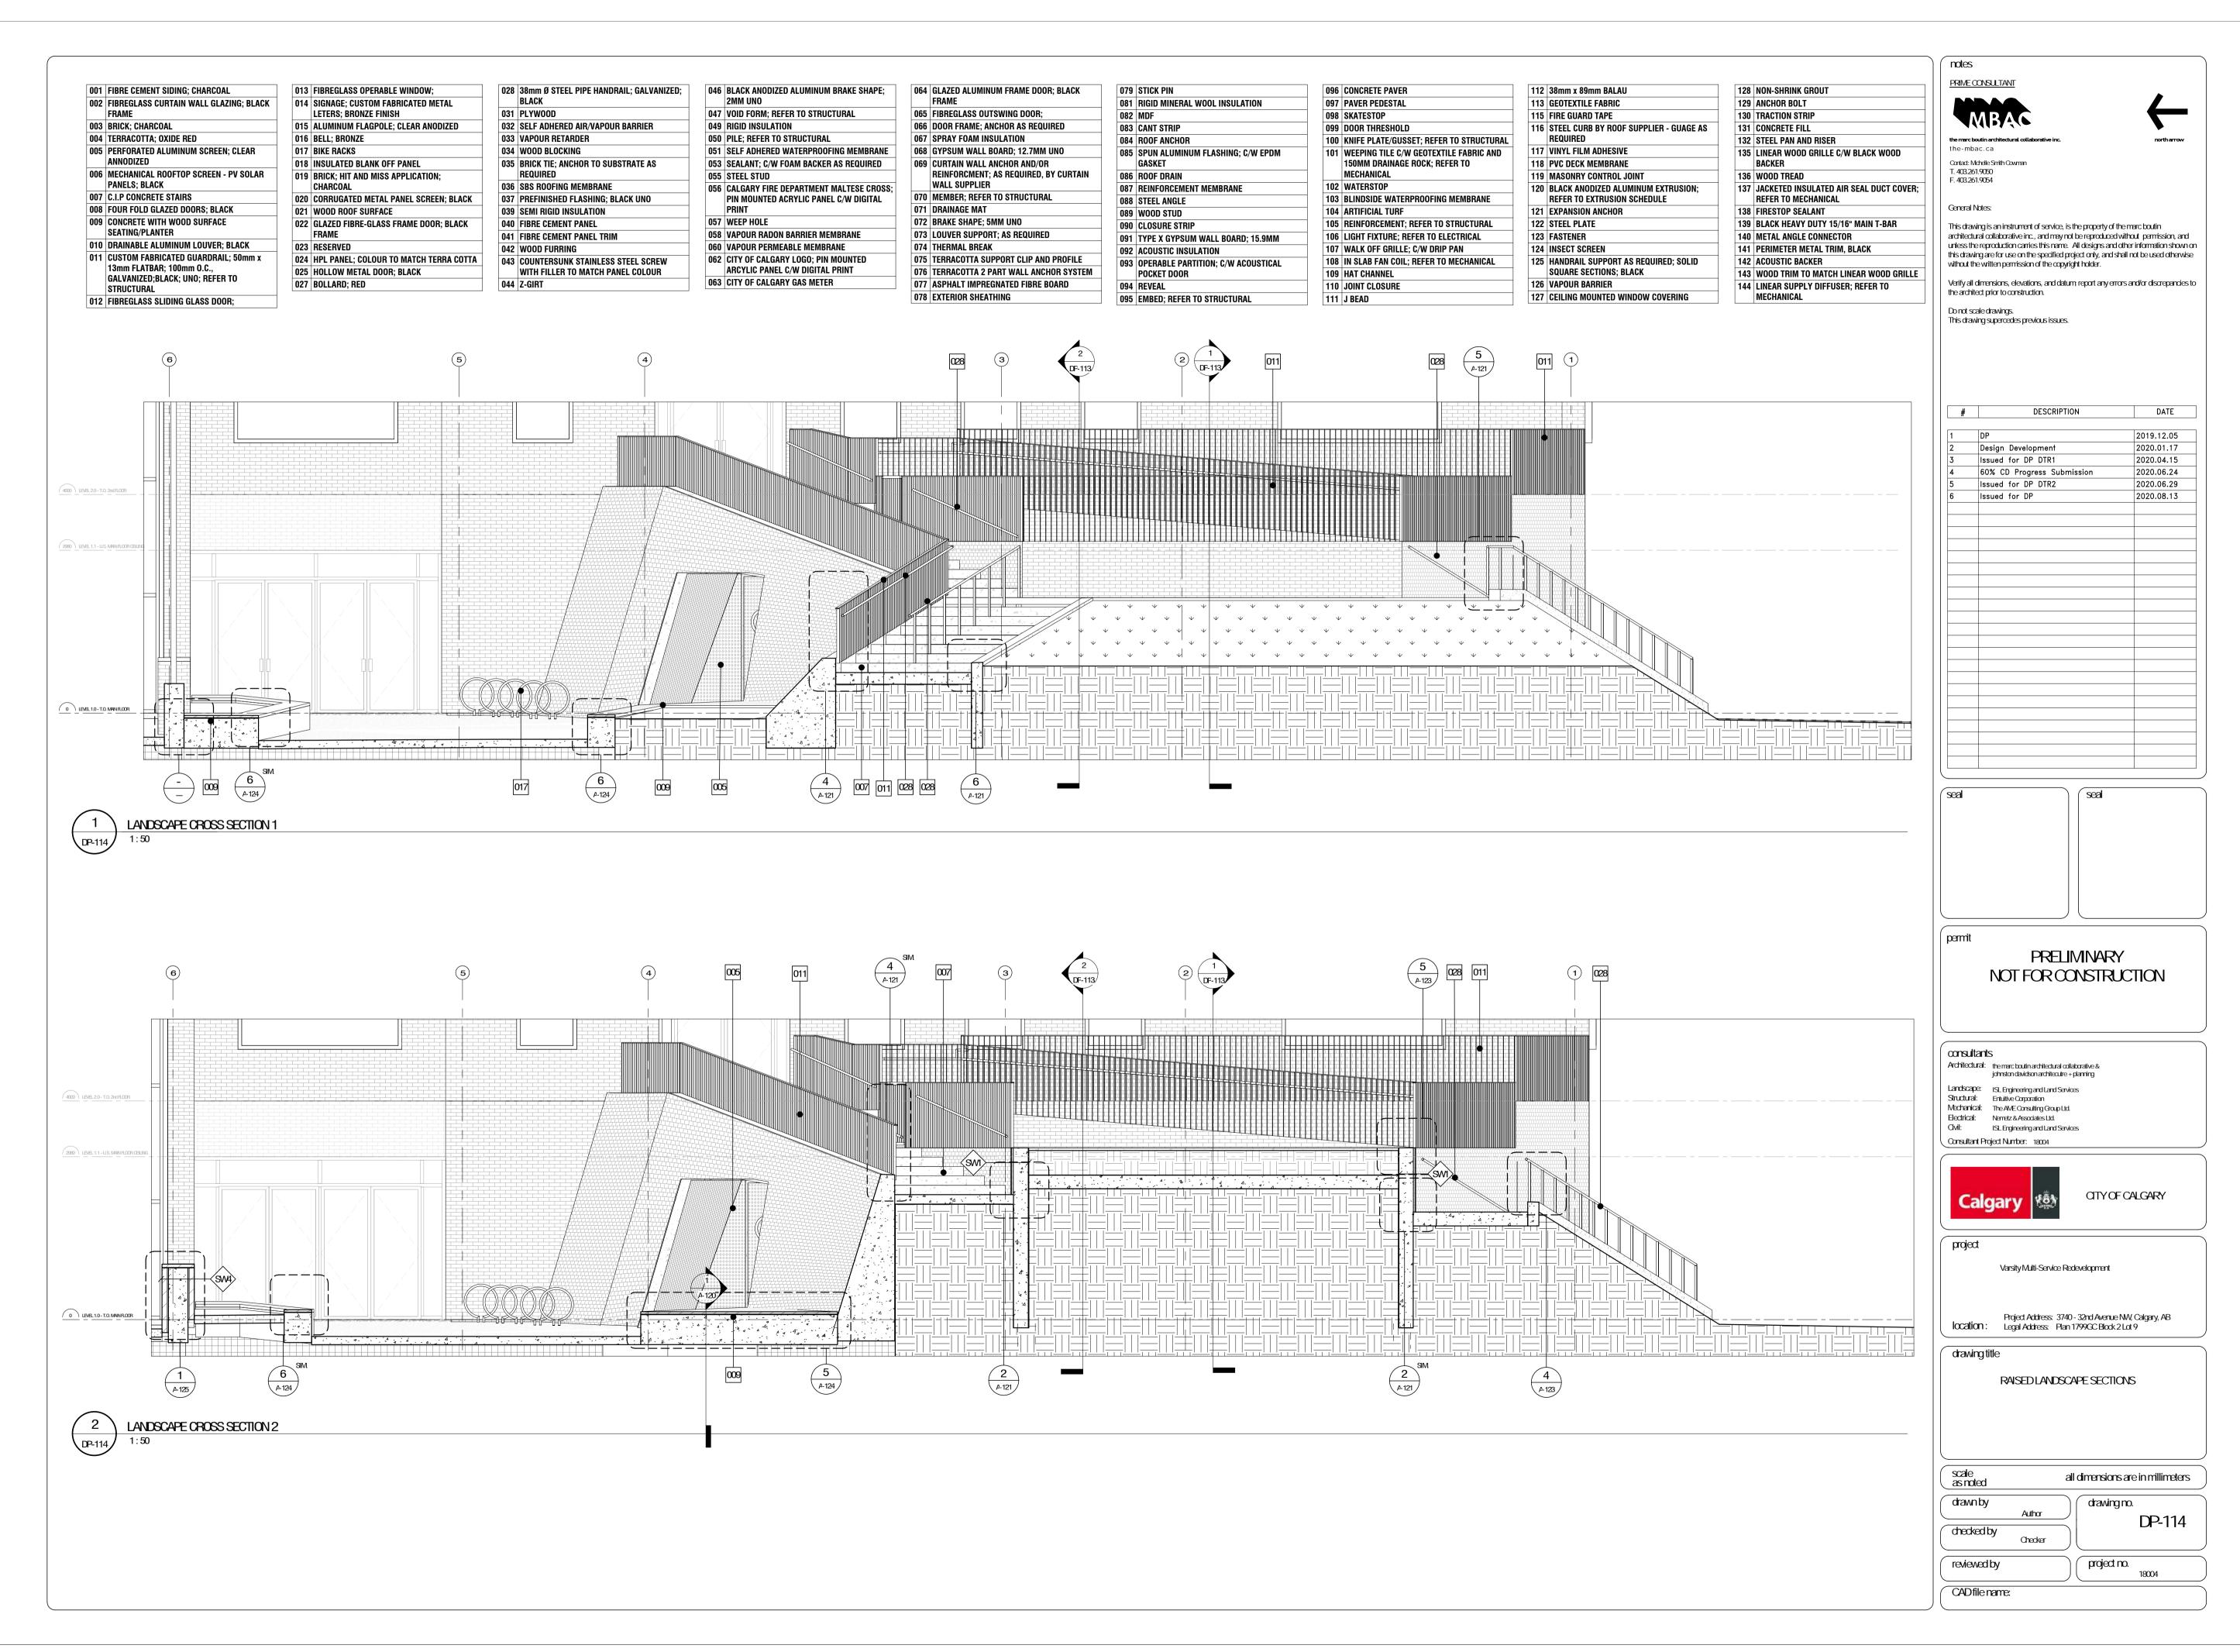


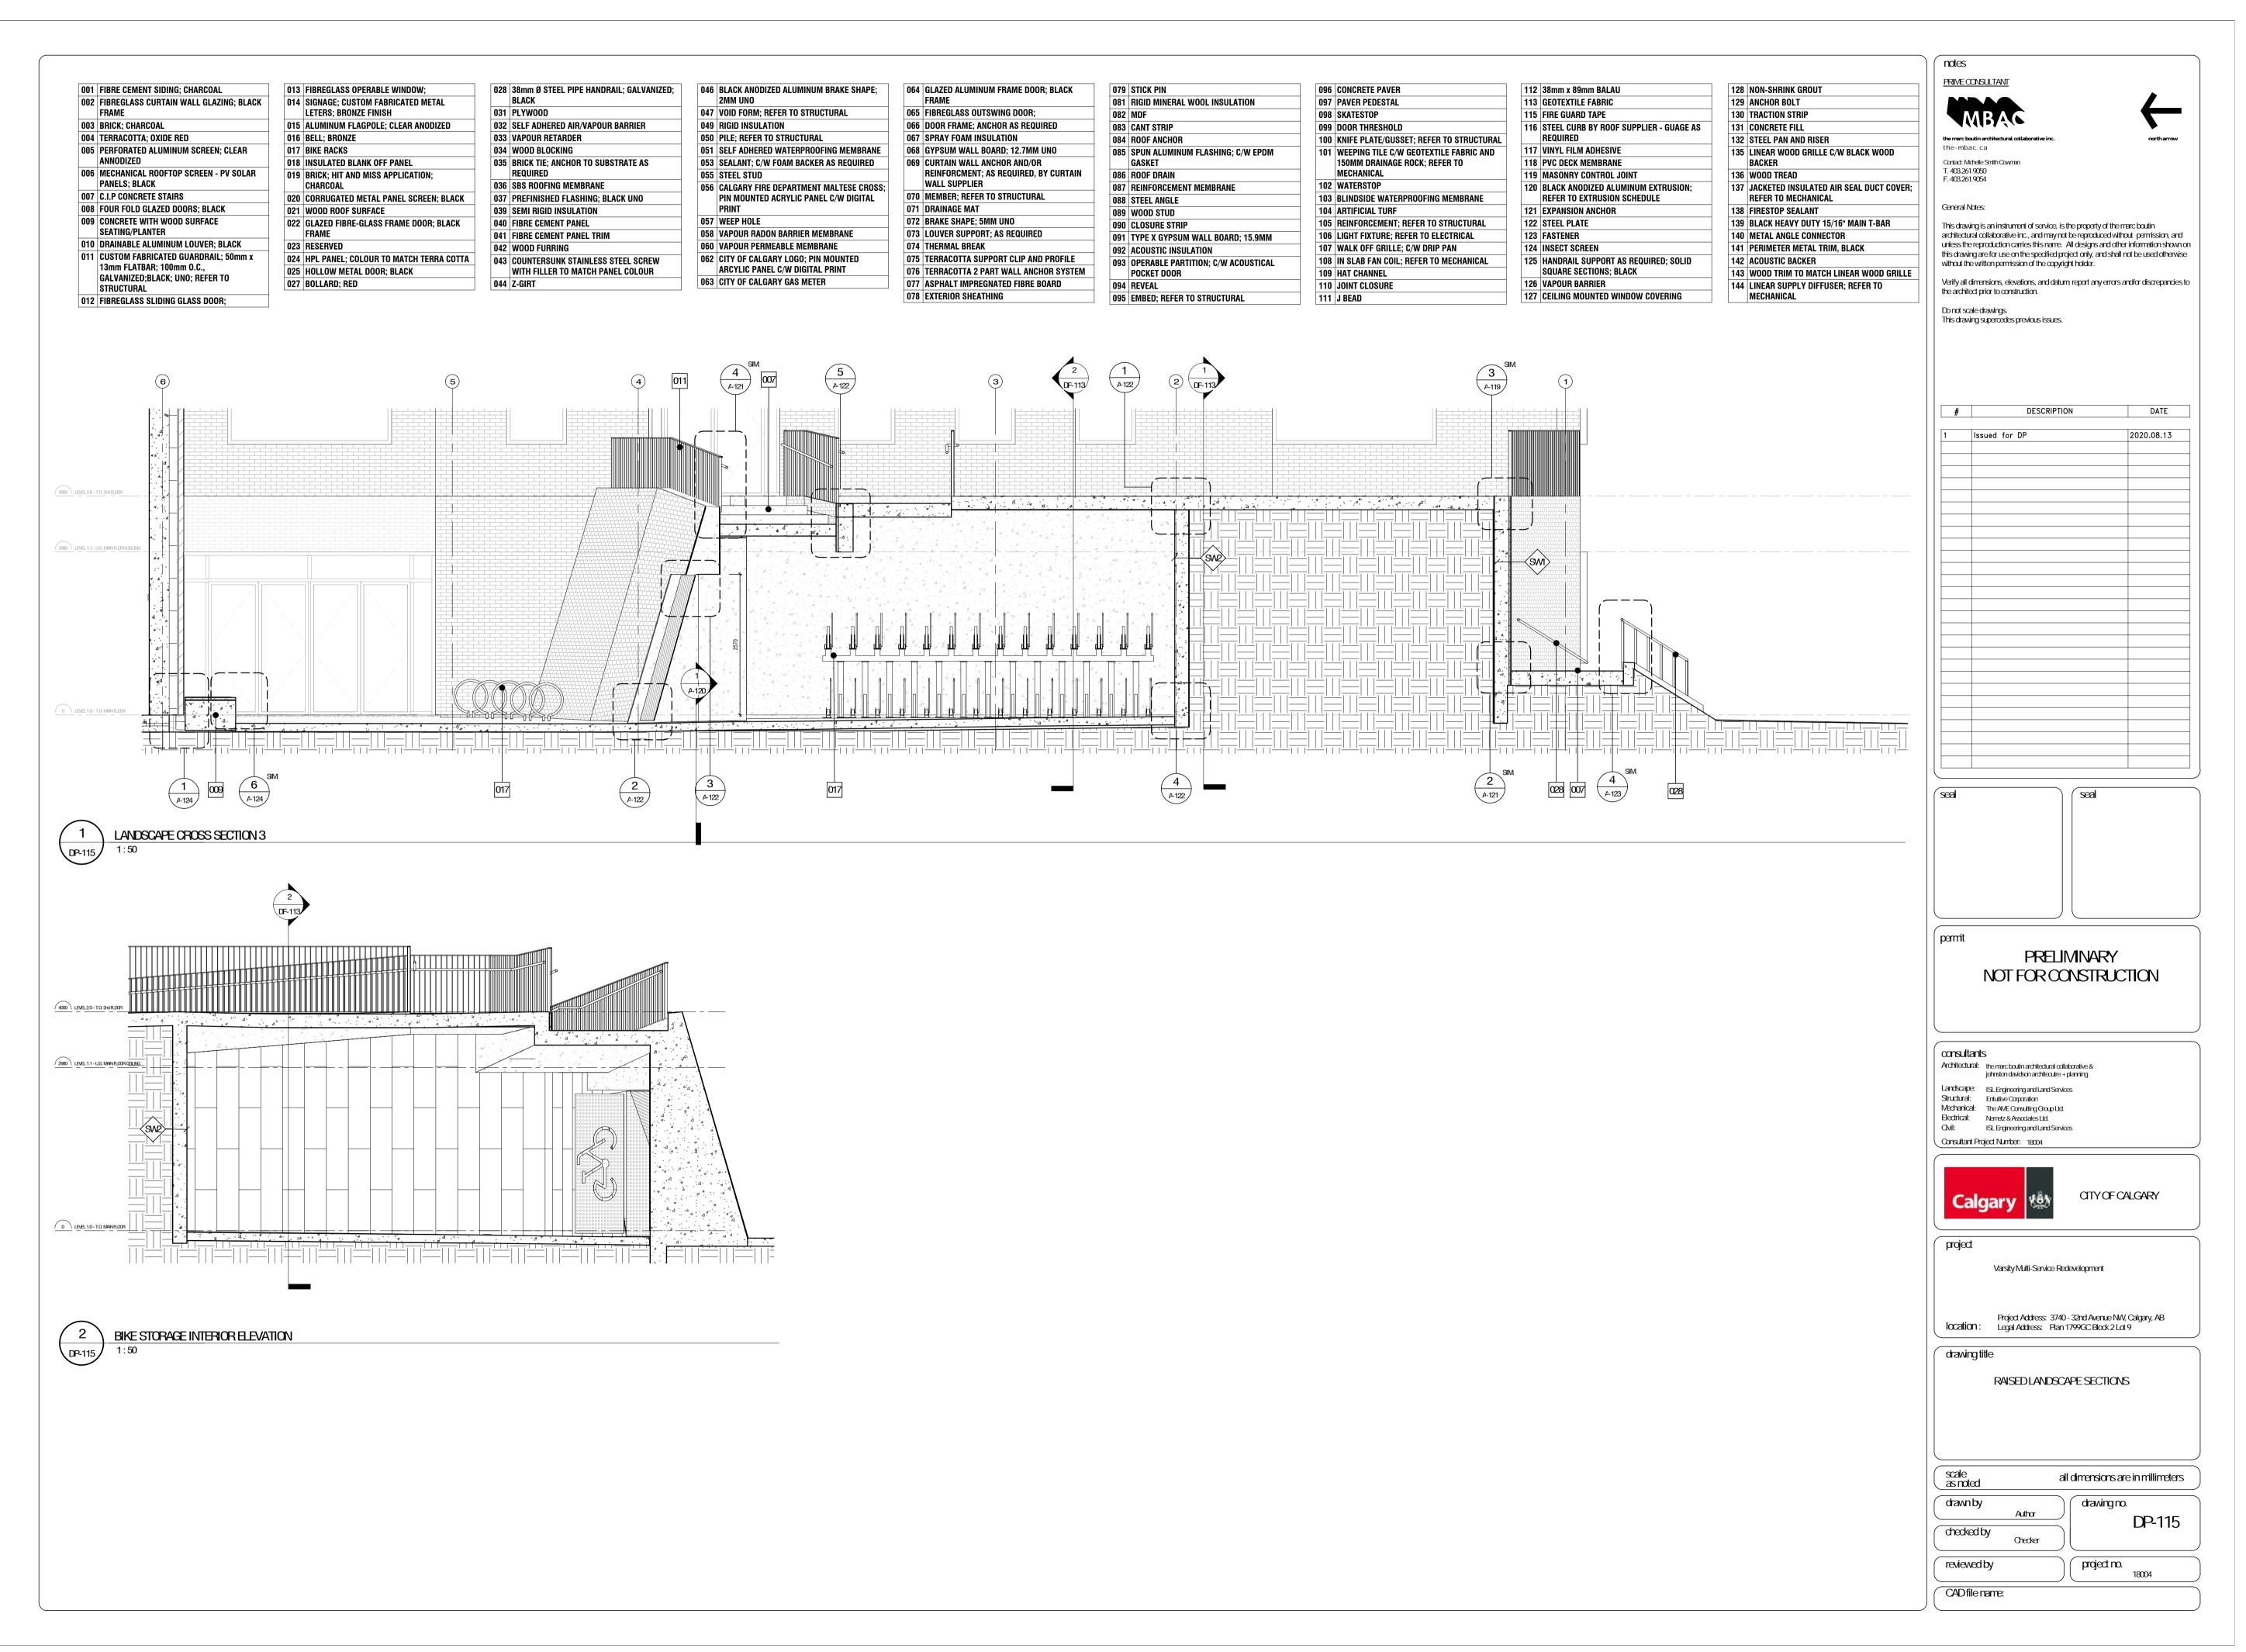


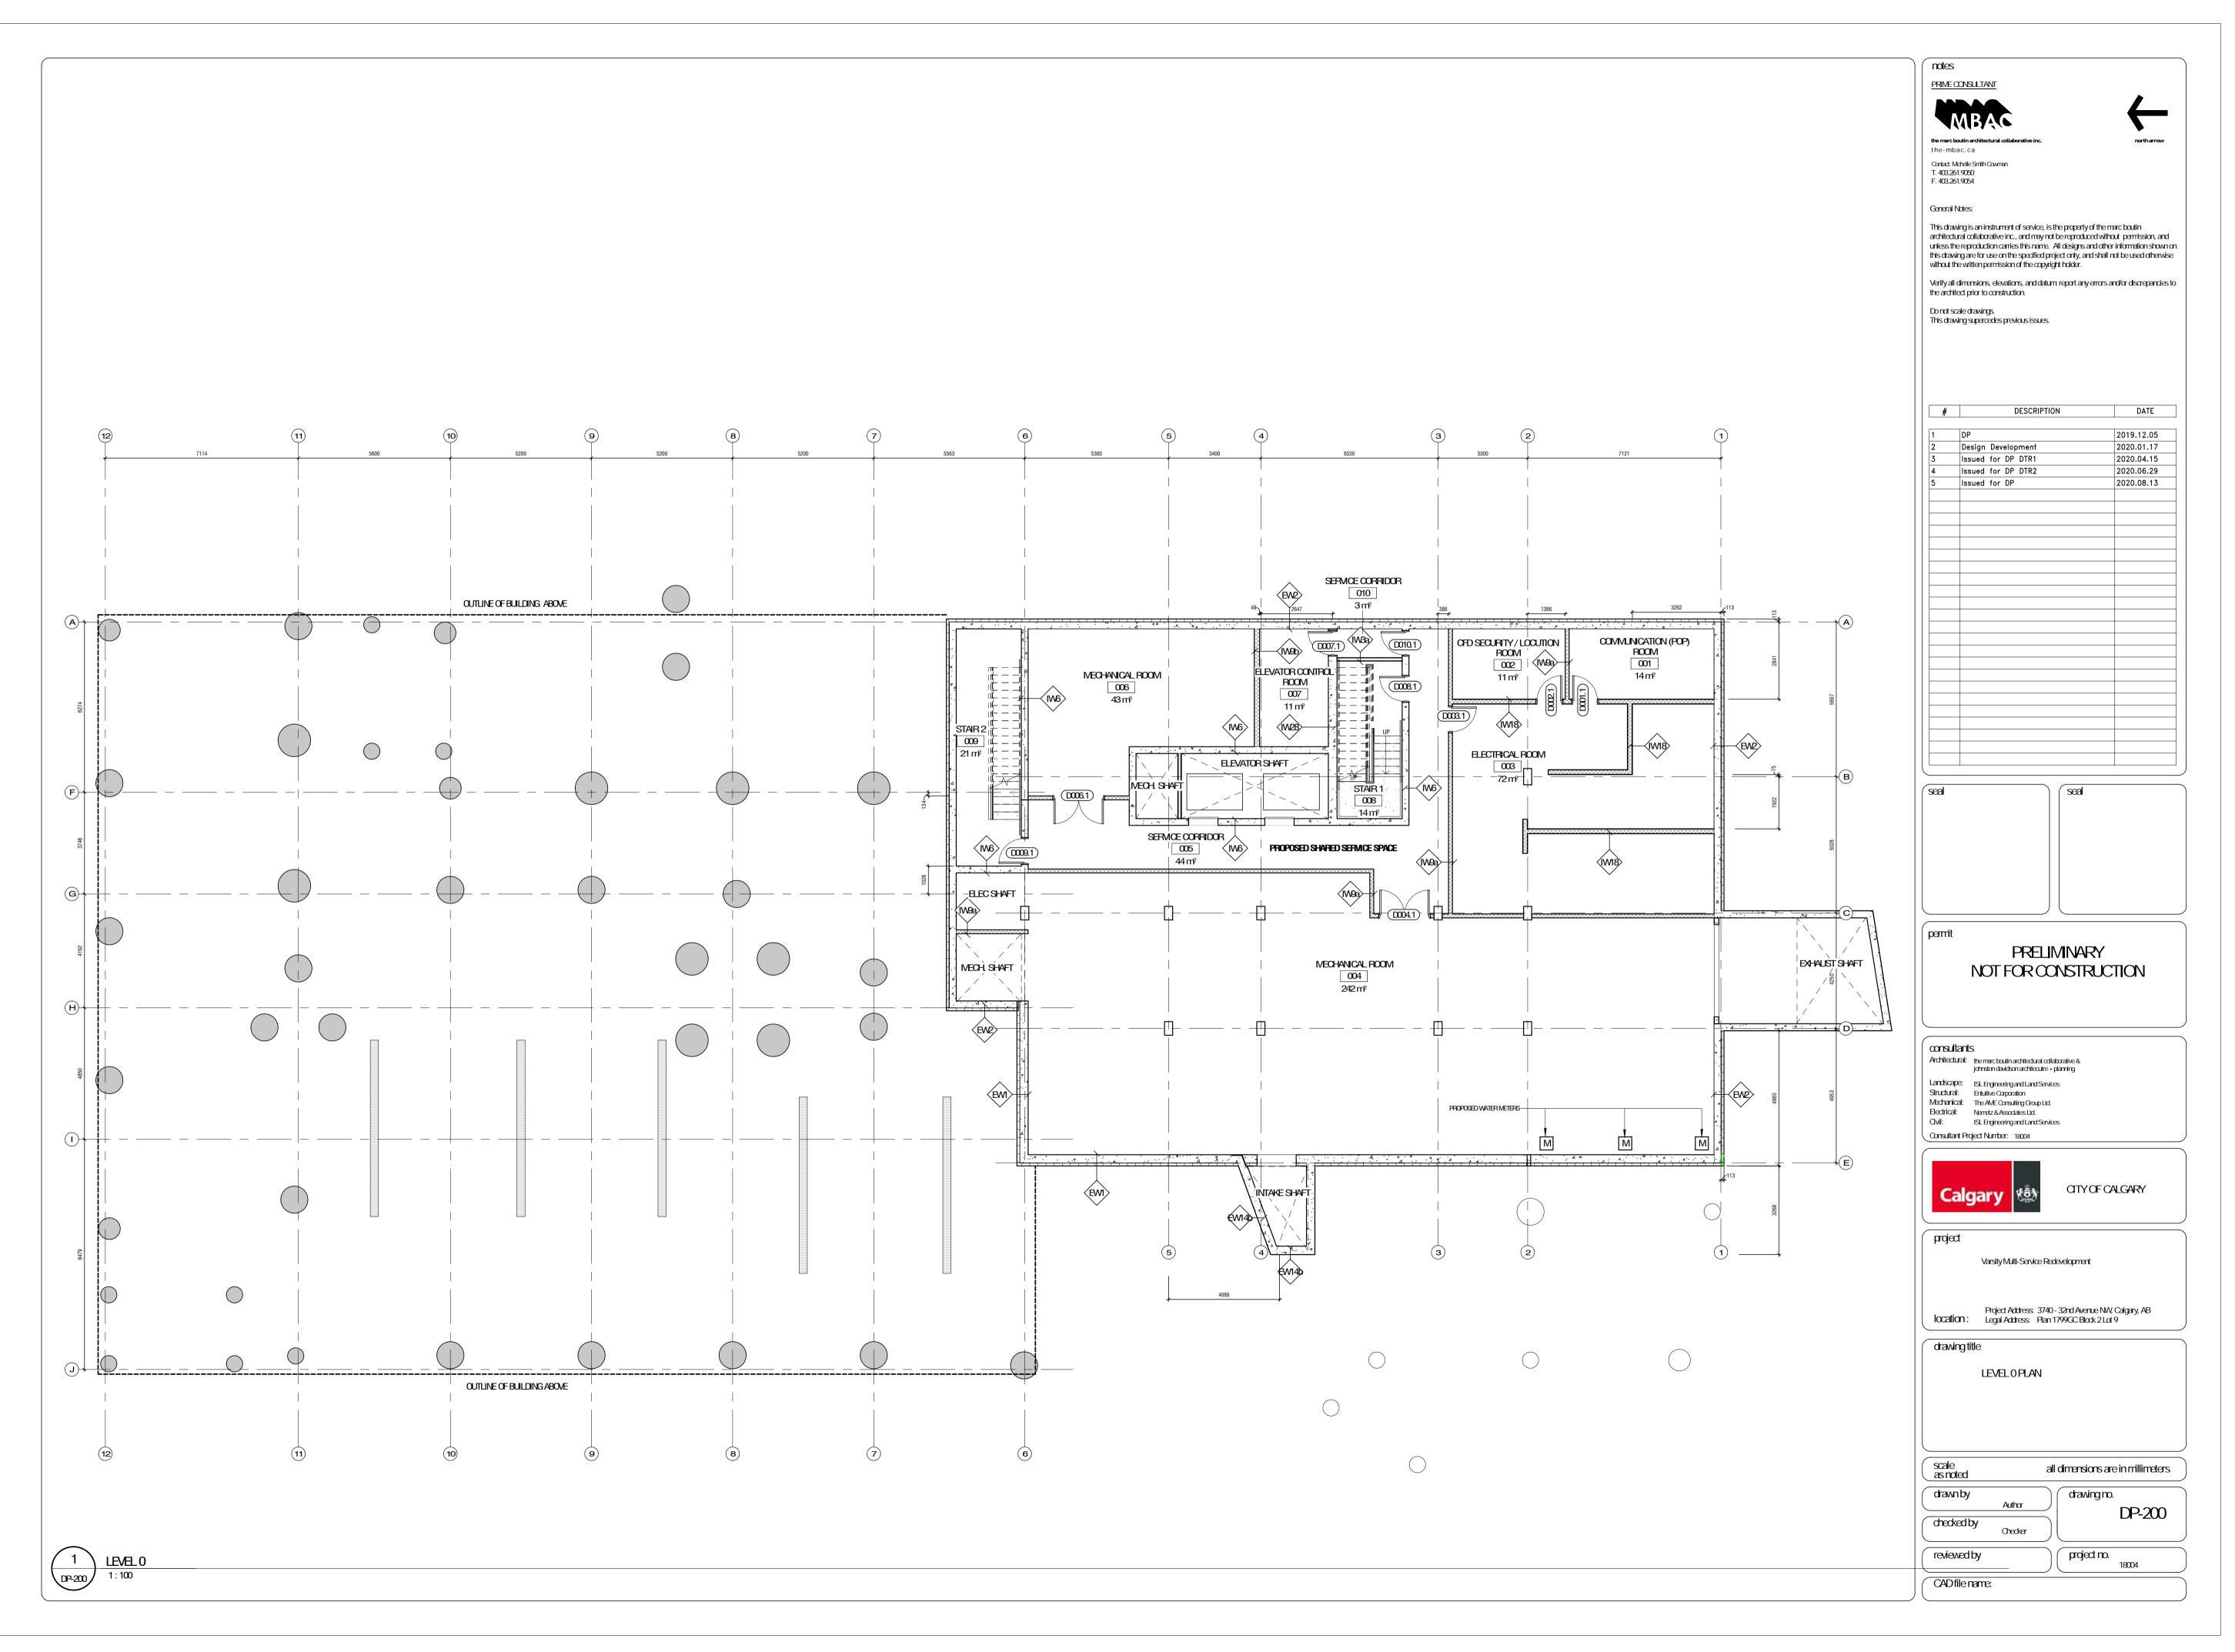


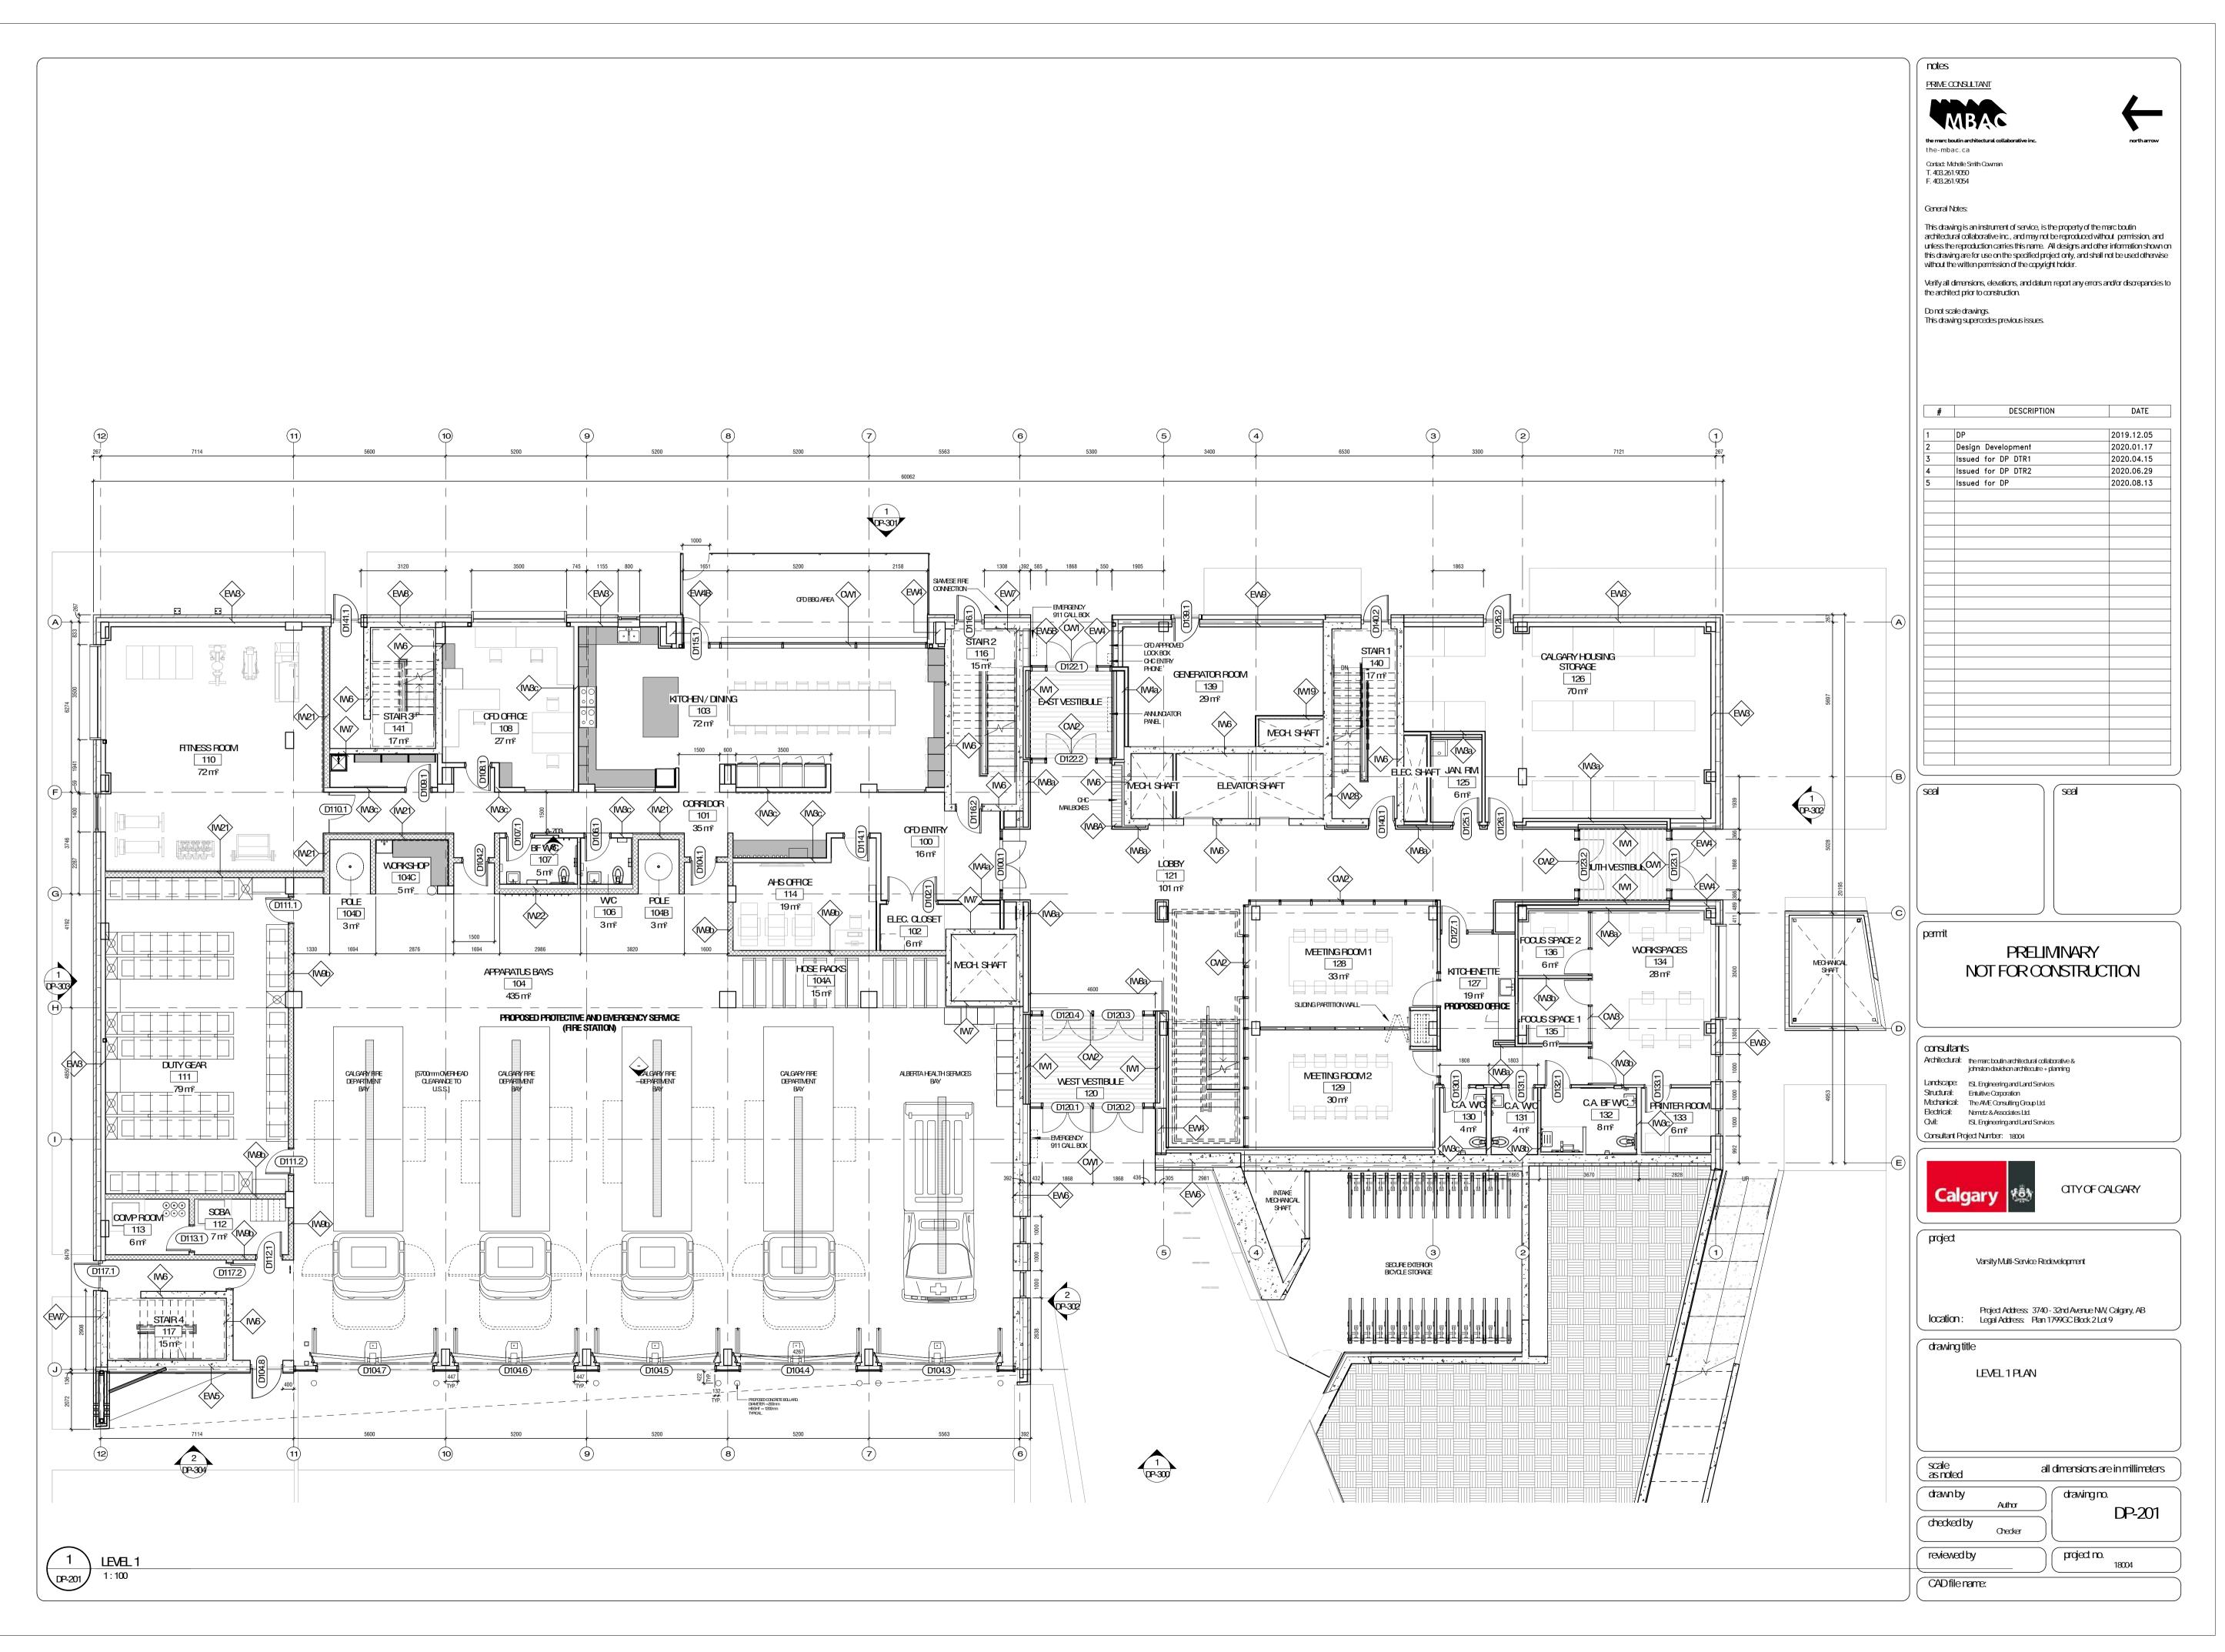

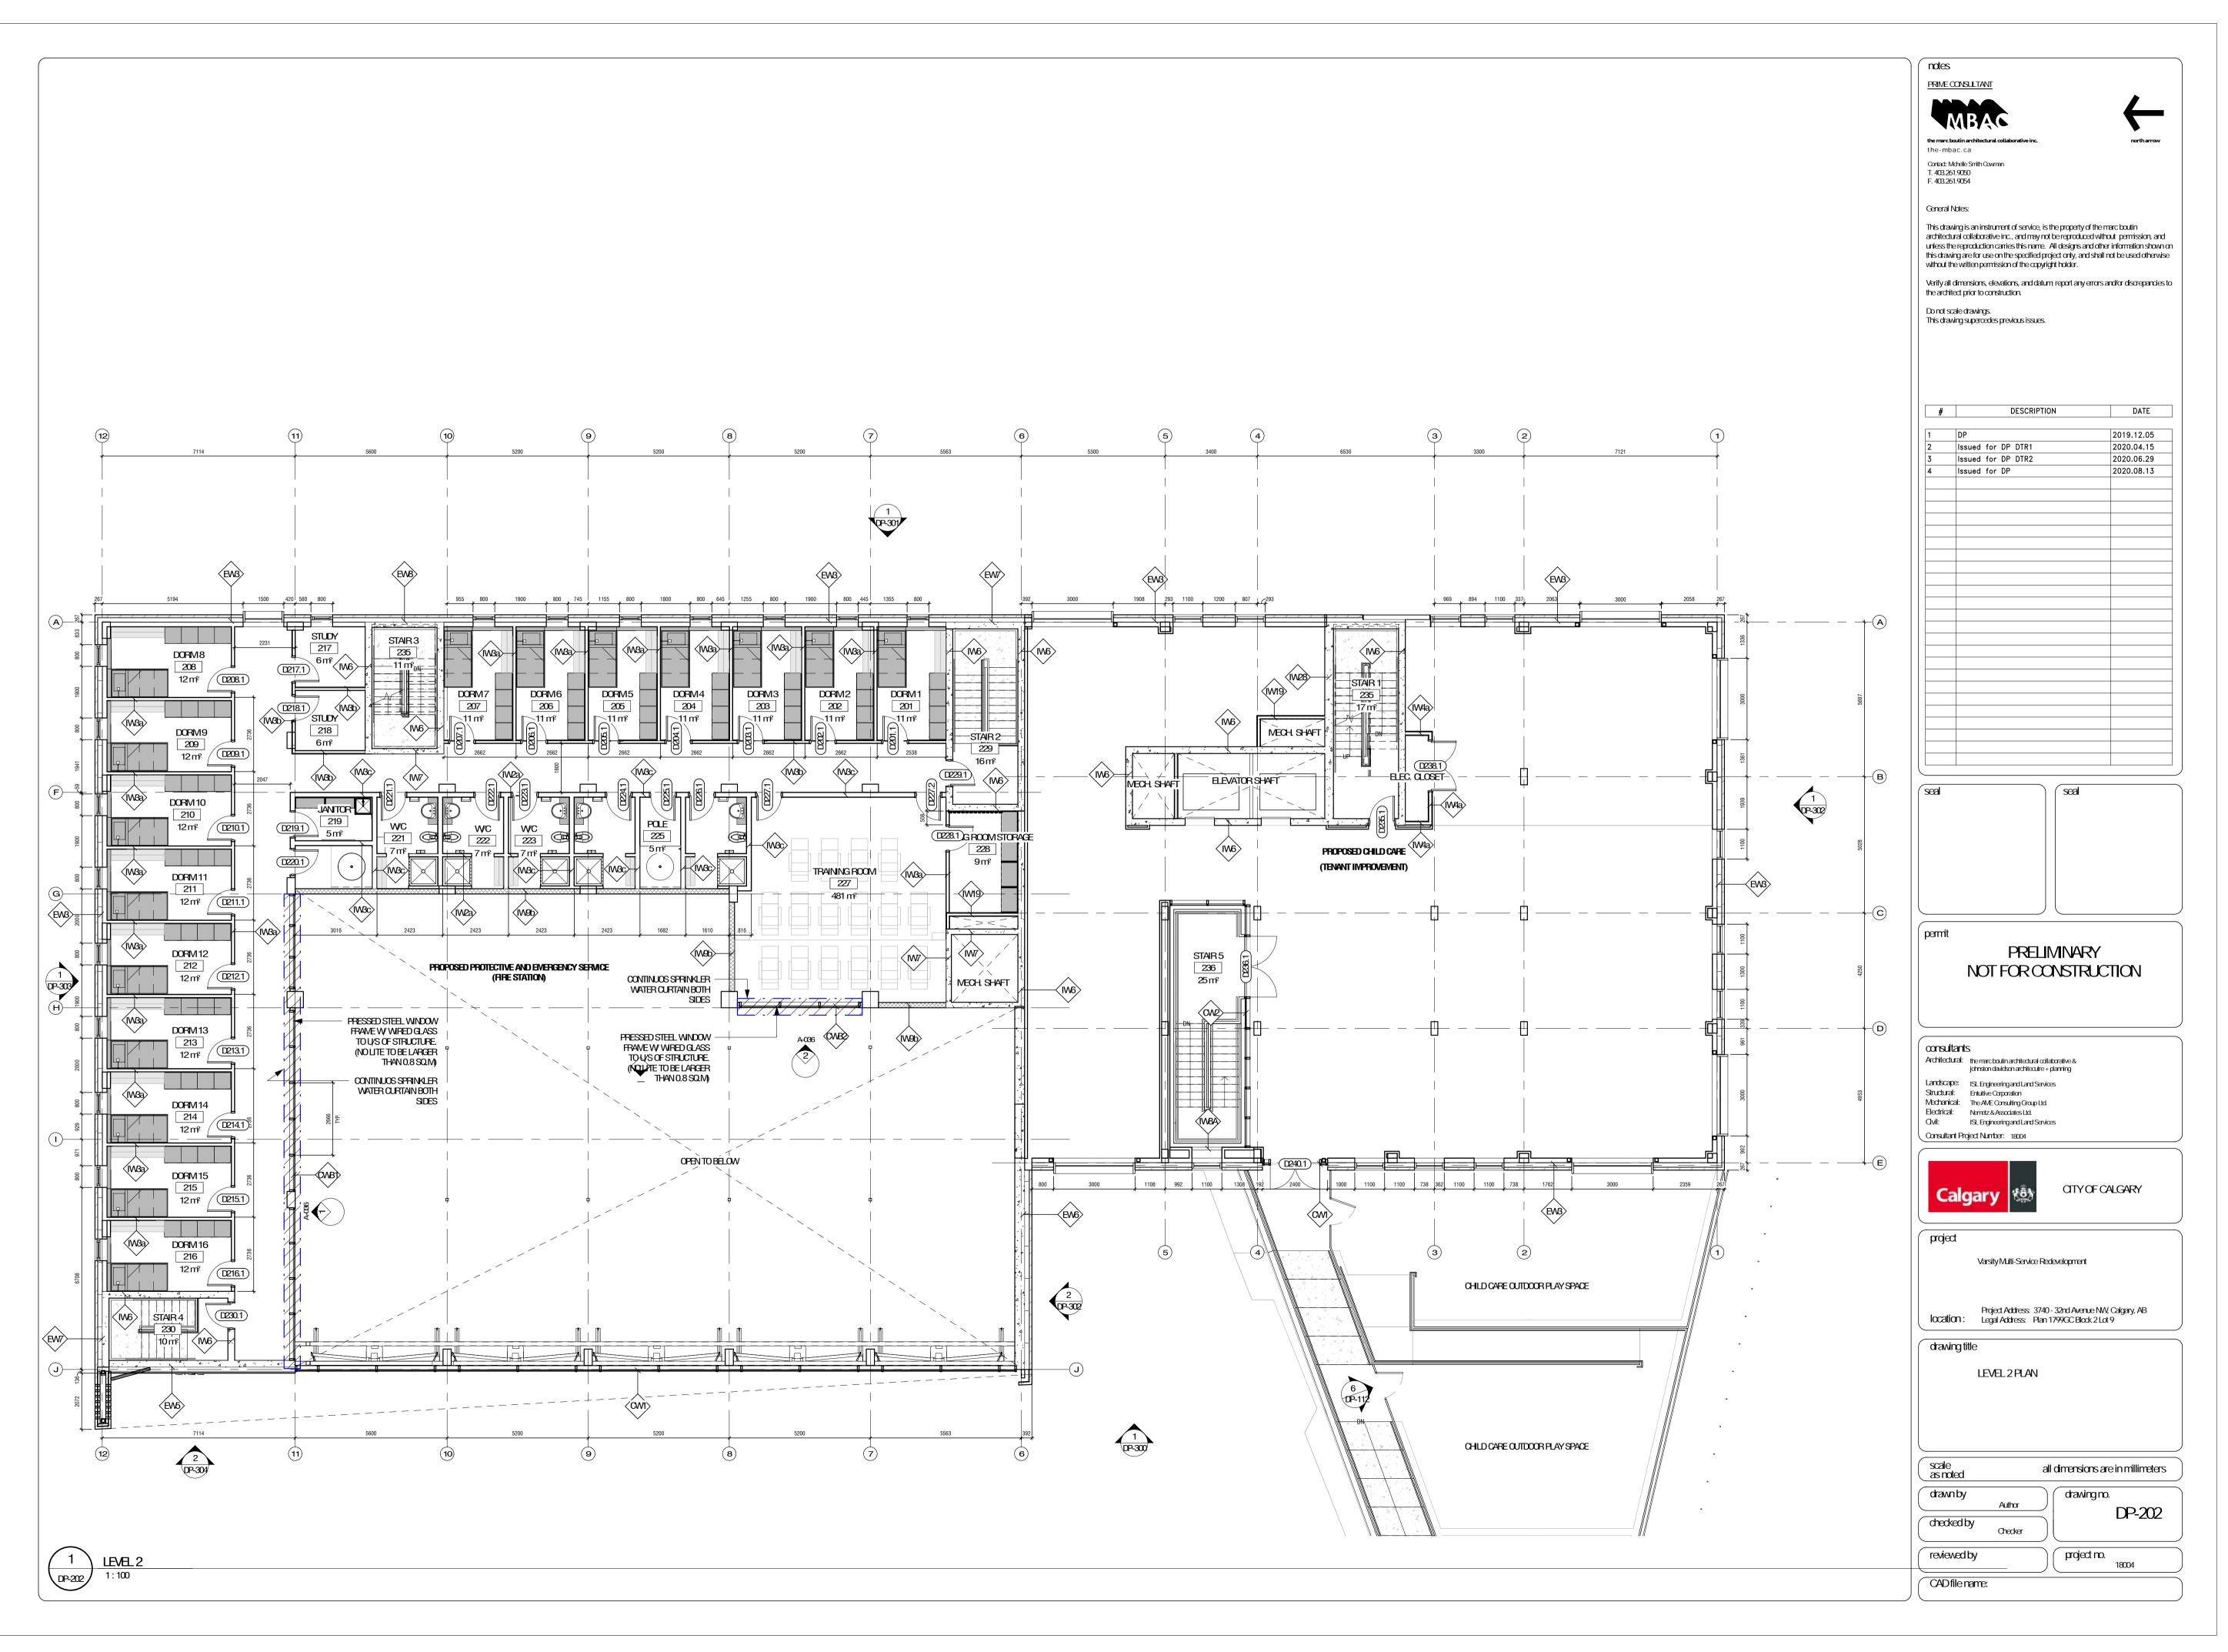

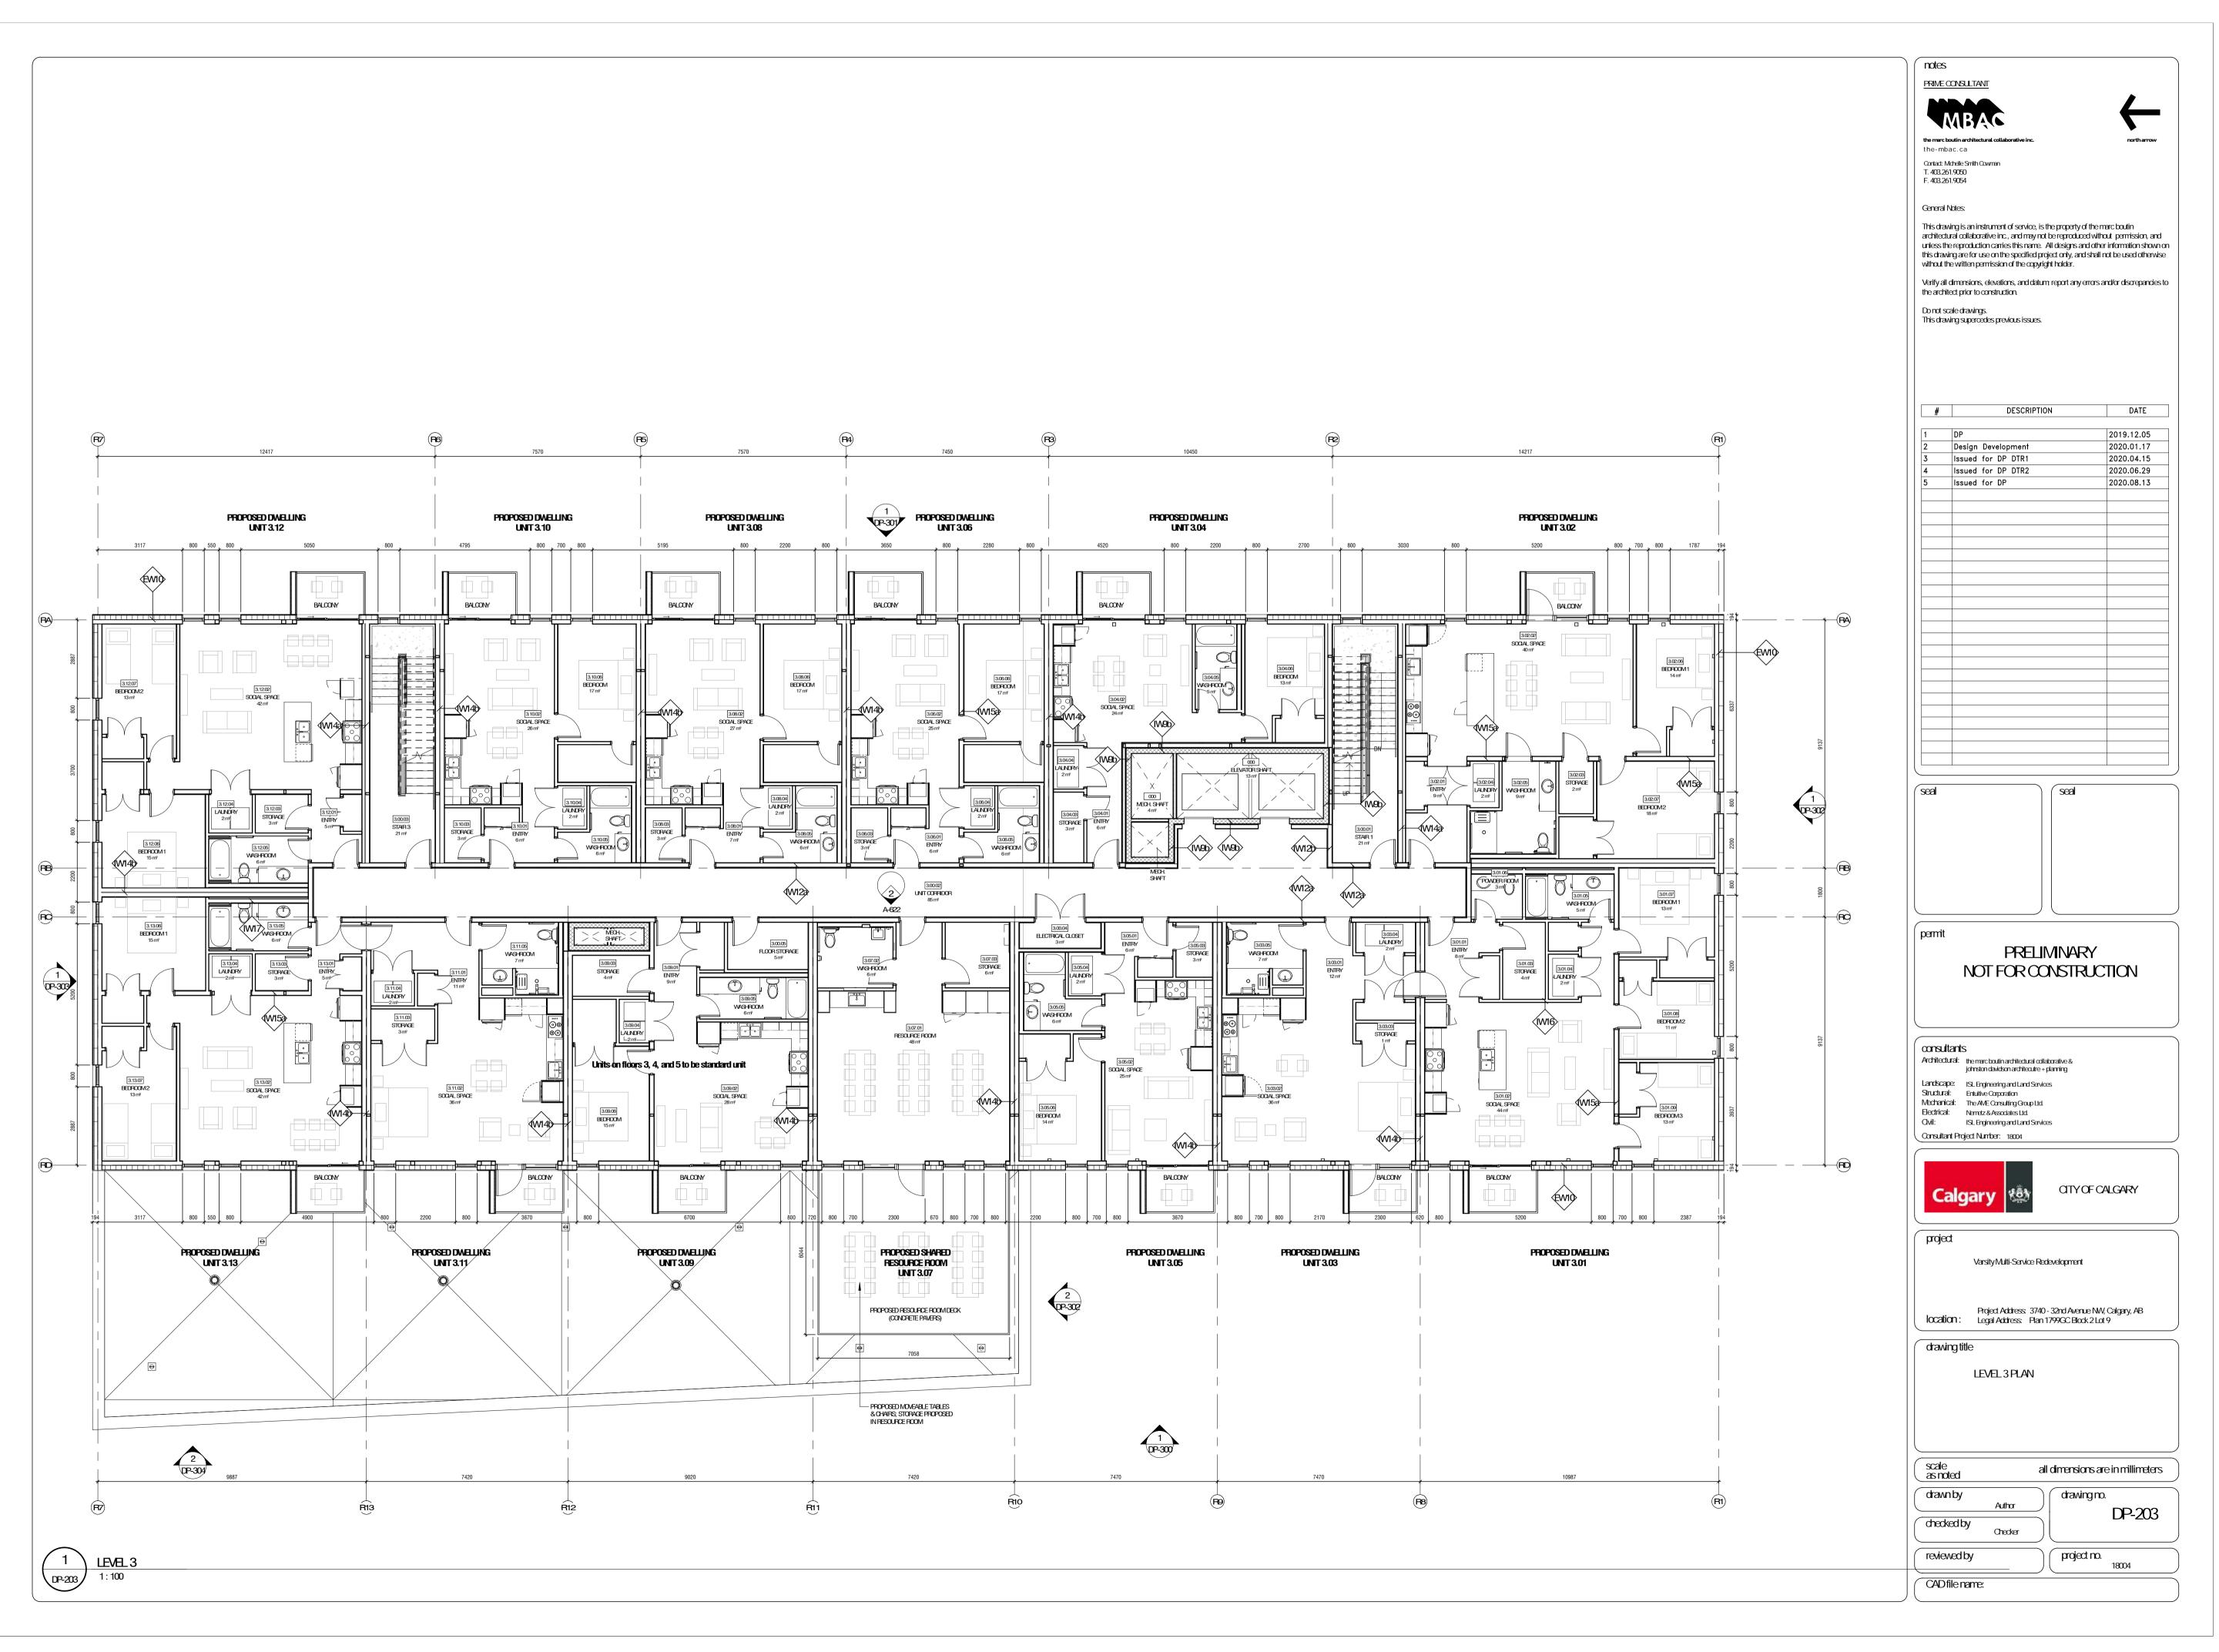


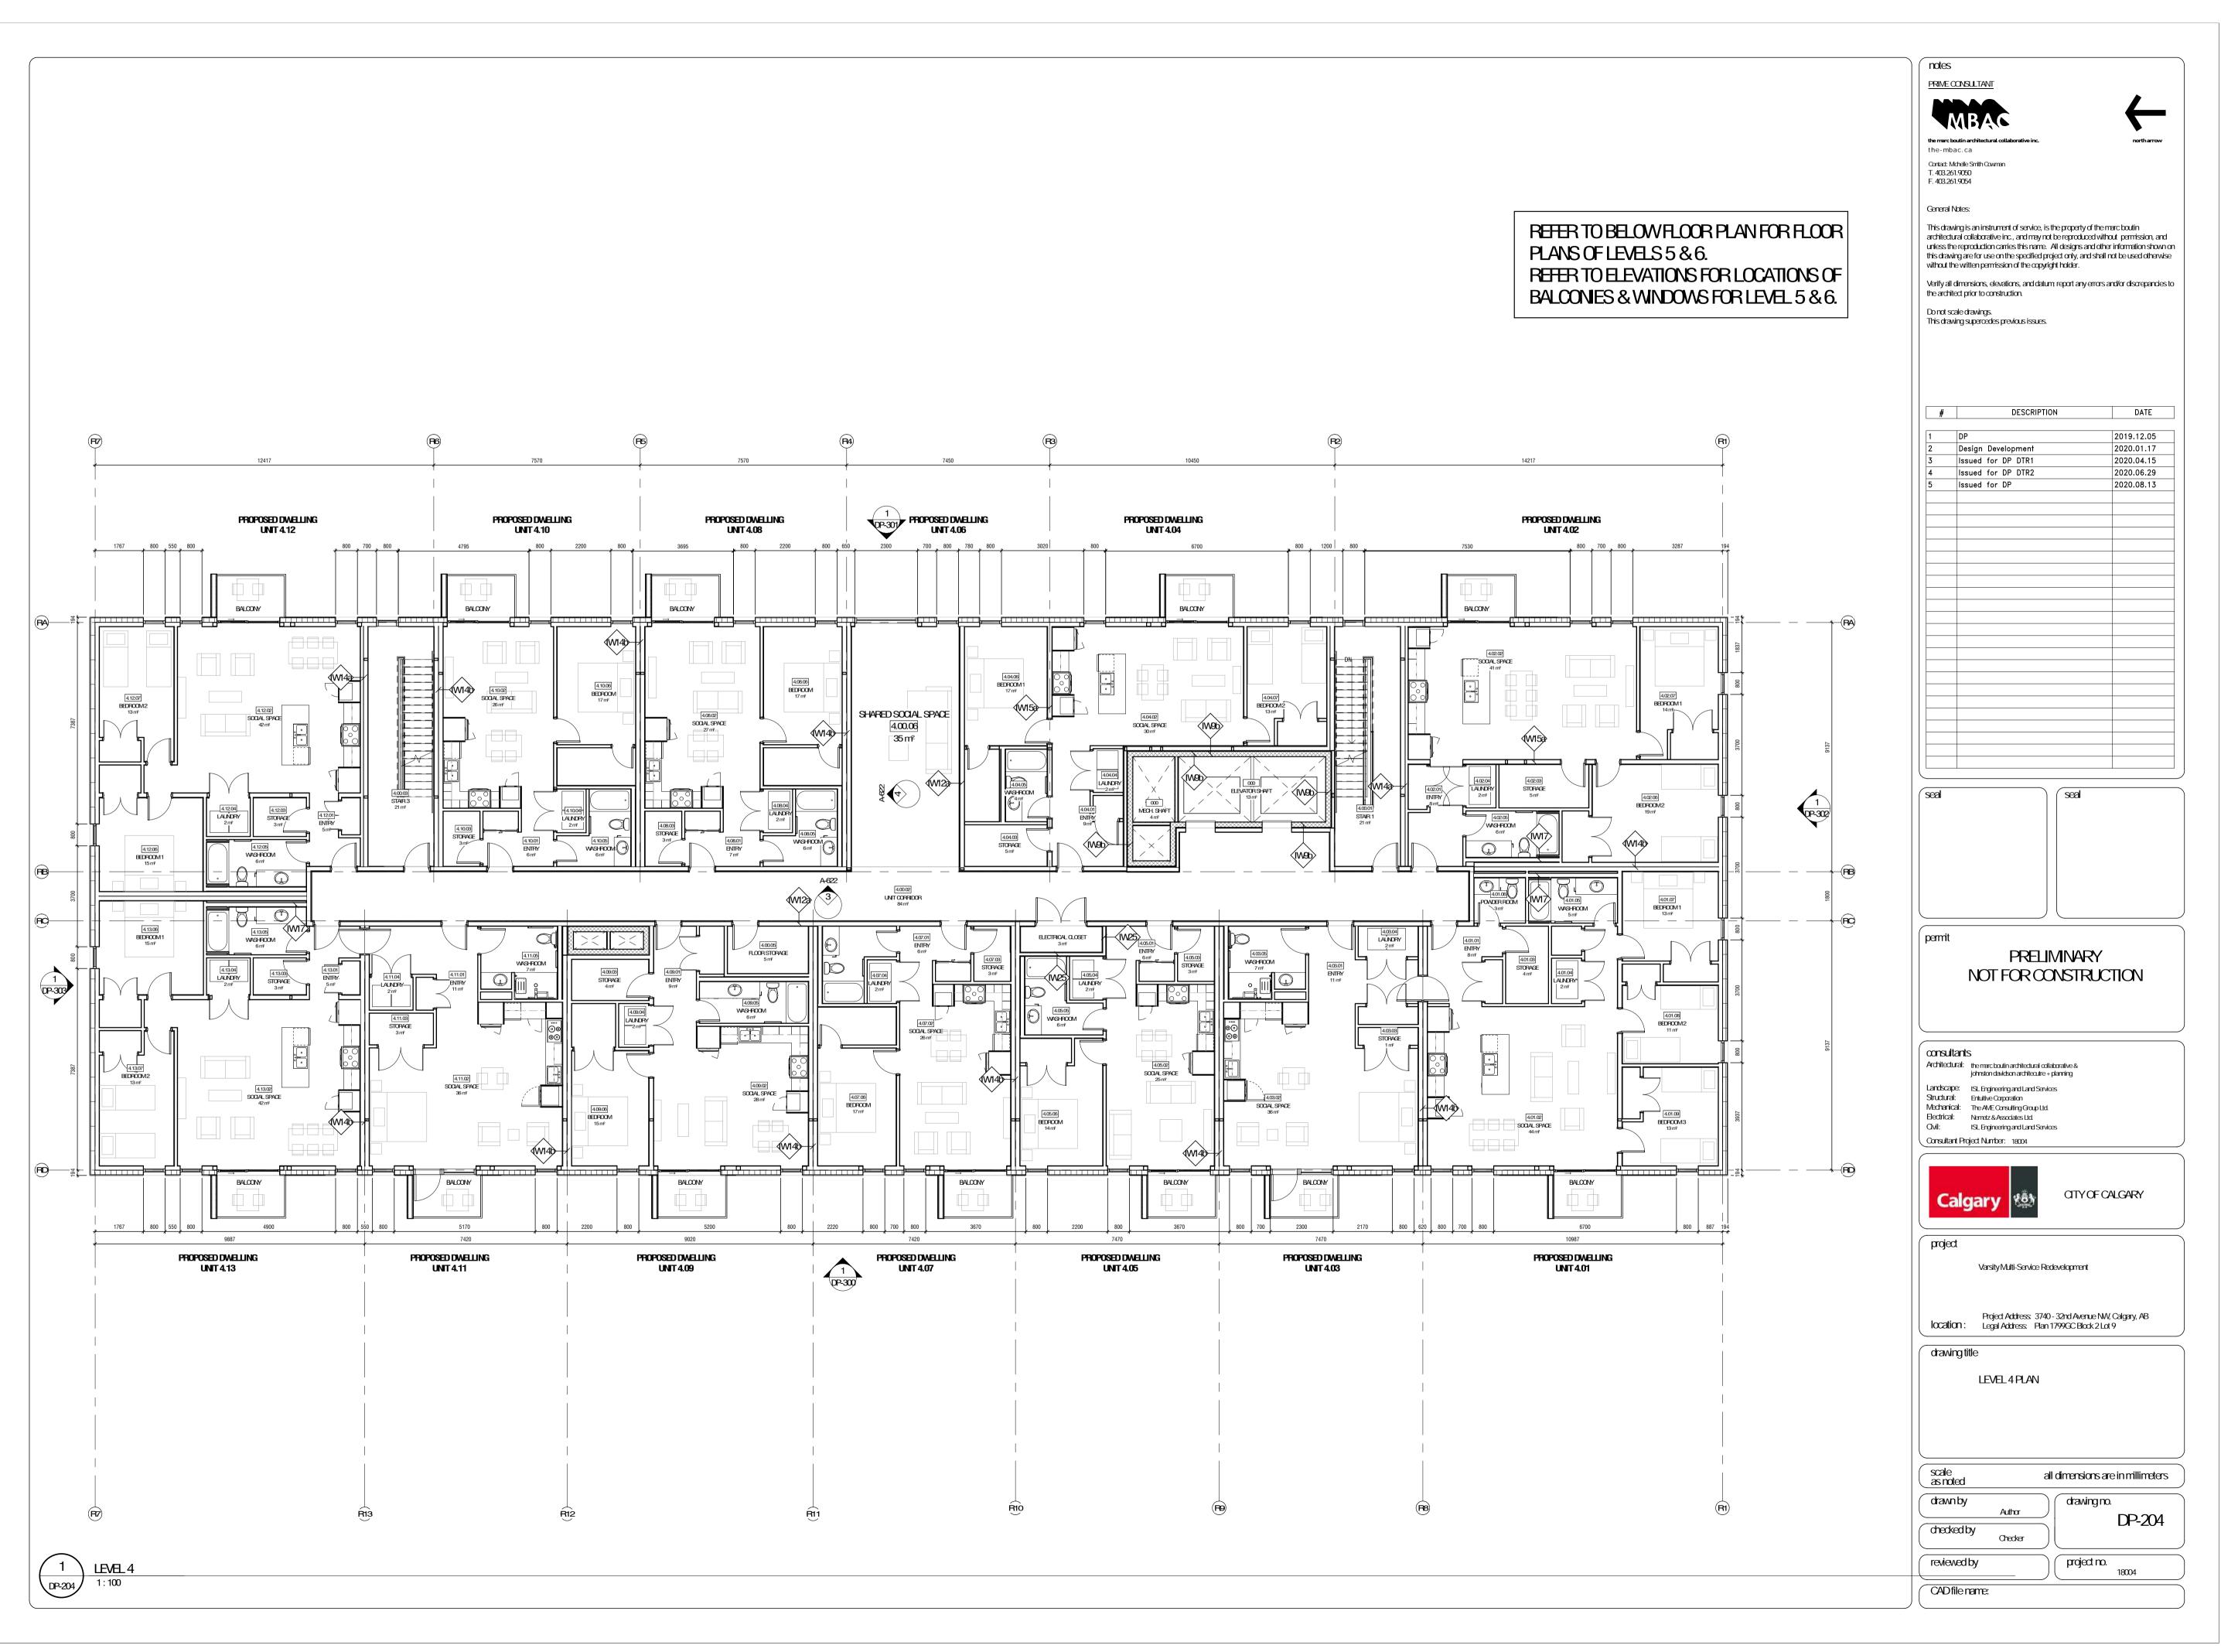


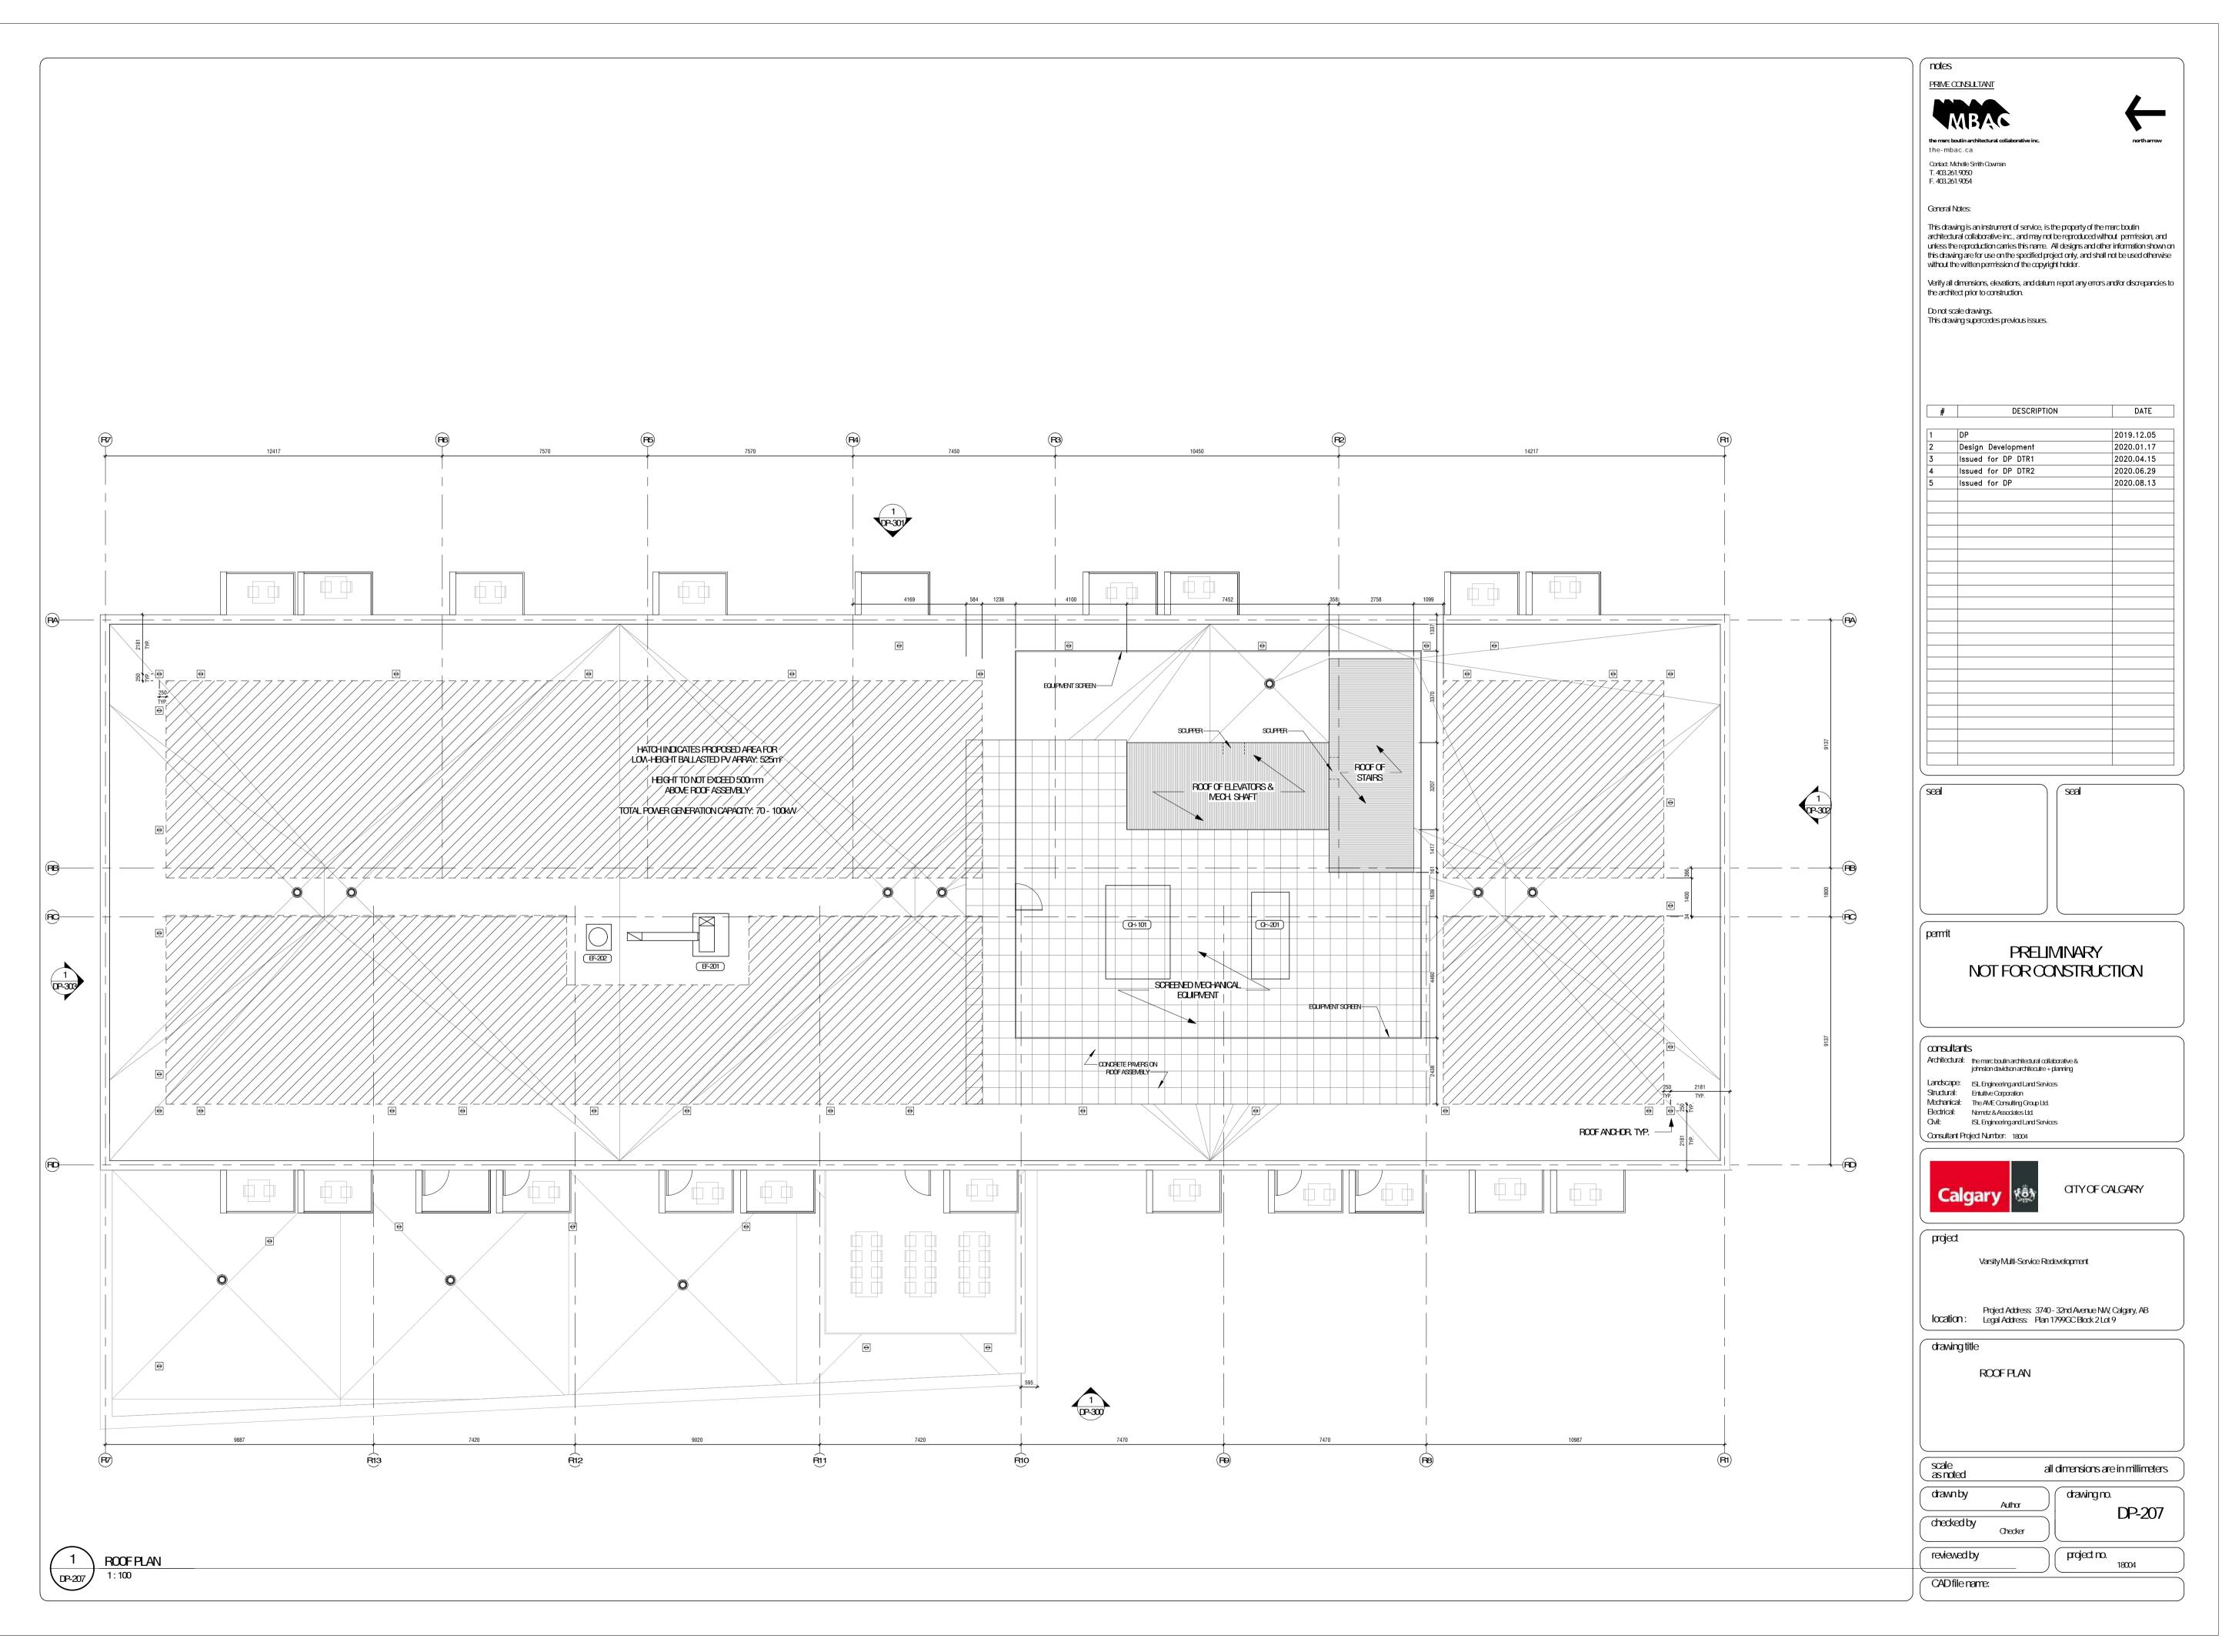






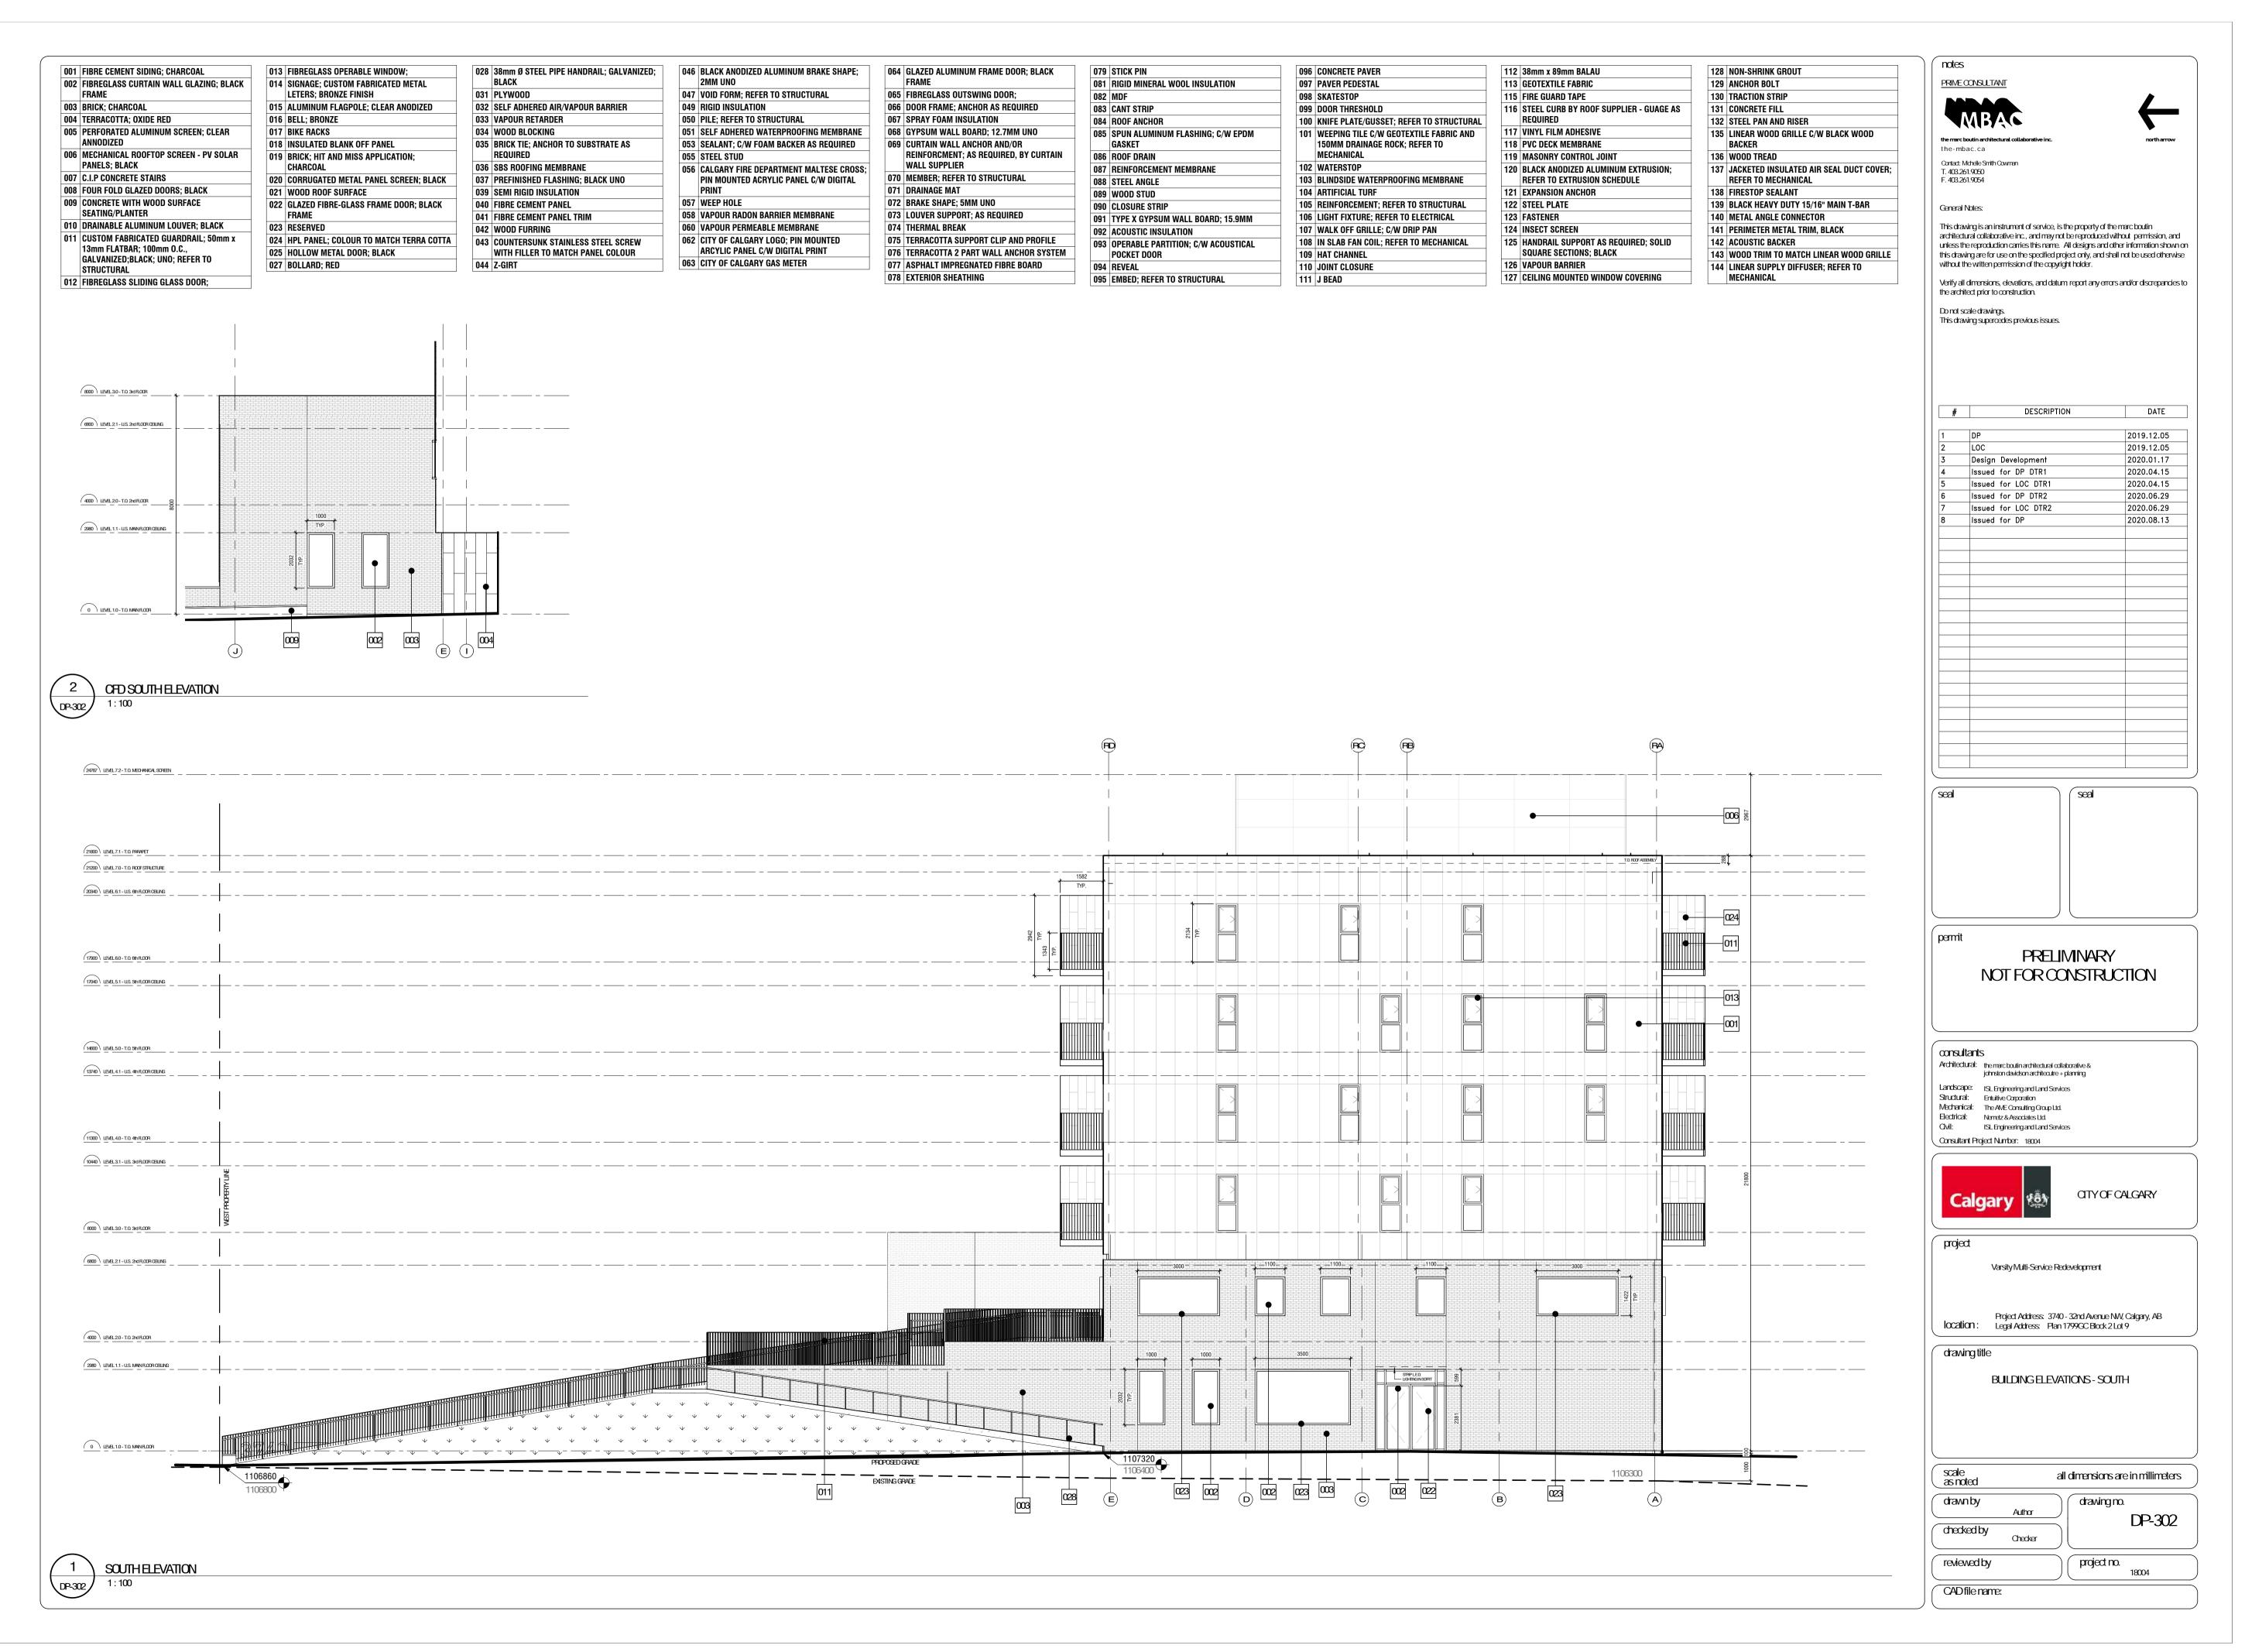

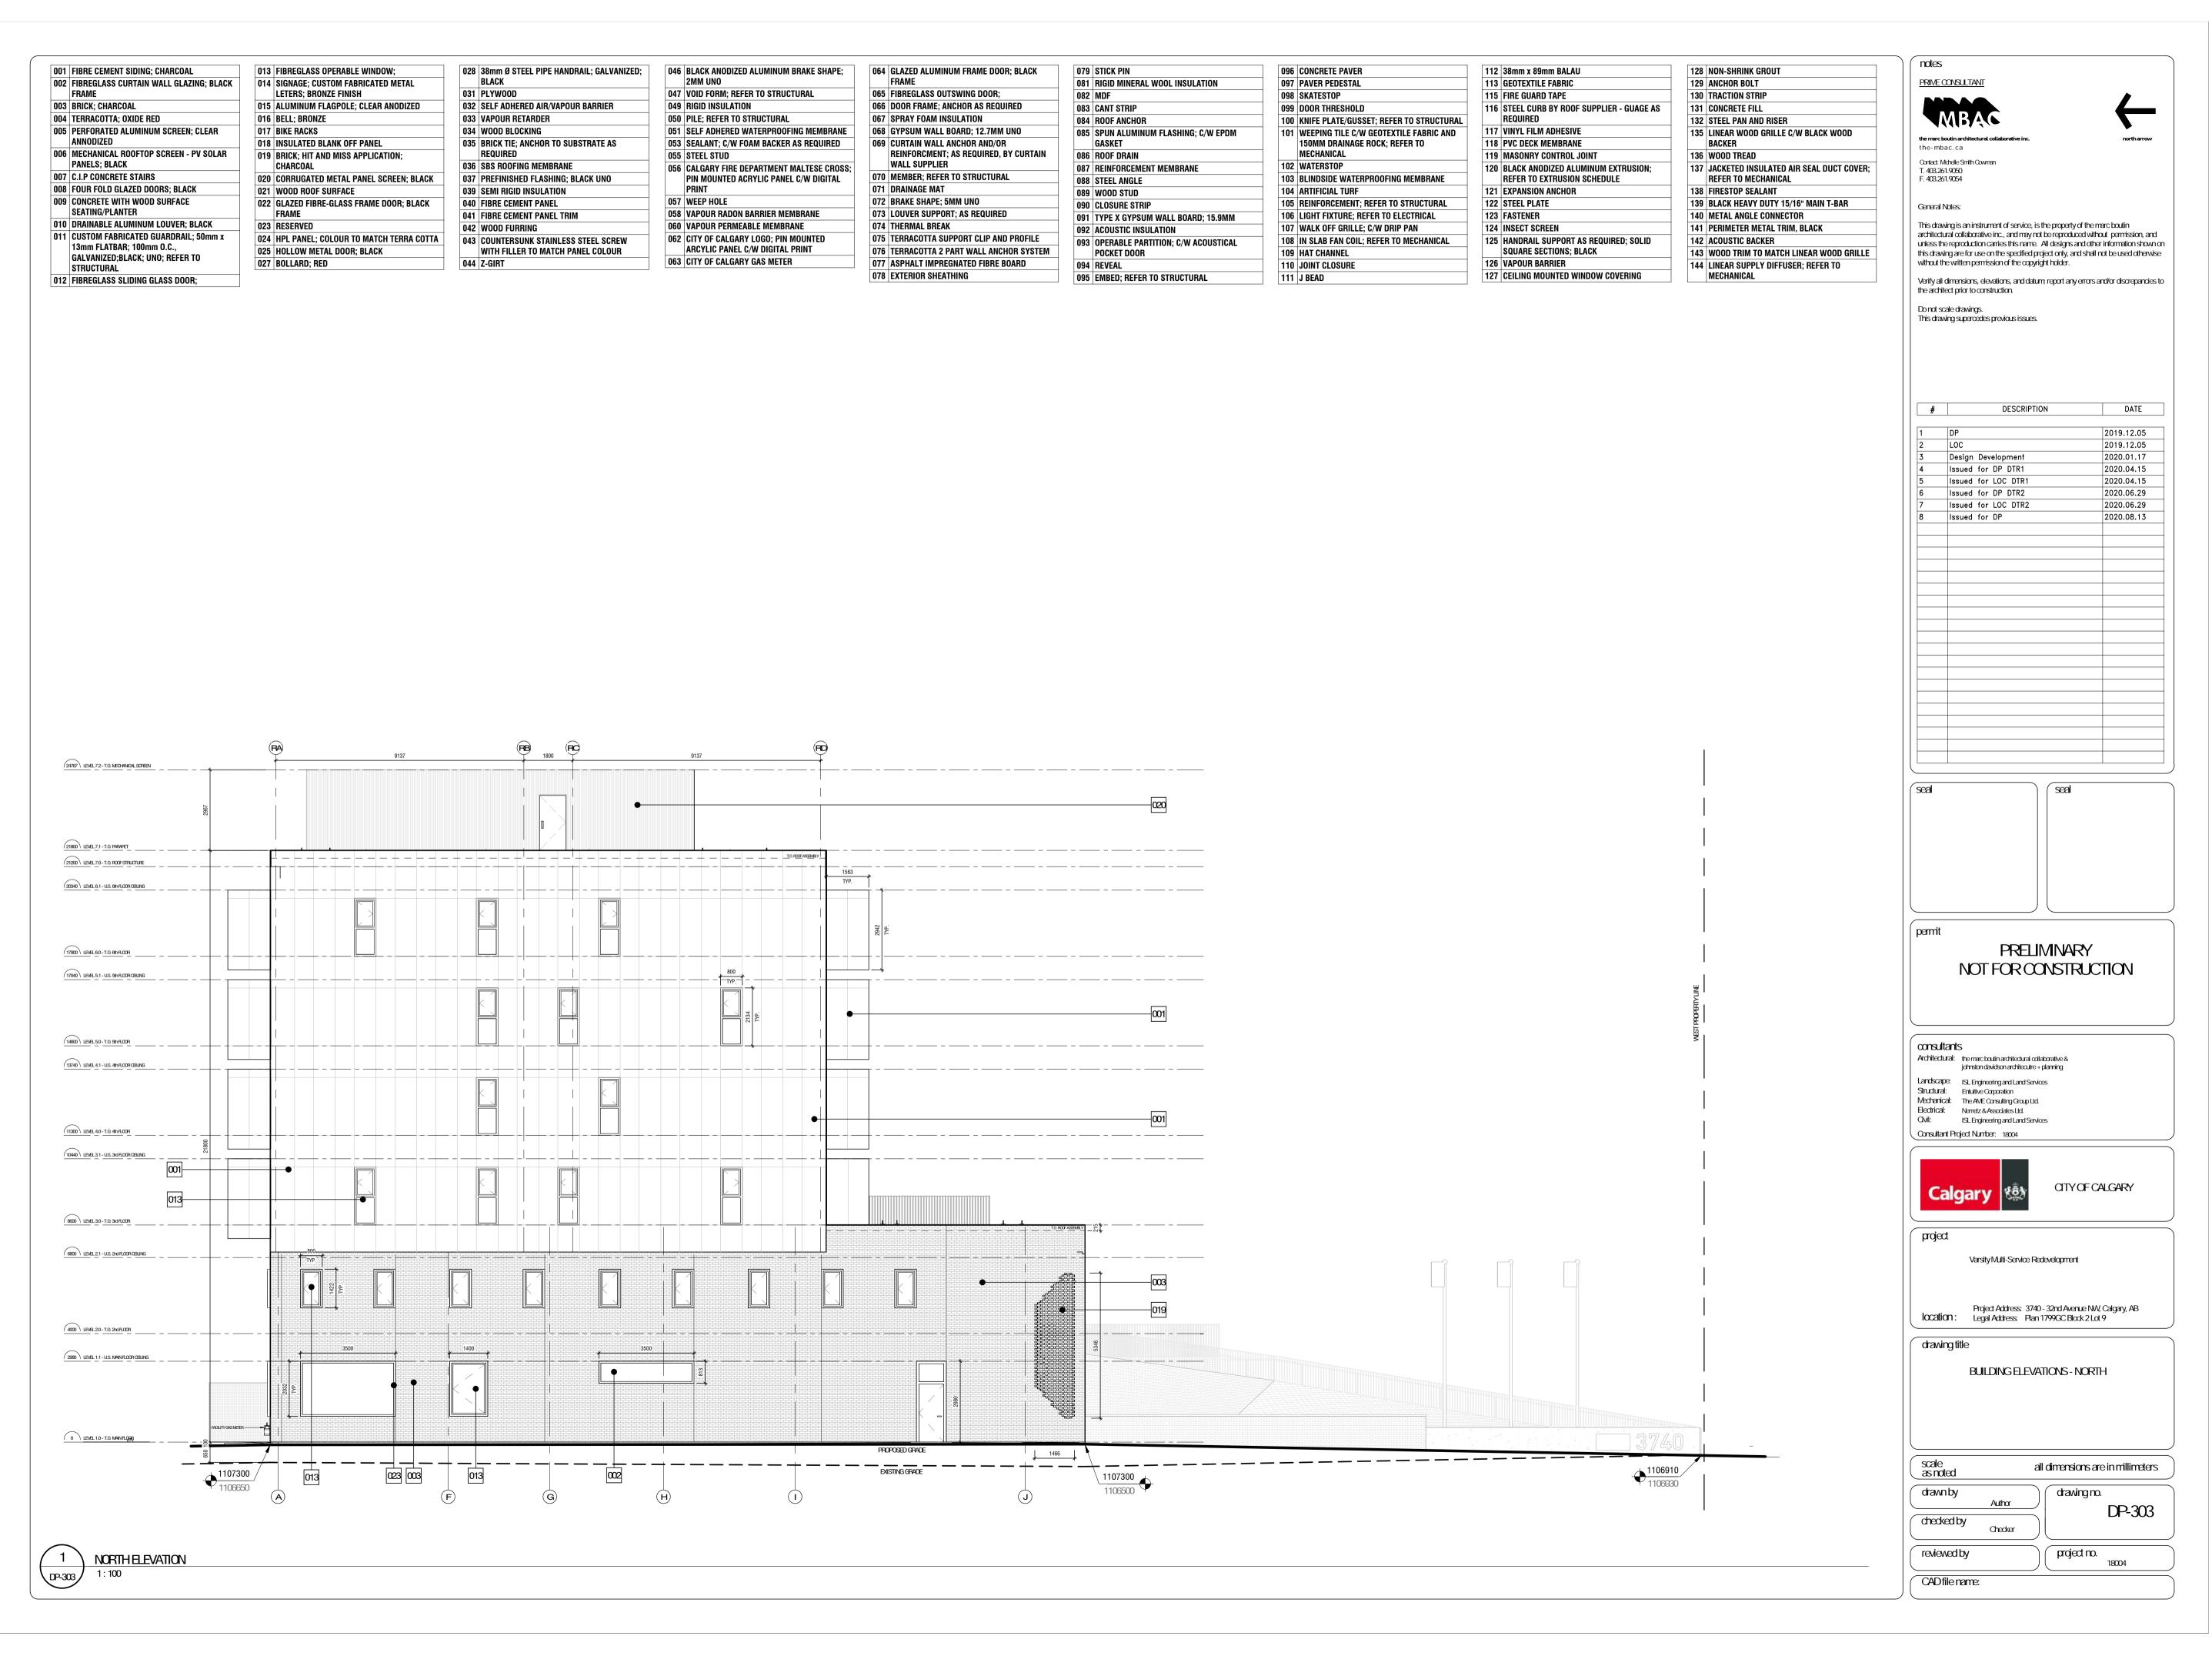

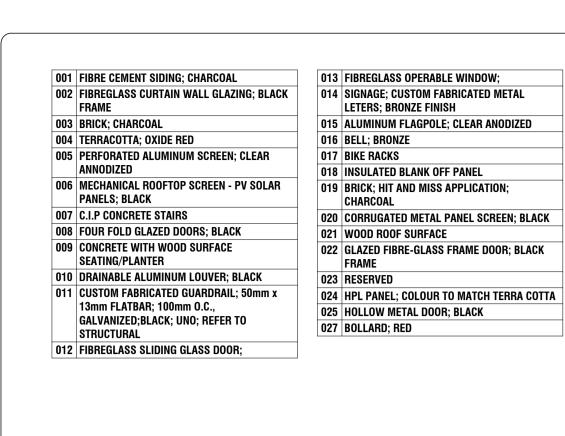

028	38mm Ø STEEL PIPE HANDRAIL; GALVANIZED; Black
031	PLYW00D
032	SELF ADHERED AIR/VAPOUR BARRIER
033	VAPOUR RETARDER
034	WOOD BLOCKING
035	BRICK TIE; ANCHOR TO SUBSTRATE AS REQUIRED
036	SBS ROOFING MEMBRANE
037	PREFINISHED FLASHING; BLACK UNO
039	SEMI RIGID INSULATION
040	FIBRE CEMENT PANEL
041	FIBRE CEMENT PANEL TRIM
042	WOOD FURRING
043	COUNTERSUNK STAINLESS STEEL SCREW WITH FILLER TO MATCH PANEL COLOUR
044	Z-GIRT

046	BLACK ANODIZED ALUMINUM BRAKE SHAPE; 2mm uno	064	GLAZED ALUMINUM FRAME DOOR; BI FRAME
047	VOID FORM; REFER TO STRUCTURAL	065	FIBREGLASS OUTSWING DOOR;
049	RIGID INSULATION	066	DOOR FRAME; ANCHOR AS REQUIRED
050	PILE; REFER TO STRUCTURAL	067	SPRAY FOAM INSULATION
051	SELF ADHERED WATERPROOFING MEMBRANE	068	GYPSUM WALL BOARD; 12.7MM UNO
053	SEALANT; C/W FOAM BACKER AS REQUIRED	069	CURTAIN WALL ANCHOR AND/OR
055	STEEL STUD		REINFORCMENT; AS REQUIRED, BY C
056	CALGARY FIRE DEPARTMENT MALTESE CROSS;		WALL SUPPLIER
	PIN MOUNTED ACRYLIC PANEL C/W DIGITAL	070	MEMBER; REFER TO STRUCTURAL
	PRINT	071	DRAINAGE MAT
057	WEEP HOLE	072	BRAKE SHAPE; 5MM UNO
058	VAPOUR RADON BARRIER MEMBRANE	073	LOUVER SUPPORT; AS REQUIRED
060	VAPOUR PERMEABLE MEMBRANE	074	THERMAL BREAK
062	CITY OF CALGARY LOGO; PIN MOUNTED	075	TERRACOTTA SUPPORT CLIP AND PR
	ARCYLIC PANEL C/W DIGITAL PRINT	076	TERRACOTTA 2 PART WALL ANCHOR
063	CITY OF CALGARY GAS METER	077	ASPHALT IMPREGNATED FIBRE BOAR
		078	EXTERIOR SHEATHING

003

IINUM FRAME DOOR; BLACK	079	STICK PIN
	081	RIGID MINERAL WOOL INSULATION
OUTSWING DOOR;	082	MDF
ANCHOR AS REQUIRED	083	CANT STRIP
INSULATION	084	ROOF ANCHOR
L BOARD; 12.7MM UNO	085	SPUN ALUMINUM FLASHING; C/W EPDM
L ANCHOR AND/OR		GASKET
NT; AS REQUIRED, BY CURTAIN	086	ROOF DRAIN
ER	087	REINFORCEMENT MEMBRANE
ER TO STRUCTURAL	088	STEEL ANGLE
T	089	WOOD STUD
; 5MM UNO	090	CLOSURE STRIP
ORT; AS REQUIRED	091	TYPE X GYPSUM WALL BOARD; 15.9MM
AK		ACOUSTIC INSULATION
SUPPORT CLIP AND PROFILE		OPERABLE PARTITION; C/W ACOUSTICAL
2 PART WALL ANCHOR SYSTEM		POCKET DOOR
REGNATED FIBRE BOARD	094	REVEAL
EATHING	095	EMBED; REFER TO STRUCTURAL


11 002 008

GID MINERAL WOOL INSULATION	097	PAVER PEDESTAL
F	098	SKATESTOP
NT STRIP	099	DOOR THRESHOLD
OF ANCHOR	100	KNIFE PLATE/GUSSET; REFER TO STRUCTUR
UN ALUMINUM FLASHING; C/W EPDM SKET	101	WEEPING TILE C/W GEOTEXTILE FABRIC AN 150MM DRAINAGE ROCK; REFER TO
OF DRAIN		MECHANICAL
NFORCEMENT MEMBRANE	102	WATERSTOP
EEL ANGLE	103	BLINDSIDE WATERPROOFING MEMBRANE
OOD STUD		ARTIFICIAL TURF
DSURE STRIP	105	REINFORCEMENT; REFER TO STRUCTURAL
PE X GYPSUM WALL BOARD; 15.9MM	106	LIGHT FIXTURE; REFER TO ELECTRICAL
OUSTIC INSULATION	107	WALK OFF GRILLE; C/W DRIP PAN
ERABLE PARTITION; C/W ACOUSTICAL	108	IN SLAB FAN COIL; REFER TO MECHANICAL
CKET DOOR	109	HAT CHANNEL
VEAL	110	JOINT CLOSURE
BED; REFER TO STRUCTURAL	111	J BEAD

096 CONCRETE PAVER






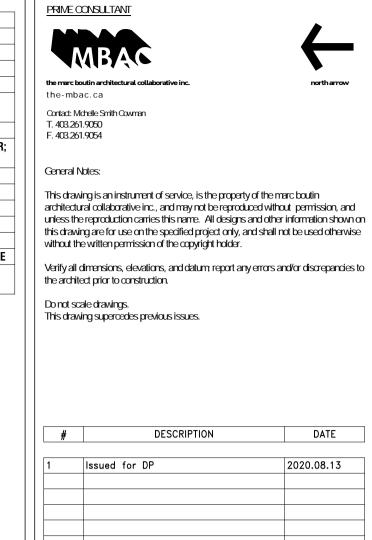

notes



DATE

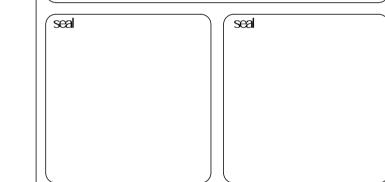



Architectural: the marc boutin architectural collaborative & johnston davidson architecutre + planning Landscape: ISL Engineering and Land Services Structural: Entuitive Corporation Mechanical: The AME Consulting Group Ltd. Electrical: Nemetz & Associates Ltd. Ovil: ISL Engineering and Land Services Consultant Project Number: 18004




Project Address: 3740 - 32nd Avenue NW, Calgary, AB location: Legal Address: Plan 1799GC Block 2 Lot 9


Varsity Multi-Service Redevelopment


drawing title WEST CFD SIGNAGE ELEVATION

scale as noted		all dimensions are in millimeters			
drawn by	Author	drawing no.	DP-304		
checked by	Checker		DP-304		
reviewed by		project no.	18004		
CAD file name:					

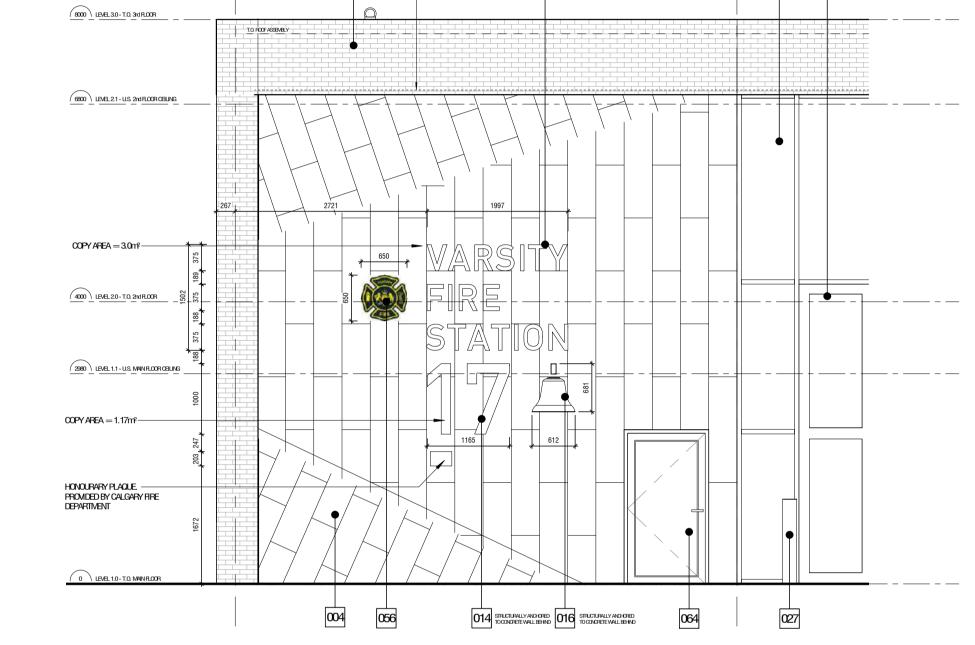


014 STRUCTURALLY ANGHORED TO CONCRETE WALL BEHIND

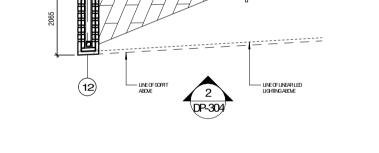


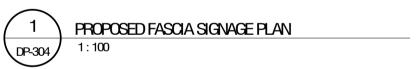



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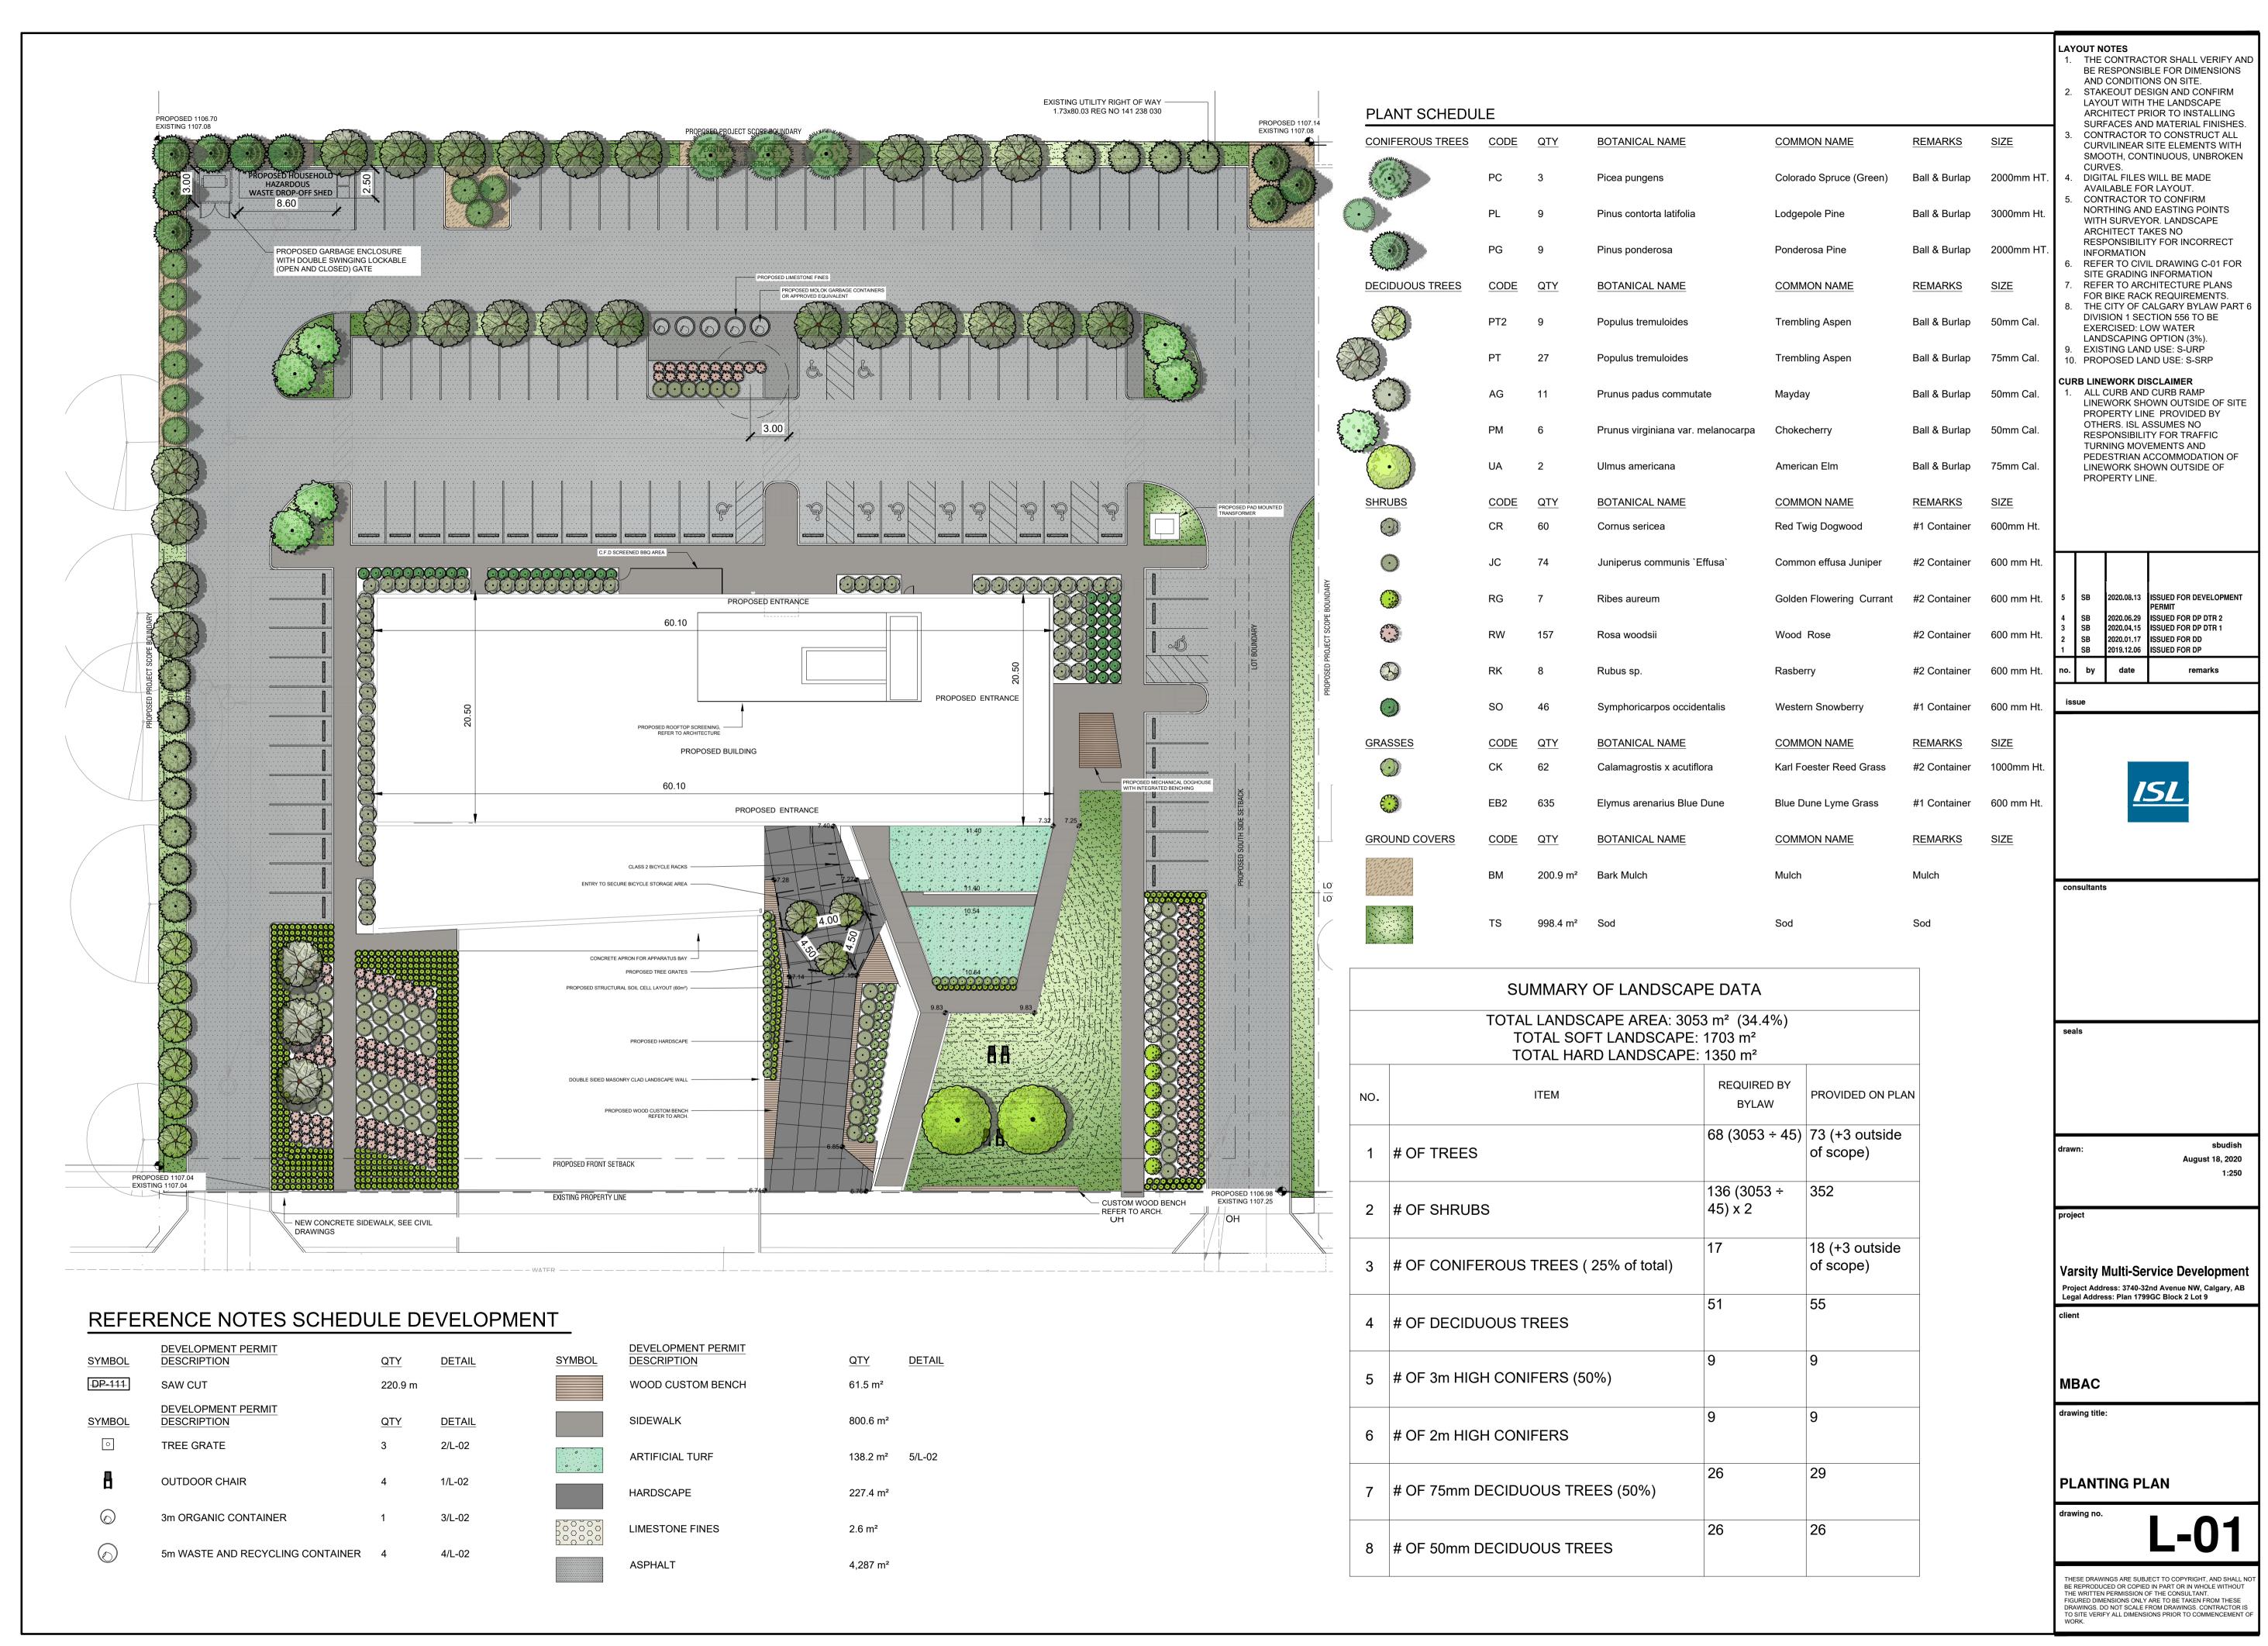
PROPOSED WEST SIGNAGE ELEVATION DP-304



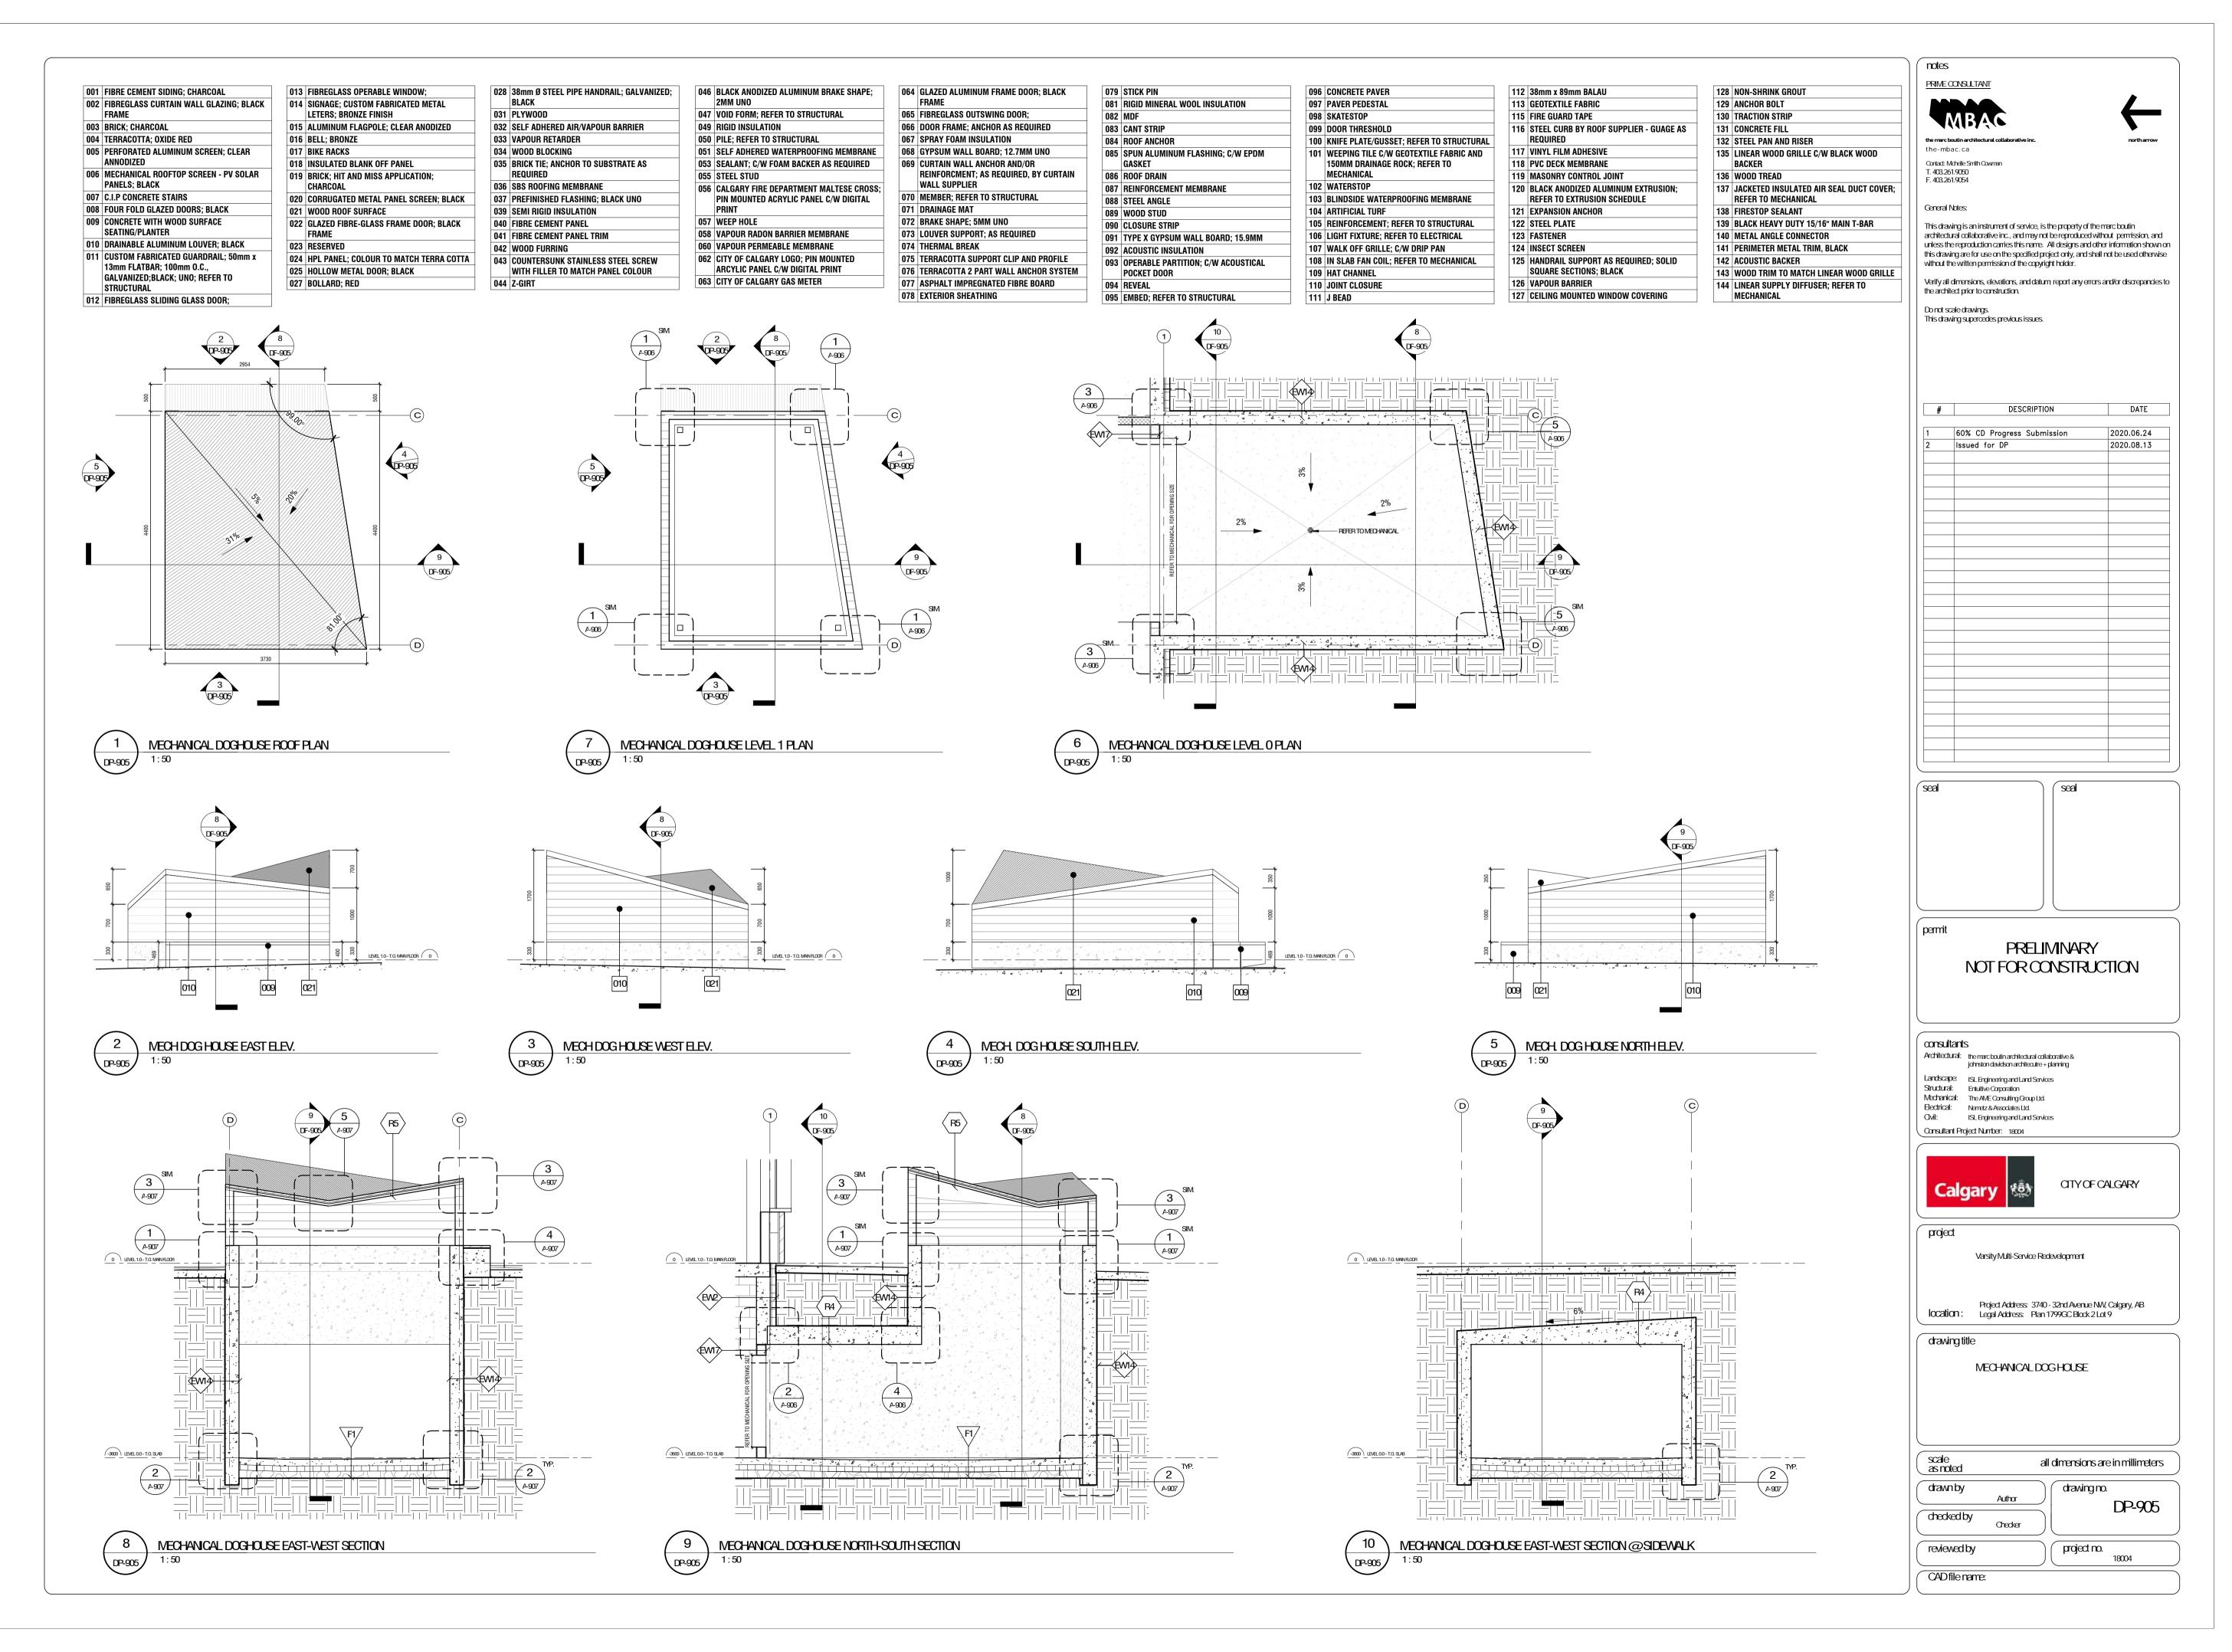

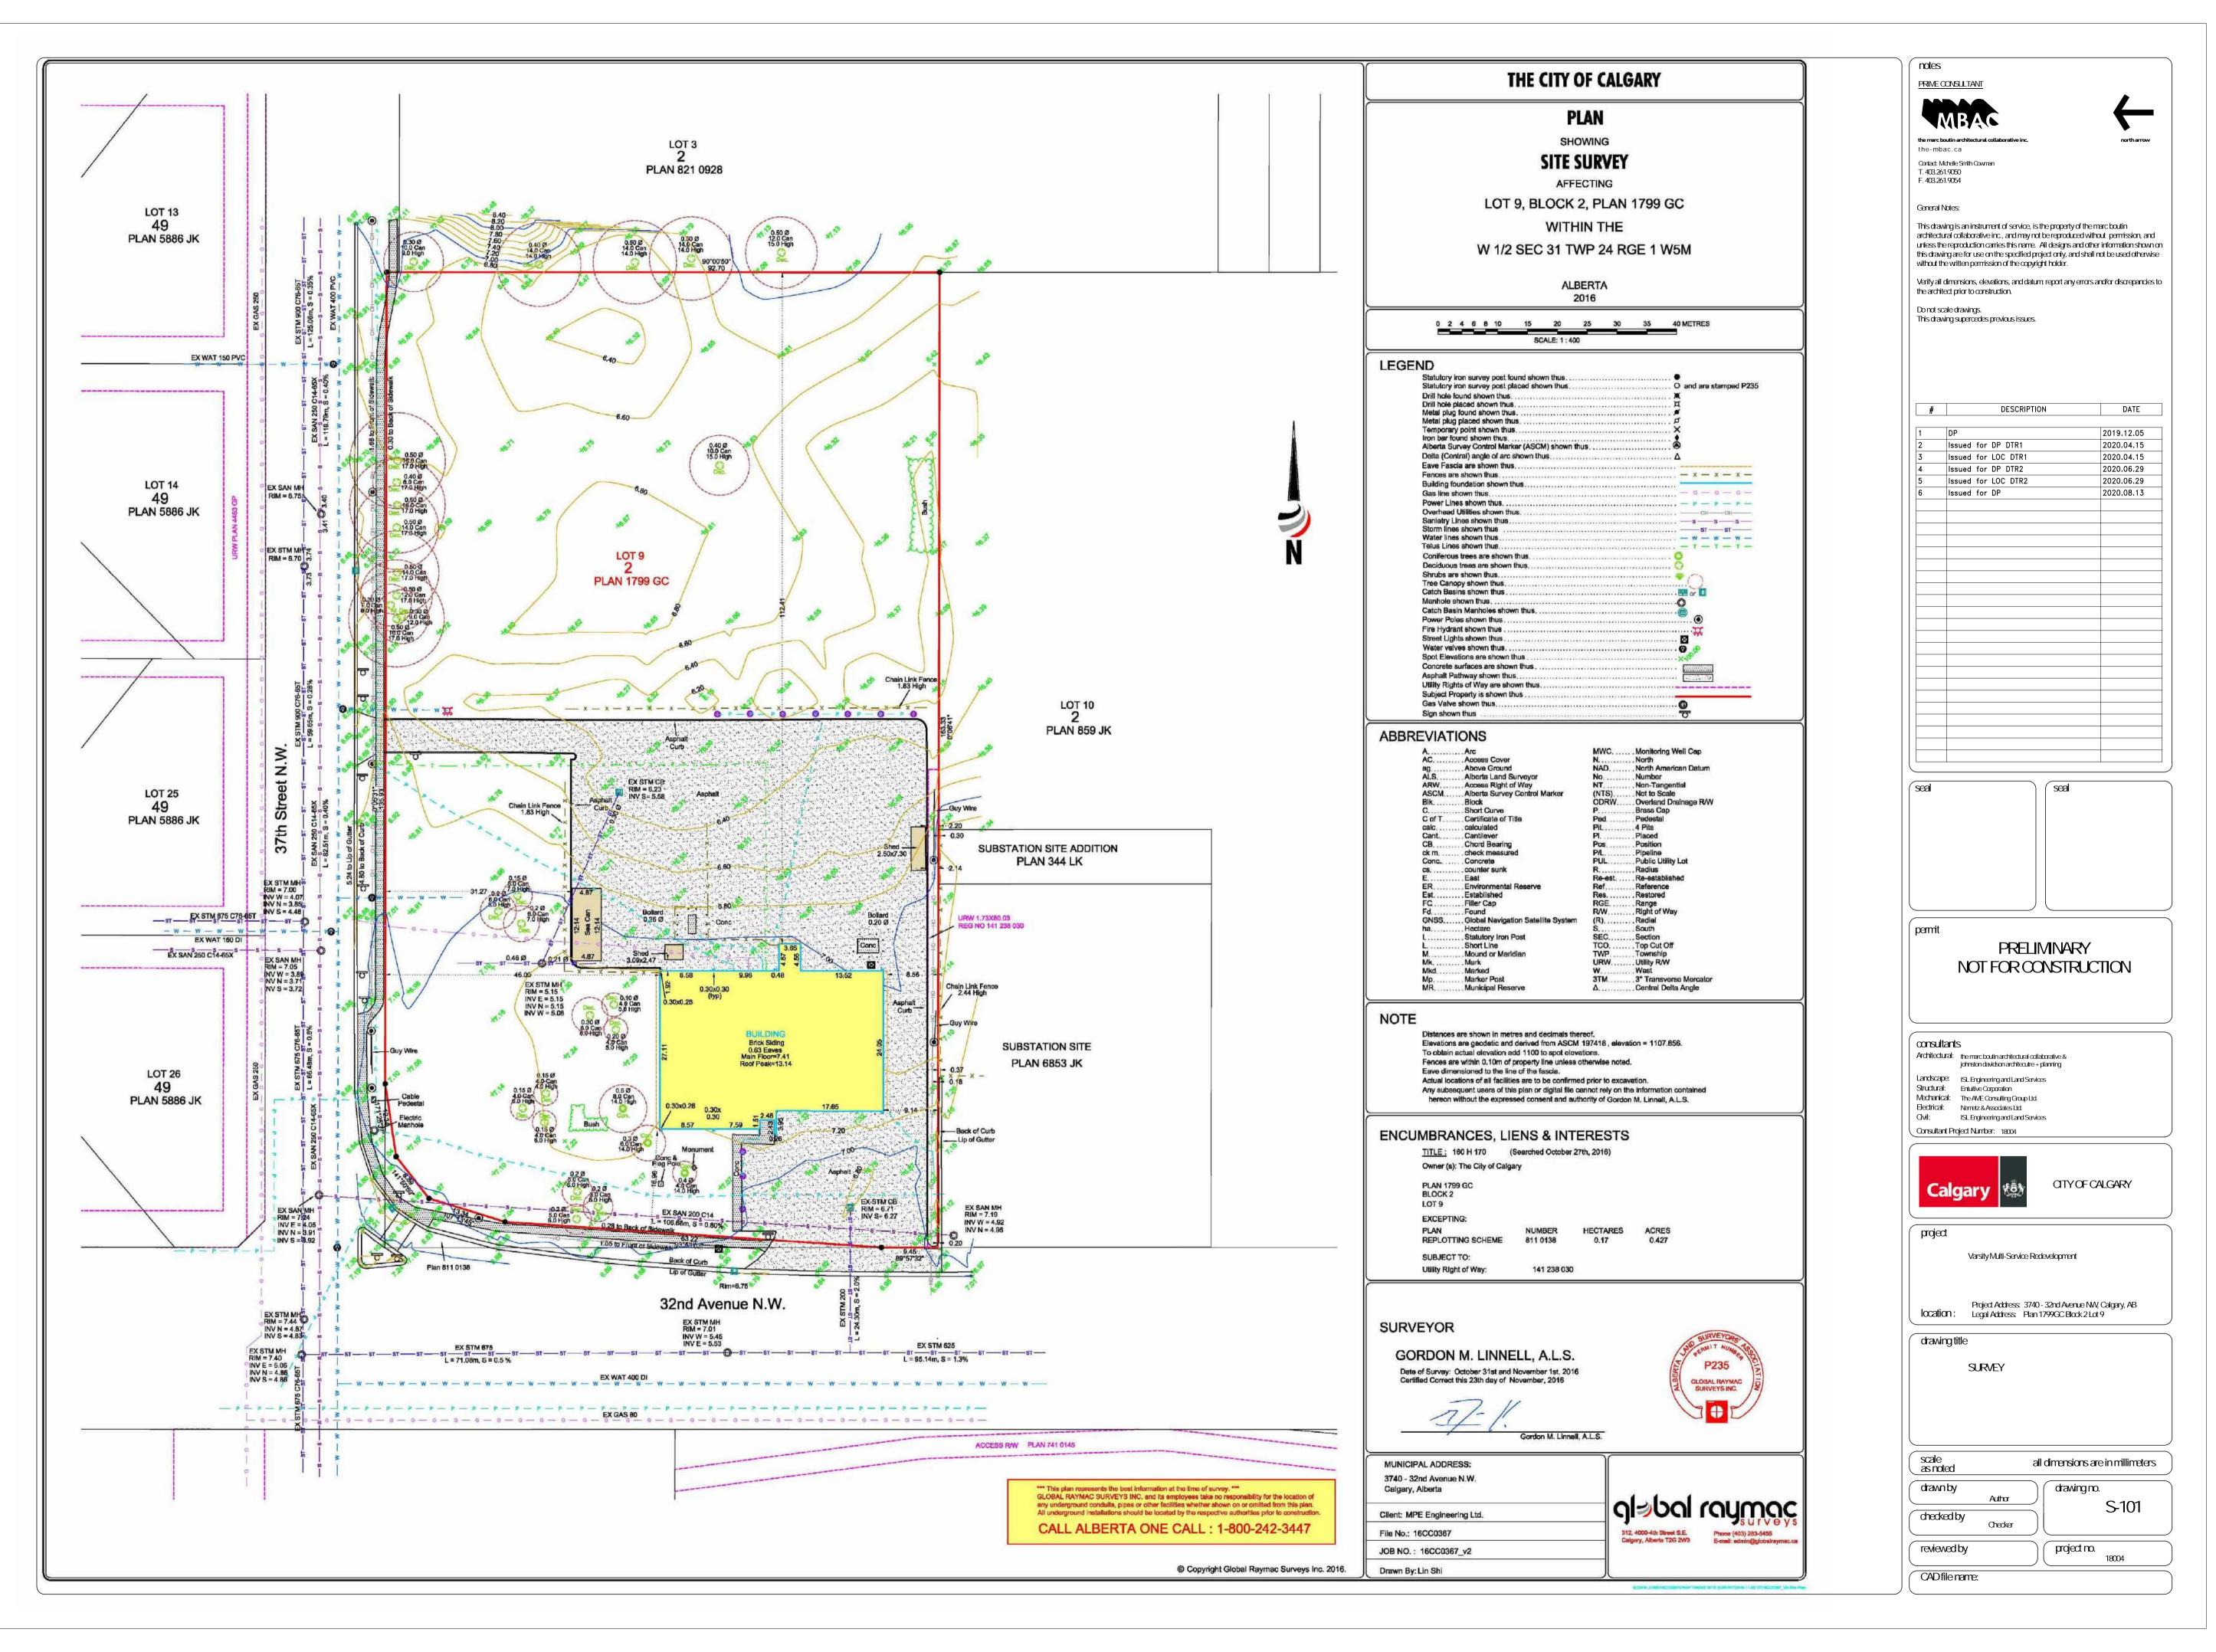

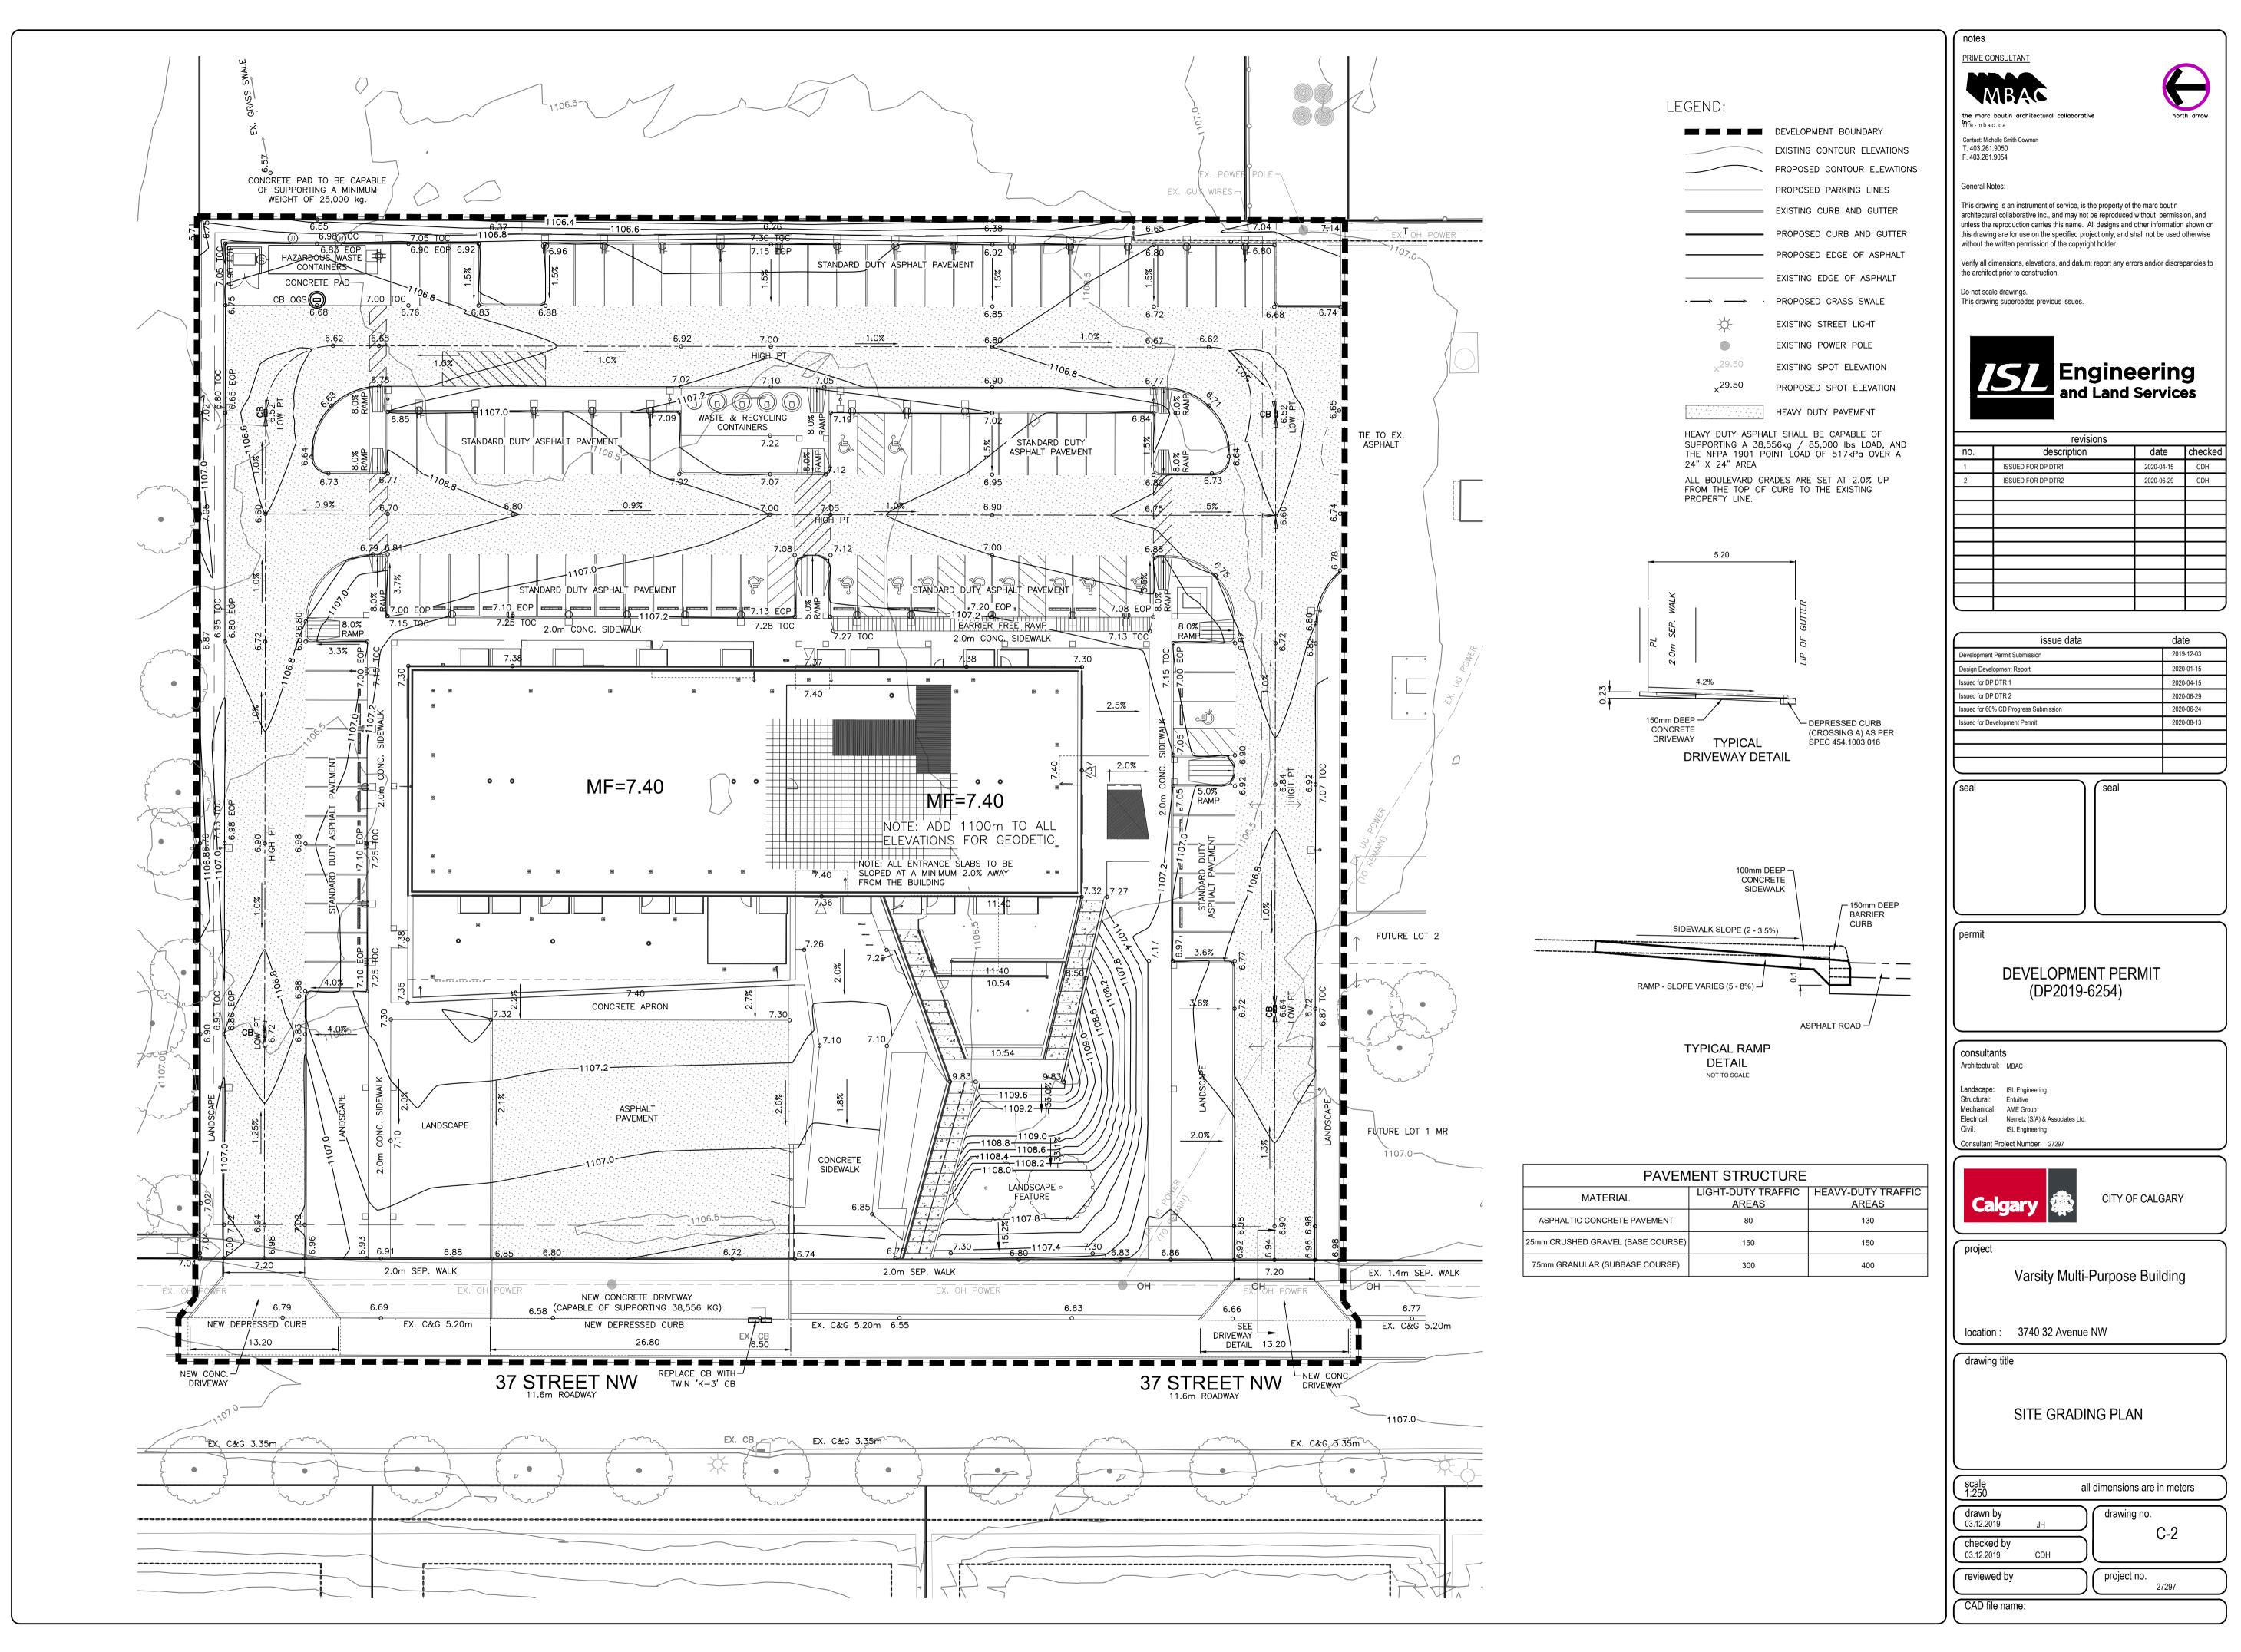


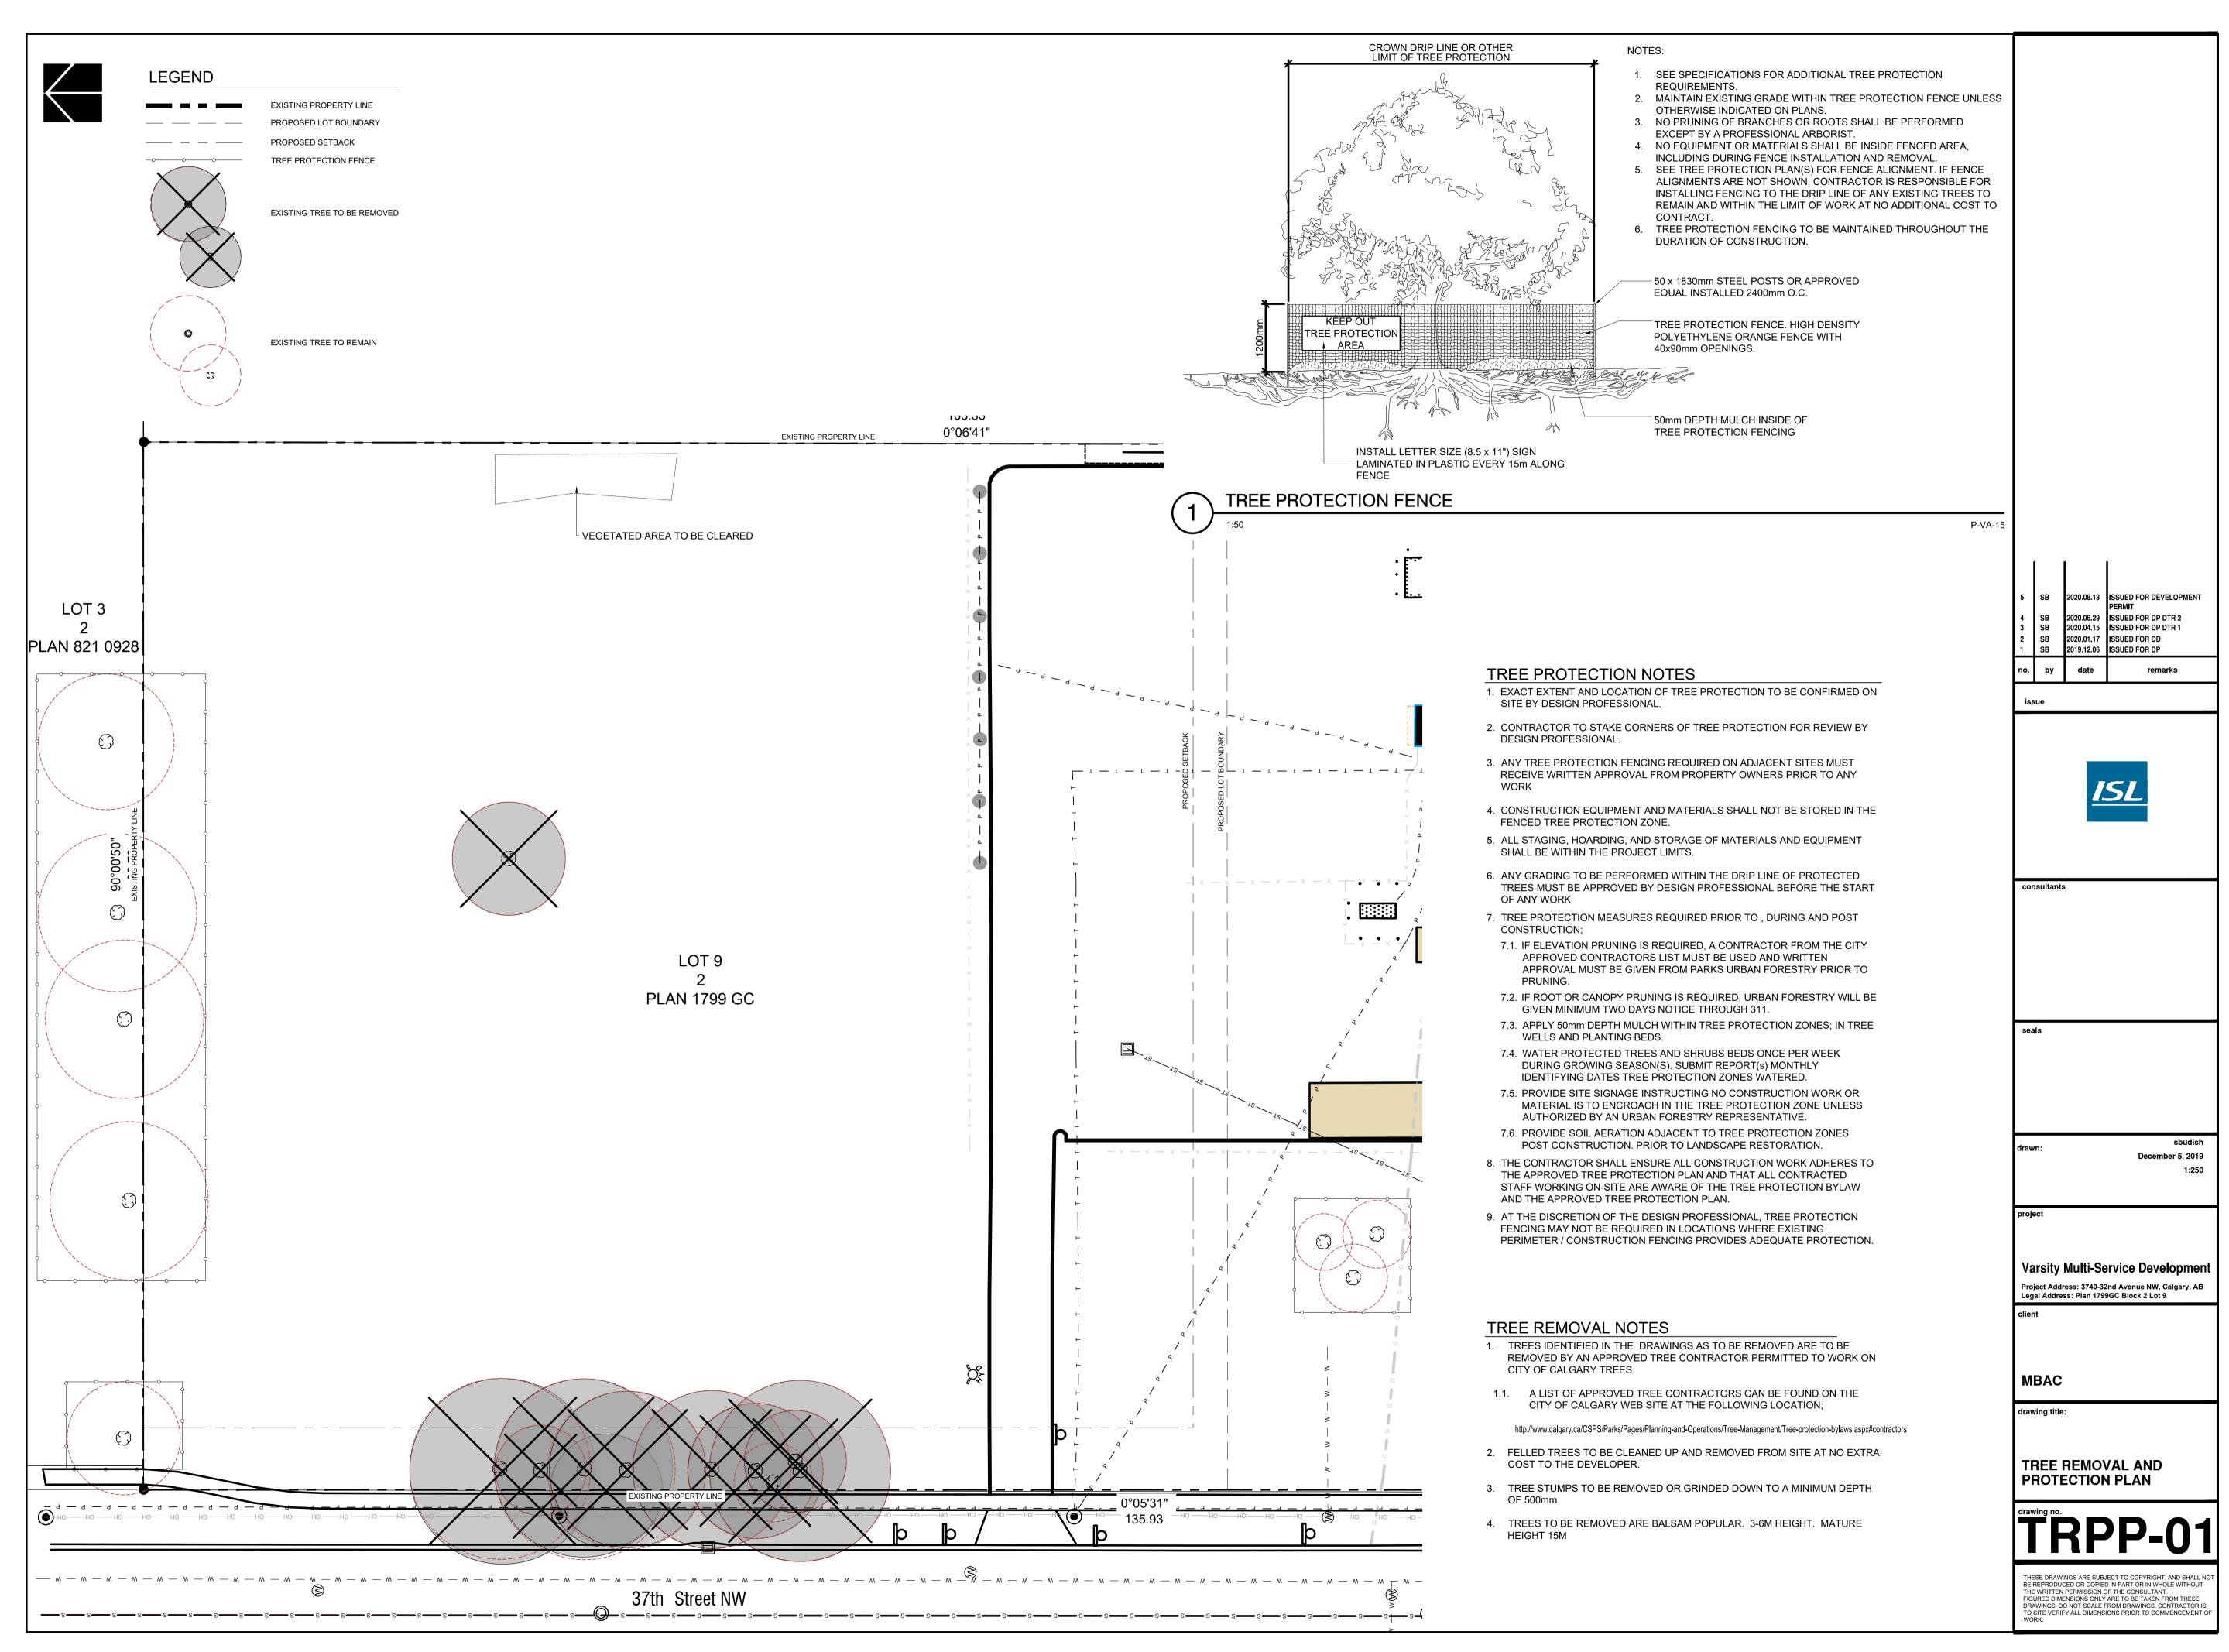



remarks


July 24, 2020


LUMINAIRE SCHEDULE					
	Nemetz Type	Description	Location	Lamp	Mounting
LANDSCAPE AND EXTERI	OR				
Landscape Type					
	нн	BEGA 84 667K35 (CONFIRM FINISH WITH ARCHITECT)	LANDSCAPE LIGHTING	27W LED 2,000 LUMENS 3500K	SURFACE/JB
	DD	LITHONIA LIGHTING DSX1 LED-P2-40K-BLC-MVOLT-SPA-NLTAIR2-PIRHN-XX (CONFIRM FINISH WITH ARCHITECT)	SITE LIGHTING	70W LED 7,293 LUMENS 4000K	6096mm POLE (20')
	DD1	LITHONIA LIGHTING DSX1 LED-P2-40K-T4M-MVOLT-SPA-NLTAIR2-PIRHN-XX; 2 HEADS PER POLE (CONFIRM FINISH WITH ARCHITECT)	SITE LIGHTING	70W LED 8,707 LUMENS PER HEAD 4000K	6096mm POLE (20')
	IJ	LITHONIA LIGHTING WDGE2 LED-P1SW-40K-90CRI-VW-MVOLT-SRM- NLTAIR2 PIR-XX (CONFIRM FINISH WITH ARCHITECT) NOTE: PERFORMANCE RECOMMENDATION. FIXTURE BY OWNER.	HHWD SHED (EXTERIOR)	10W LED 4000K 1284 LUMENS	SURFACE/WALL
	LL	DIFFUSION LIGHTING SL6-XX-24V-3500 K c/w SLC-065R EXTRUSION (CONFIRM MOUNTING DETAILS AND FINISH WITH ARCHITECT)	BENCH LIGHTING	14.4 W/m LED 297 LUMENS 3500K	RECESSED/UNDER BENCH
	LL1	DIFFUSION LIGHTING SL1-XX-24V-3500 K c/w SLC-002S EXTRUSION (CONFIRM MOUNTING DETAILS AND FINISH WITH ARCHITECT)	RAILING LIGHTING	4.8 W/m LED 99 LUMENS 3500K	RECESSED/RAILING
	LL2	A LIGHT ACL8-XX-LH-35-U-TF-F-XX-D-XX-Q-CRI (CONFIRM MOUNTING DETAILS AND FINISH WITH ARCHITECT)	APRON CANOPY	38.4W LED 1,655 LUMENS 3500K	SURFACE/SOFFIT
	LL3	SELUX LIGHTING M60-L60W-1B30-35-NB-XX-14-BK-UNV-XX-XX-XX	ENTRY CANOPY (FRONT ENTRY)		RECESSED/SOFFIT
	LL3a	SELUX LIGHTING M60-L60W-1B30-35-NB-XX-8-BK-UNV-XX-XX-XX	ENTRY CANOPY (SIDE ENTRY)	23 W/m LED	
	LL3b	SELUX LIGHTING M60-L60W-1B30-35-NB-XX-9-BK-UNV-XX-XX-XX	ENTRY CANOPY (REAR ENTRY)	6737 LM/m 3500K	
	LL3c	SELUX LIGHTING M60-L60W-1B30-35-NB-XX-29-BK-UNV-XX-XX-XX	CFD CANOPY (REAR)		

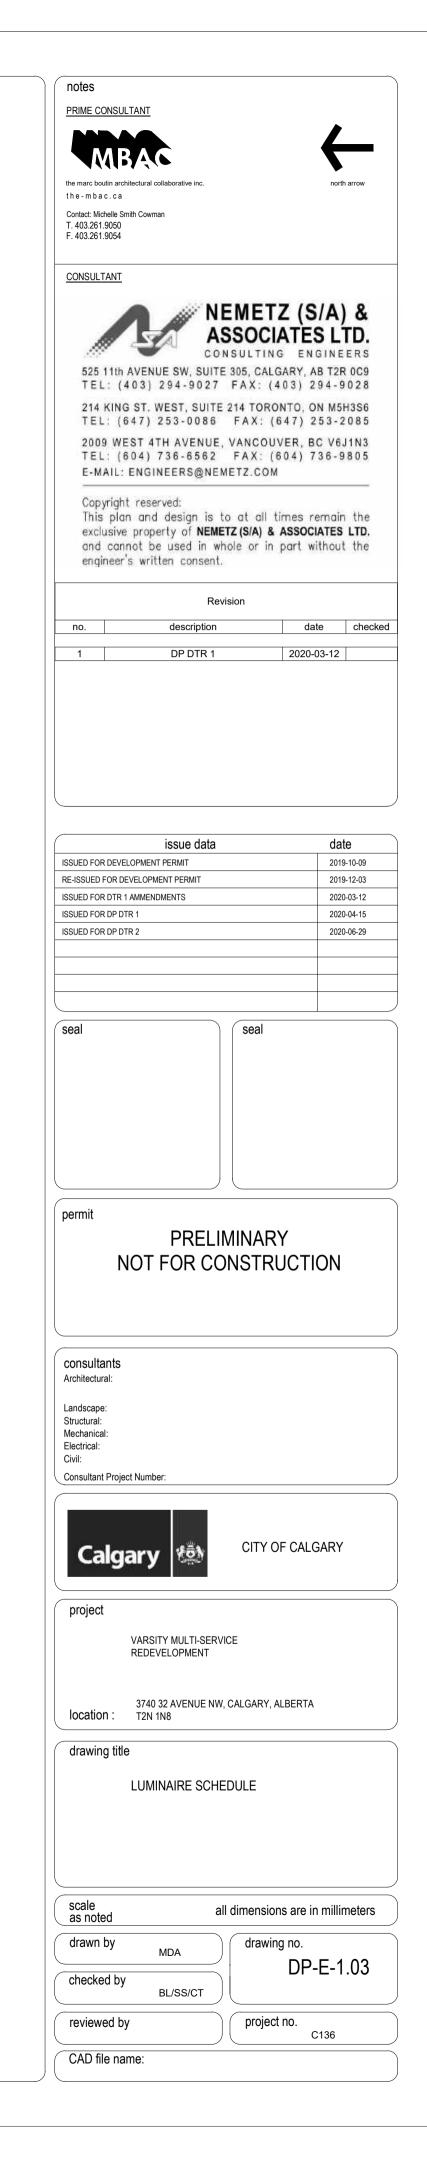

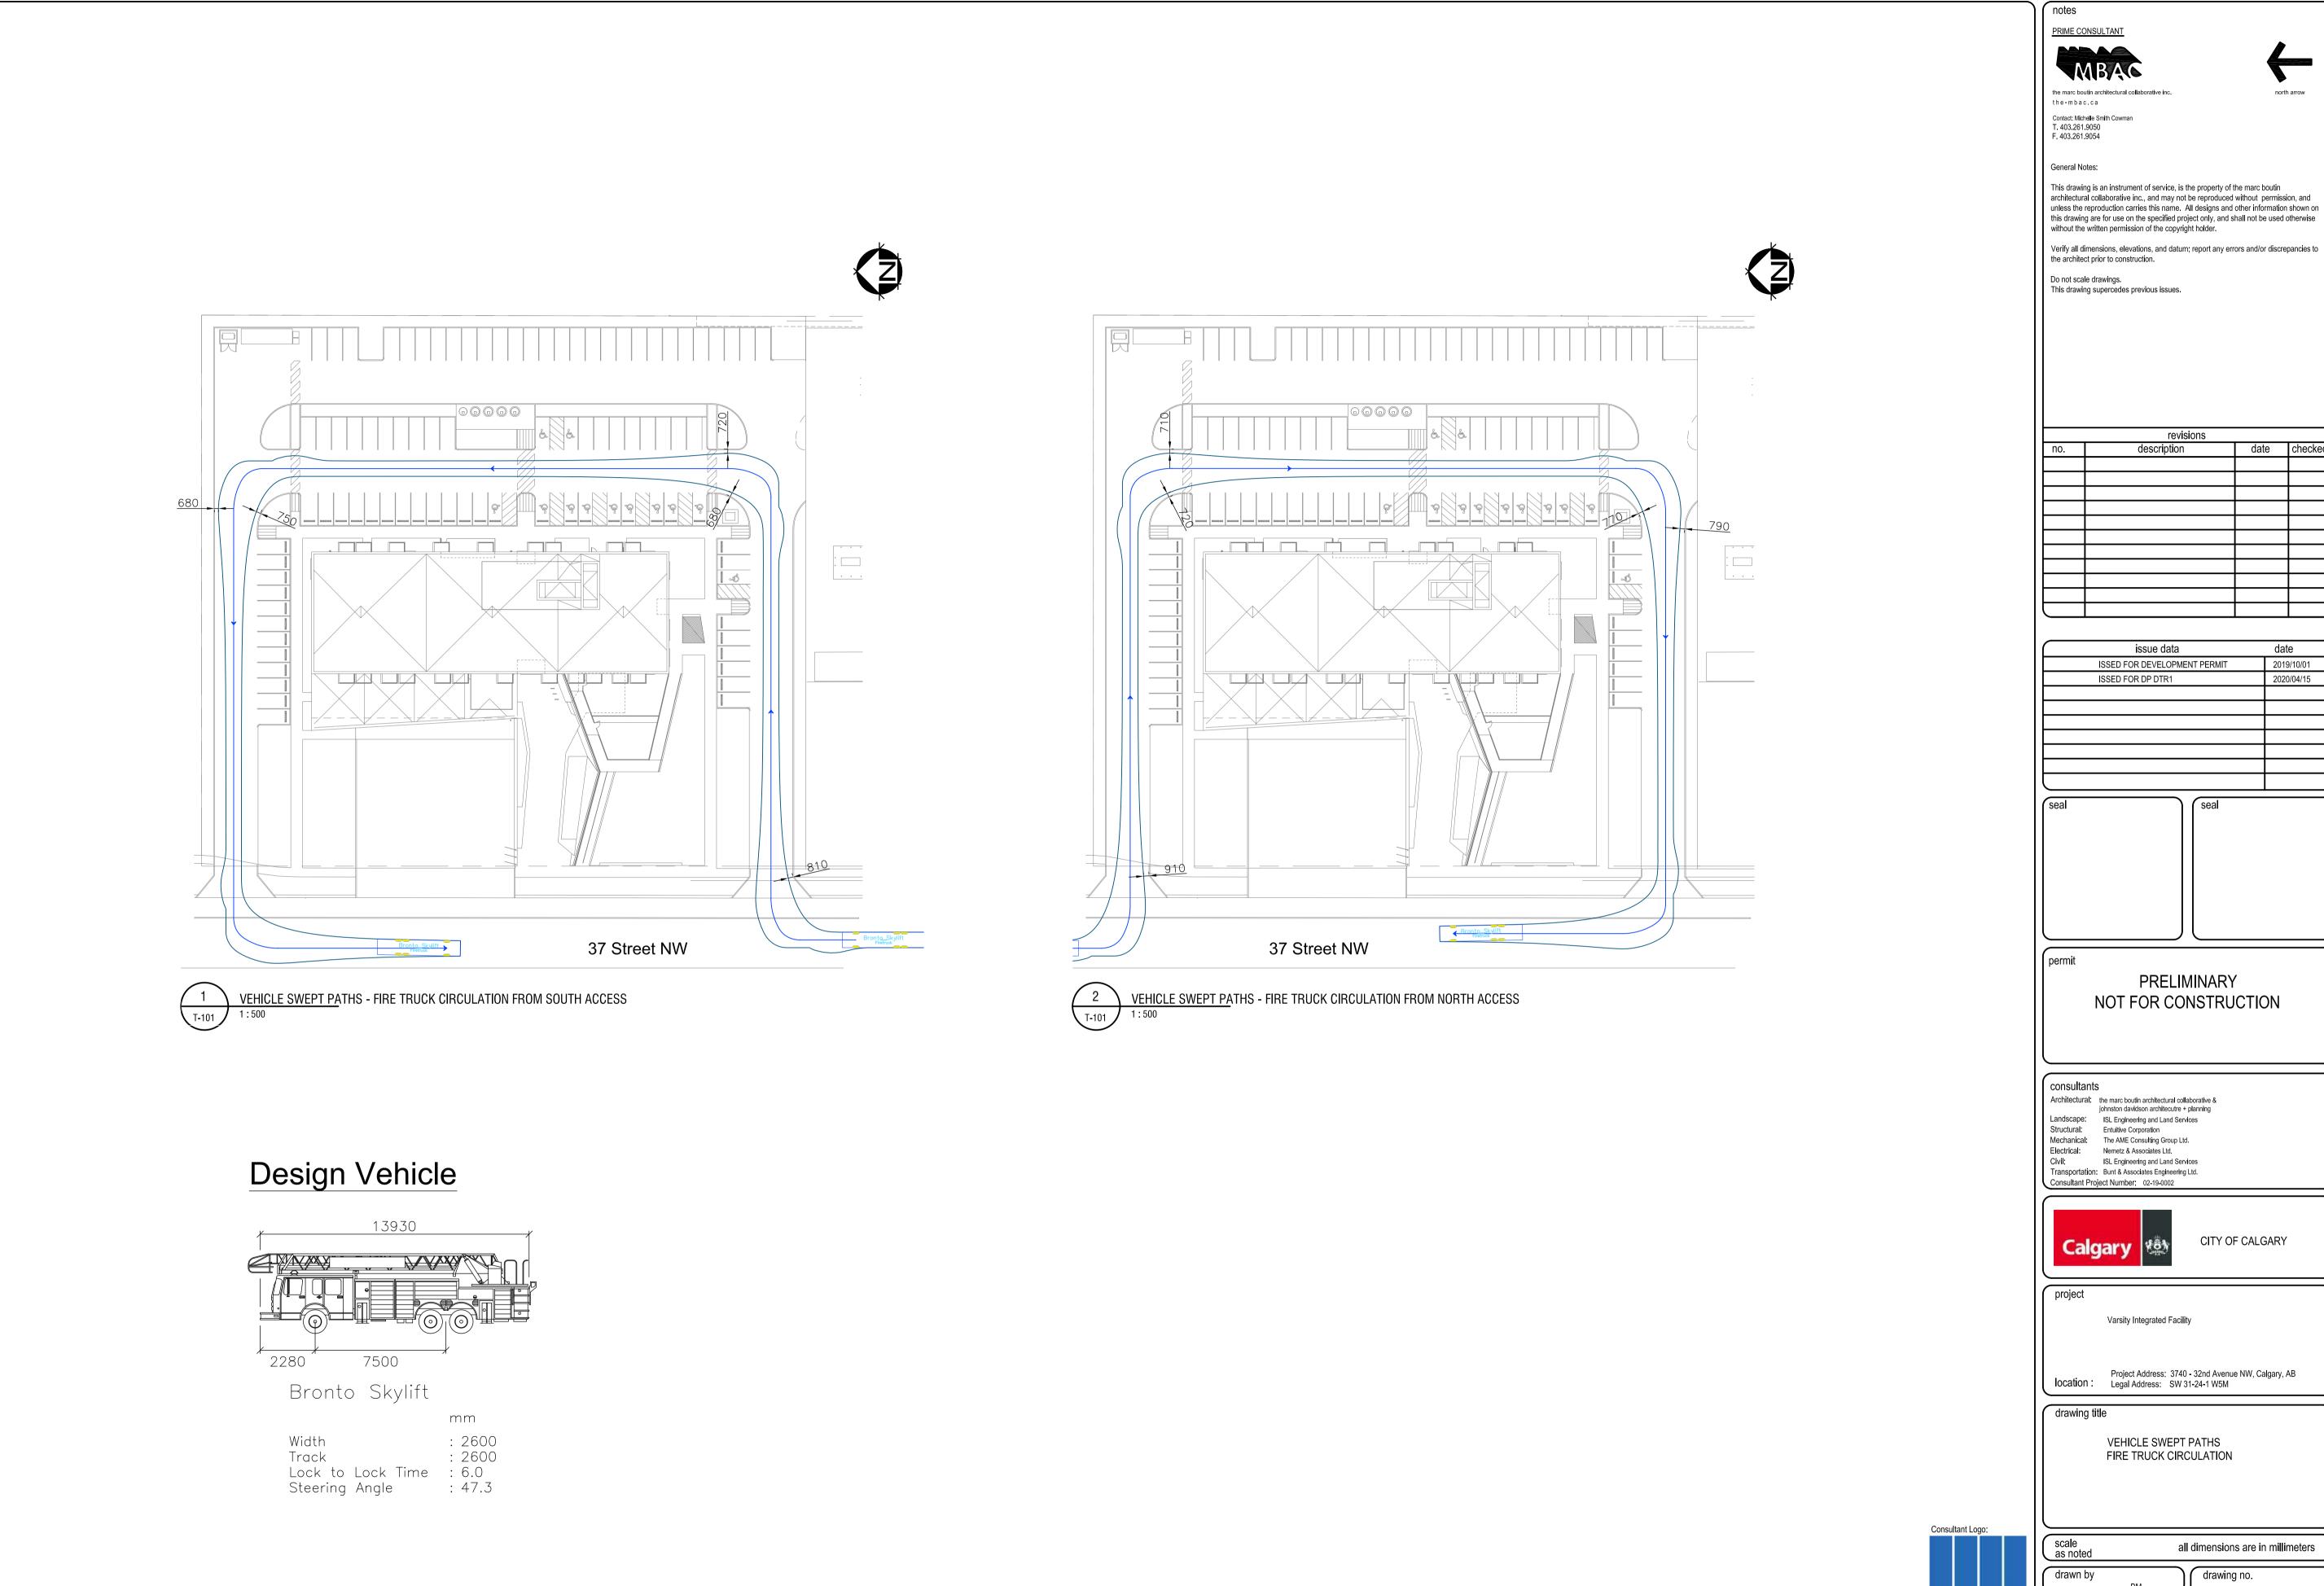

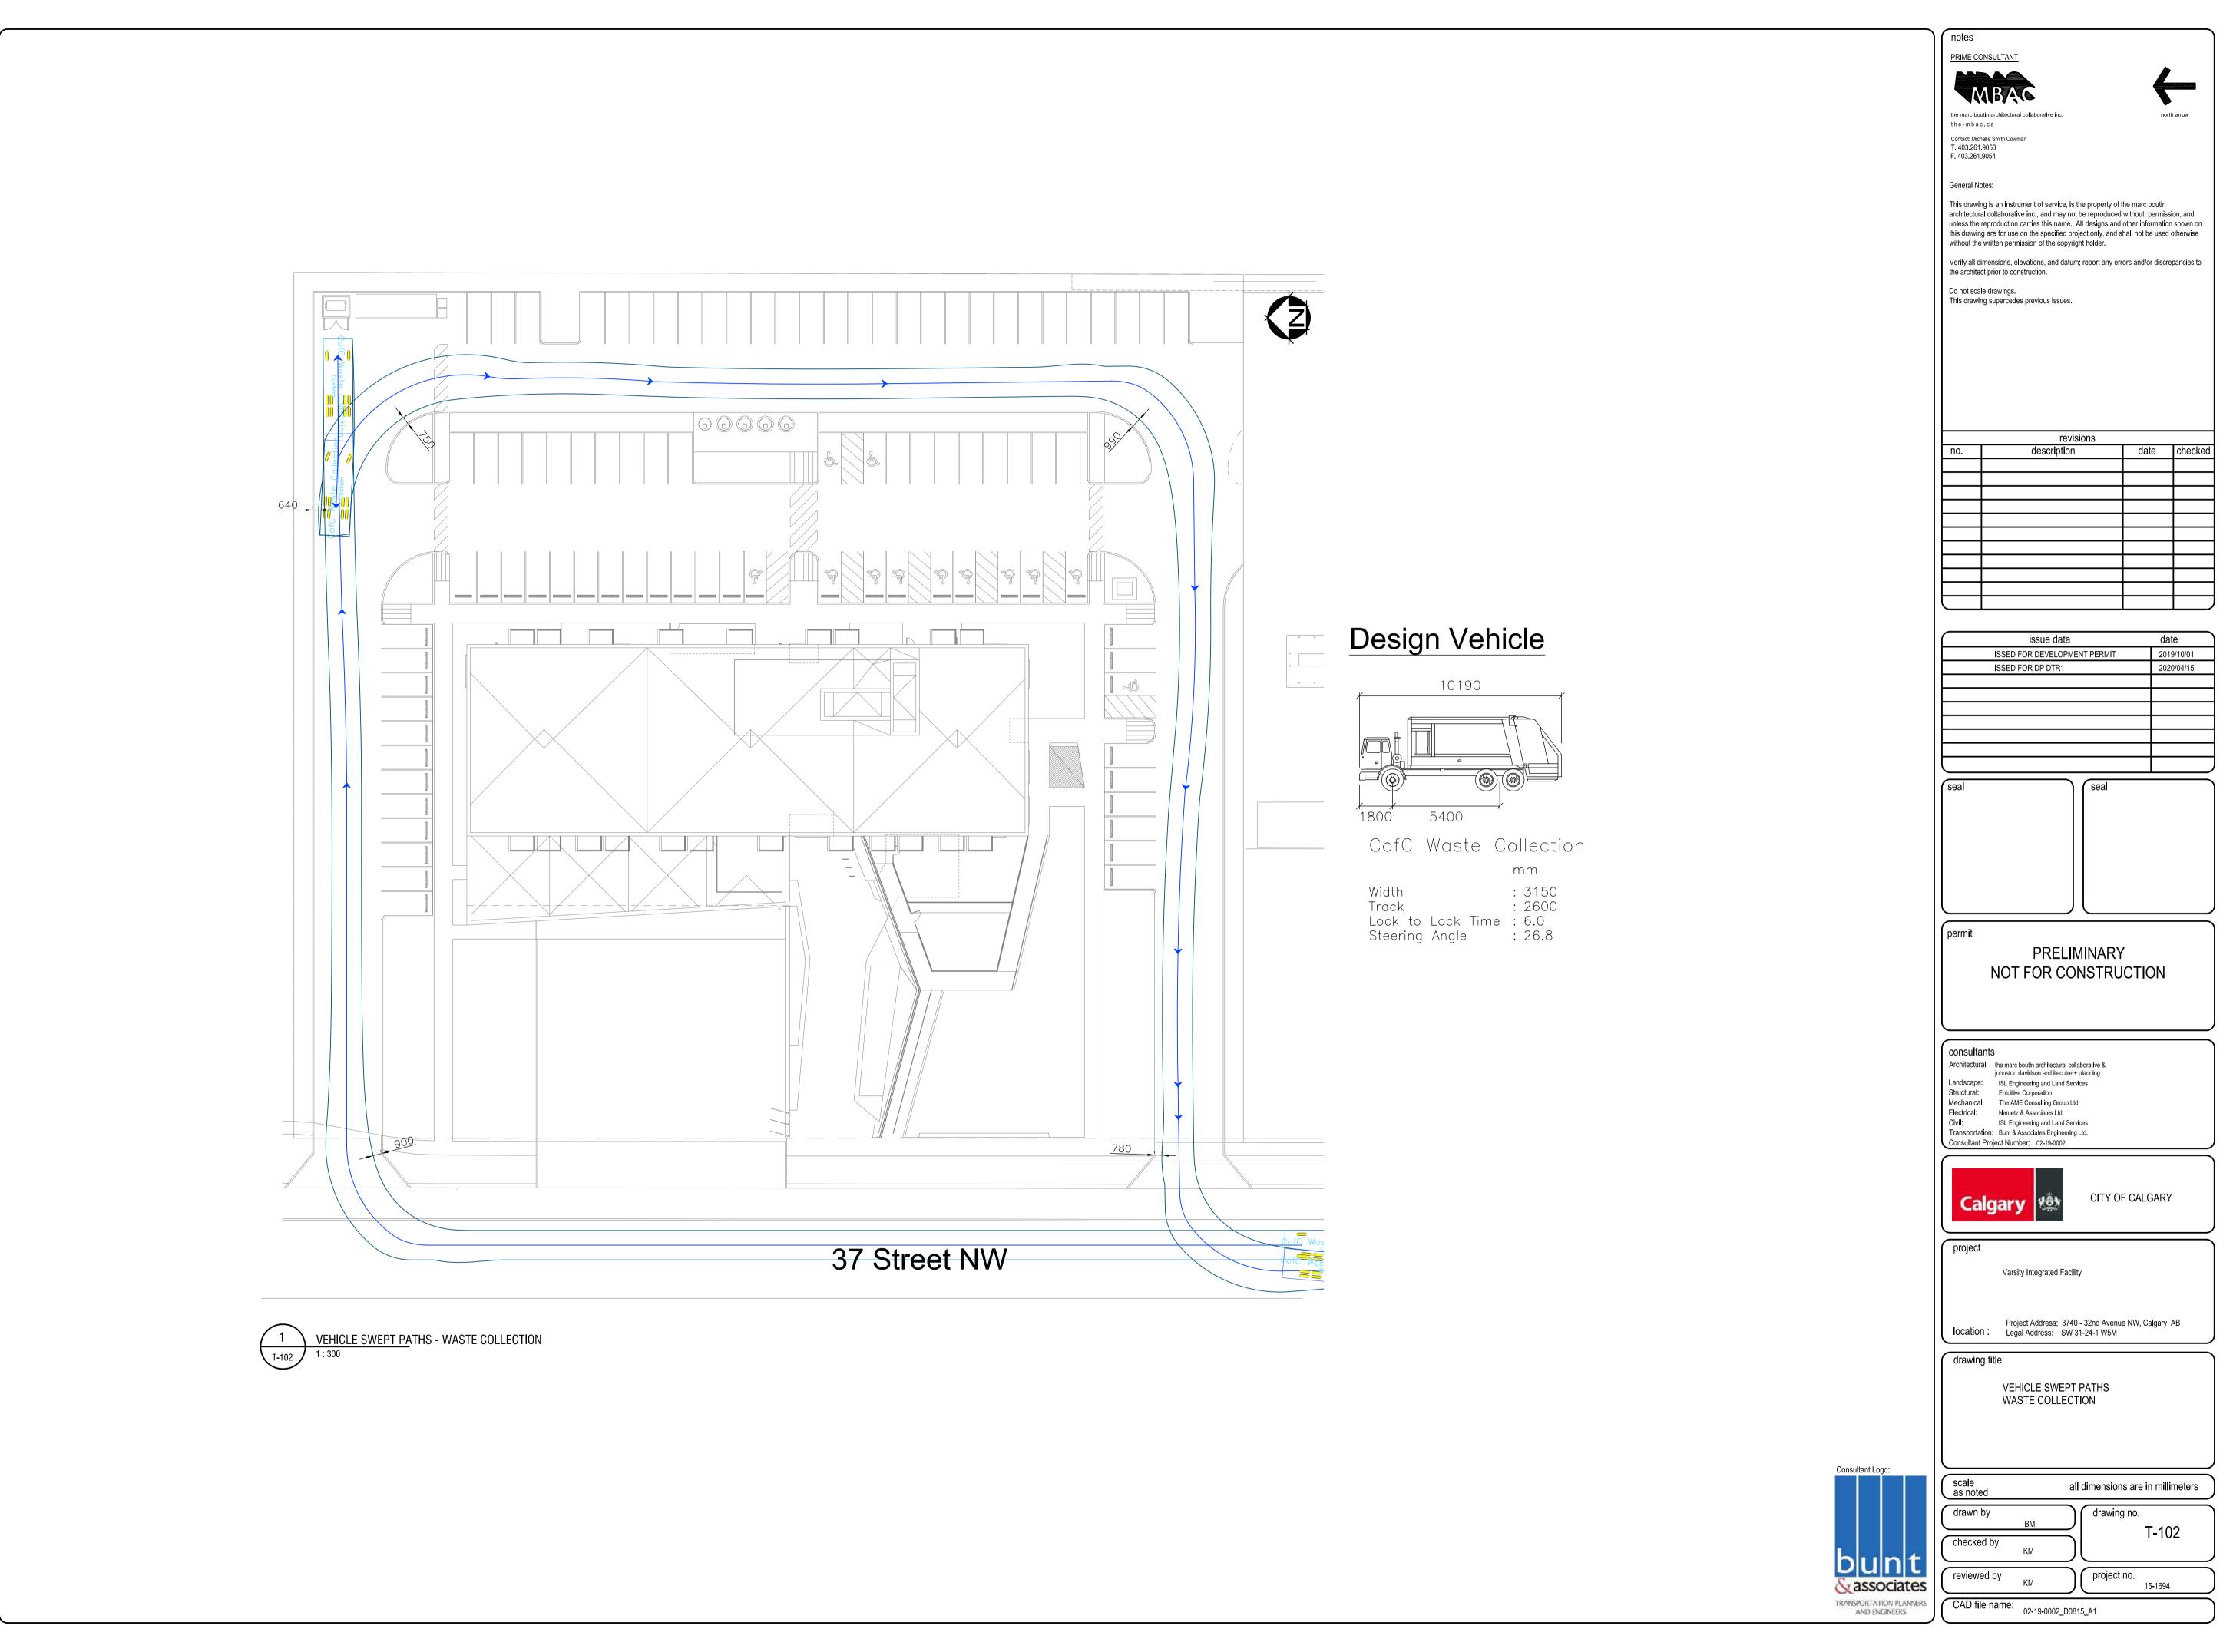

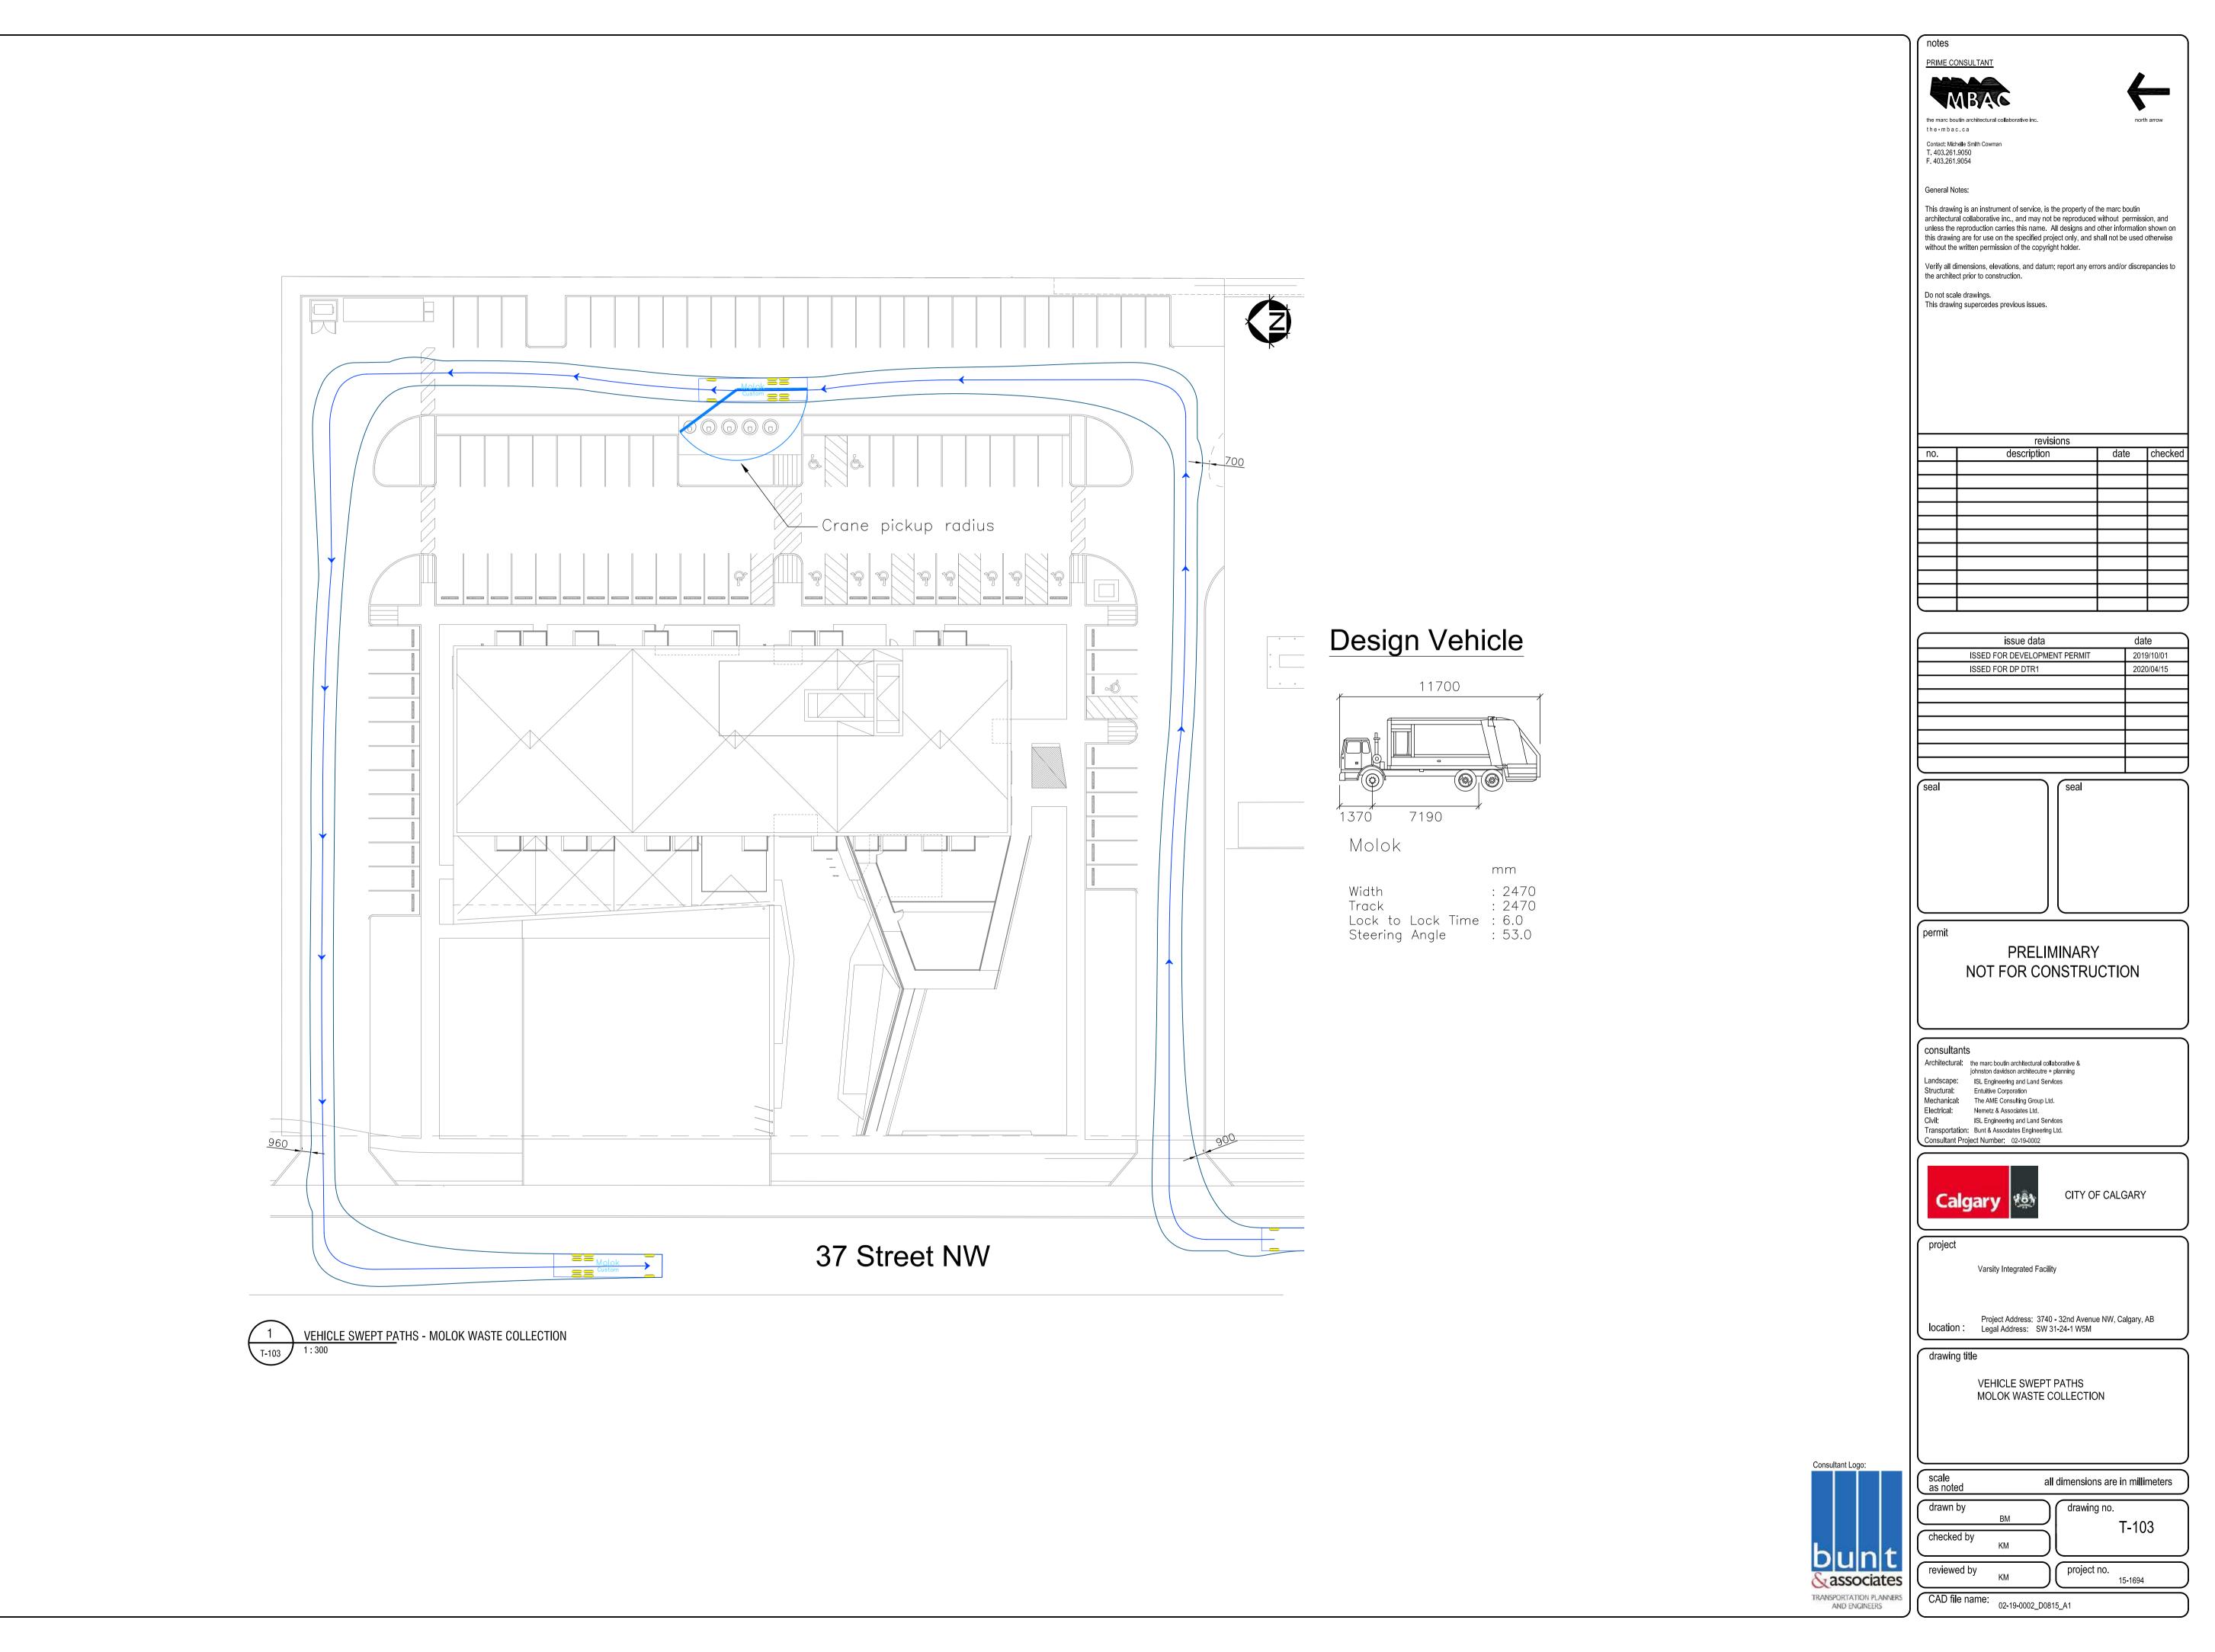

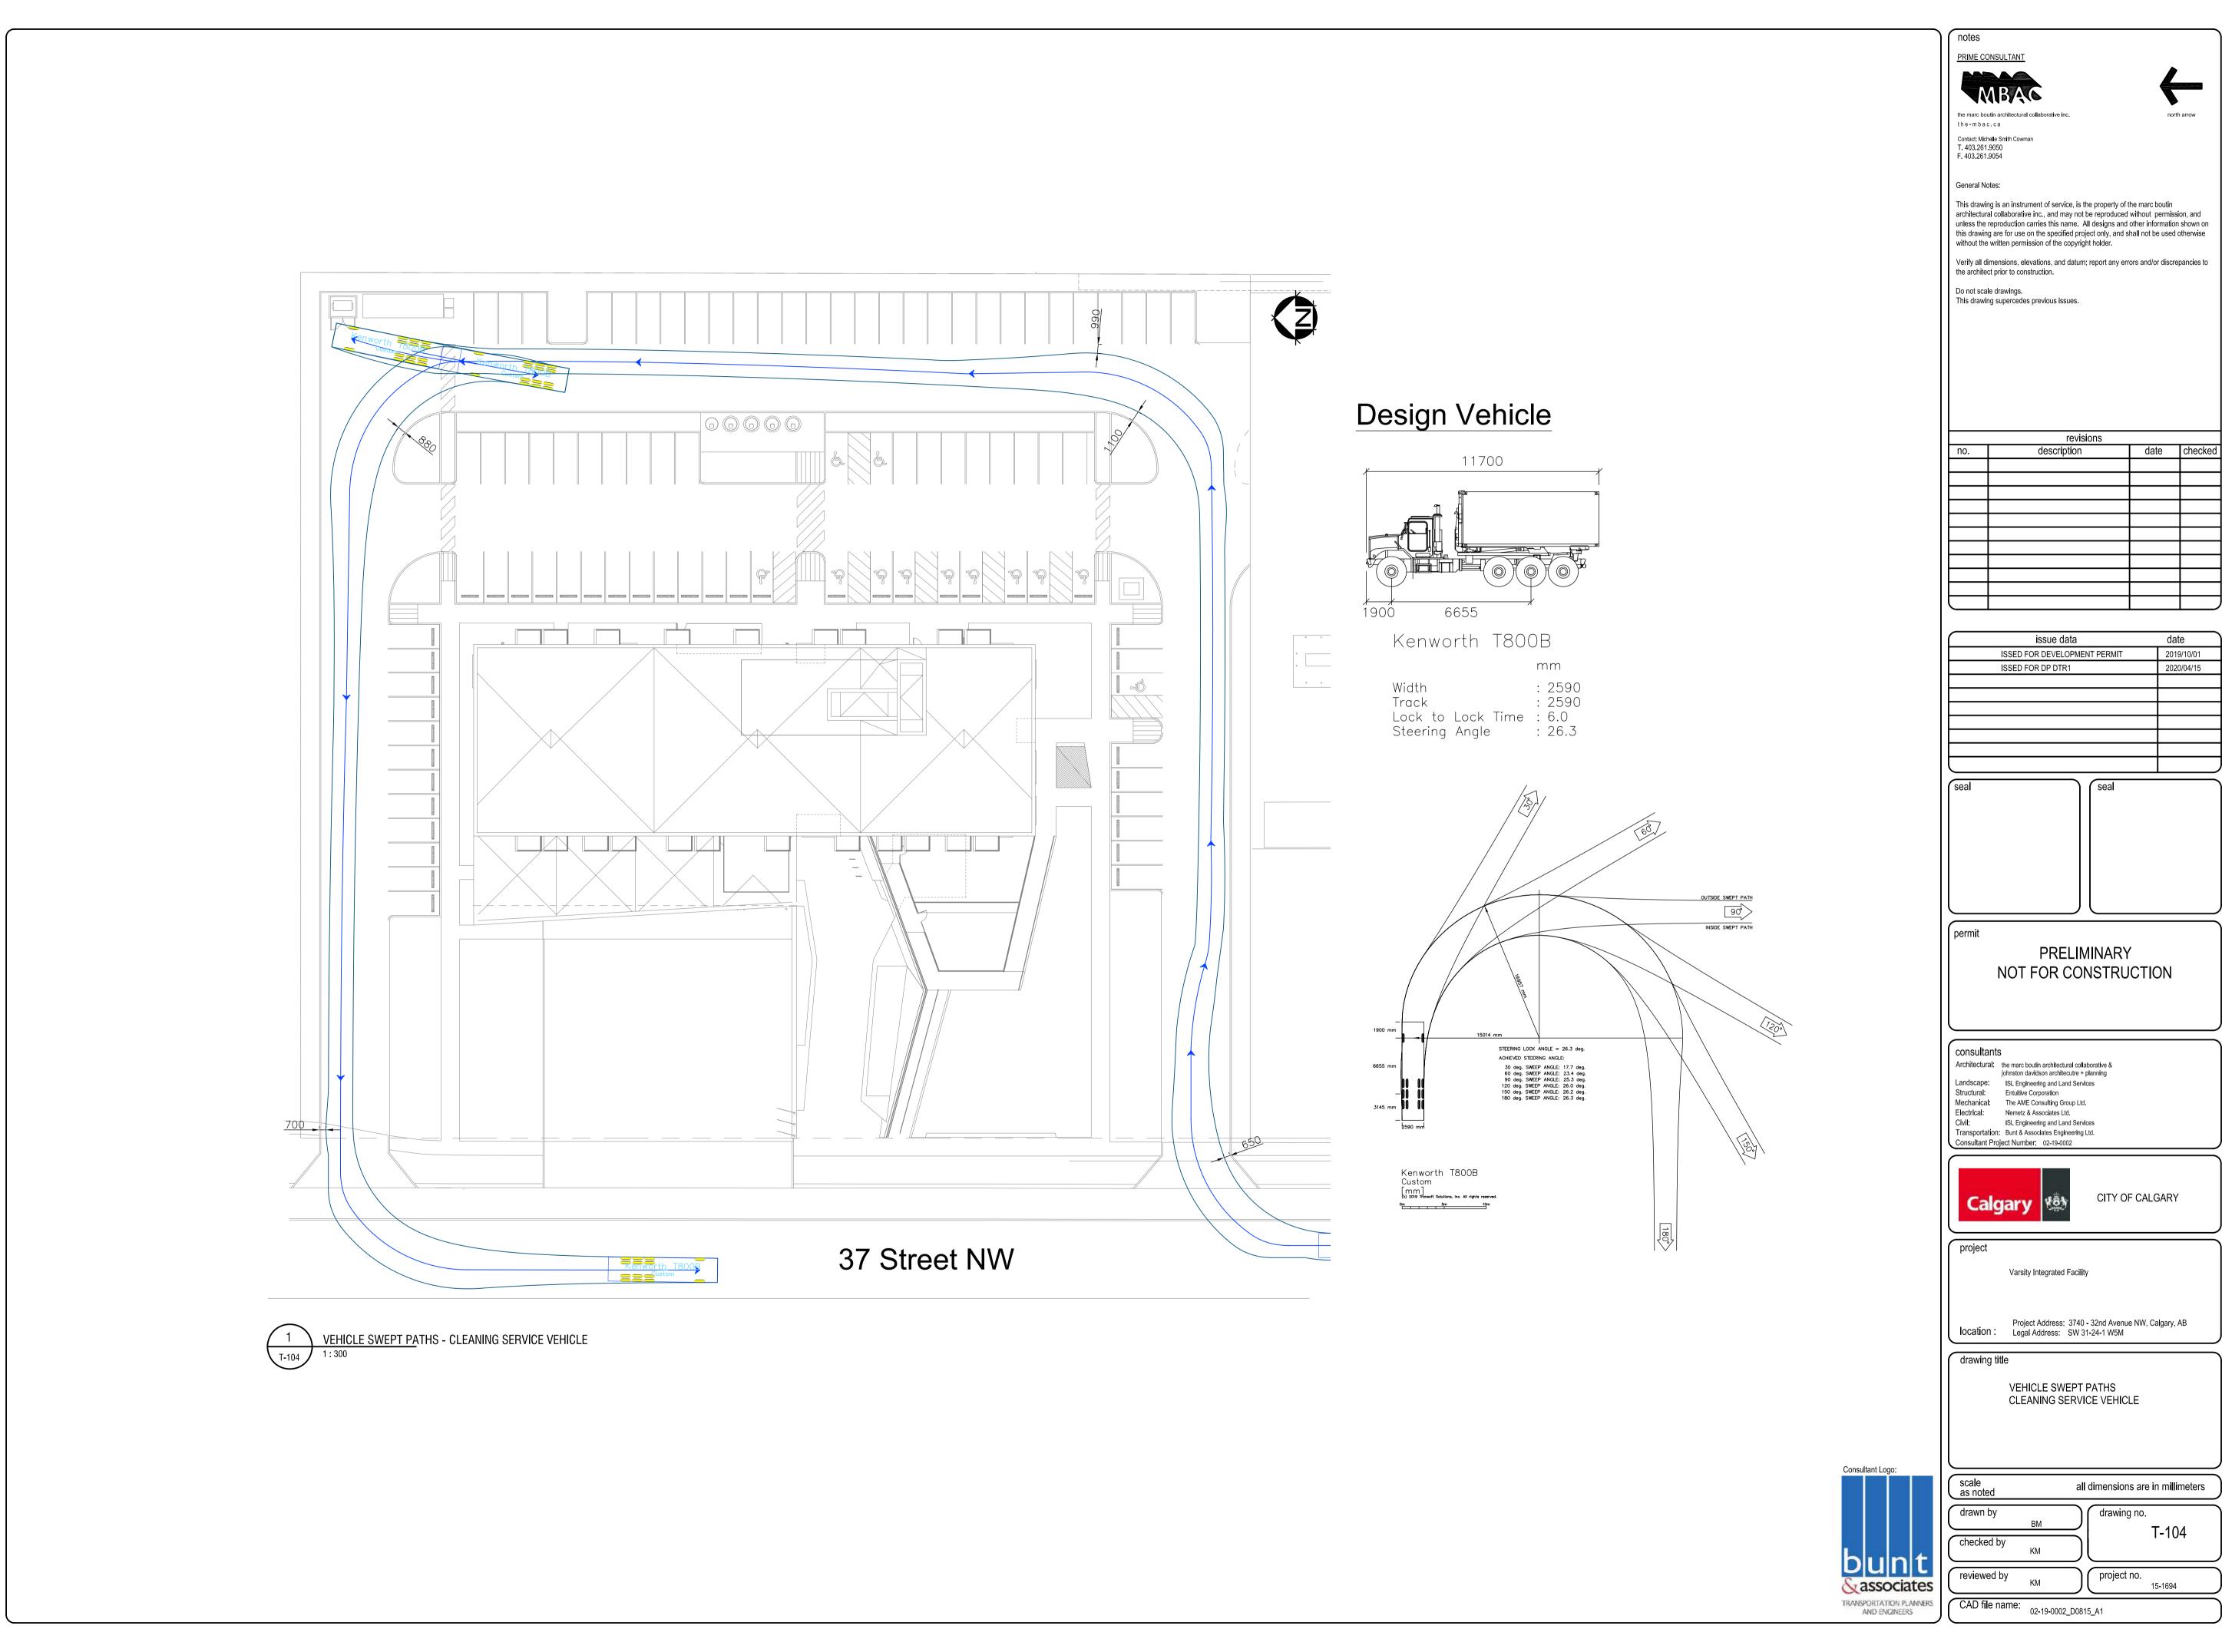

2020/04/15

